



EXISTING SUPERSTRUCTURE (CONCRETE

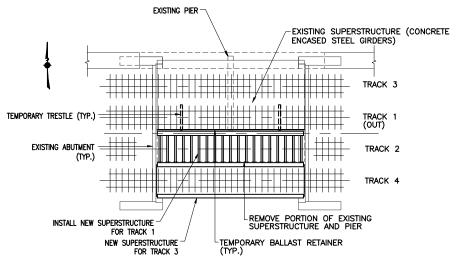


STAGE 2-PLAN
SCALE: 1/16"=1'-0"

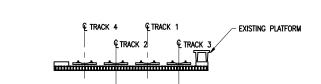


INITIAL CONDITION-PLAN

SCALE: 1/16"=1'-0"


ROADWAY

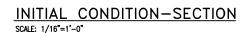


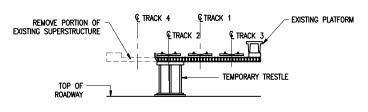

STAGE 1-PLAN

SCALE: 1/16"=1'-0"

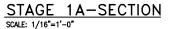

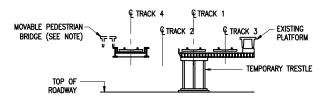

# STAGE 2A-SECTION SCALE: 1/16"=1'-0"

### SEQUENCE OF OPERATIONS


STAGE 1 TAKE TRACK 4 OUT OF SERVICE. INSTALL TEMPORARY TRESTLES ON NEW FOUNDATIONS BENEATH PORTION OF TRACK 2 THAT WILL BE LEFT IN PLACE DURING THIS STAGE.

USING SHIMS, SUPPORT REMAINING BEAMS OF TRACK 2 ON TEMPORARY TRESTLES. INSTALL TEMPORARY BALLAST RETAINER ON TOP OF FIRST REMAINING BEAM. REMOVE EXISTING SUPERSTRUCTURE OF TRACK 4 AS REQUIRED FOR NEW SUPERSTRUCTURE INSTALLATION WITHOUT COMPROMISING TRACK 2 SUPPORT.


REMOVE PORTION OF EXISTING PIER AND ITS FOUNDATION AS REQUIRED. INSTALL TRACK 4 SUPERSTRUCTURE, BALLAST AND TRACK. PLACE TRACK 4 BACK INTO SERVICE.

STAGE 2 TAKE TRACK 2 OUT OF SERVICE. RELOCATE TEMPORARY TRESTLES FROM ITS PRESENT POSITION BELOW TRACK 2 TO THE NEW POSITION BENEATH TRACK 1. USING SHIMS, SUPPORT REMAINING BEAMS OF TRACK 1 ON TEMPORARY TRESTLES. INSTALL TEMPORARY BALLAST RETAINER ON TOP OF FIRST REMAINING BEAM. REMOVE EXISTING SUPERSTRUCTURE OF TRACK 2 AS REQUIRED FOR NEW SUPERSTRUCTURE INSTALLATION WITHOUT COMPROMISING TRACK 1 SUPPORT.

REMOVE PORTION OF EXISTING PIER AND ITS FOUNDATION AS REQUIRED. INSTALL TRACK 2 SUPERSTRUCTURE, BALLAST AND TRACK. PLACE TRACK 2

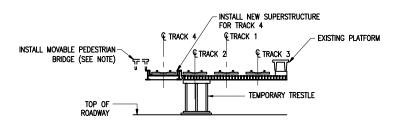

STAGE 1B-SECTION
SCALE: 1/16"=1'-0"

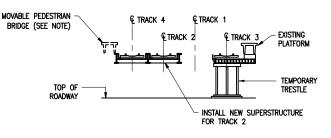



STAGE 2B/3A-SECTION
SCALE: 1/16"=1'-0"


NOTE: MOVABLE PEDESTRIAN BRIDGE SHALL PROVIDE FOR PEDESTRIAN TRAFFIC ALONG THE BRIDGE. USE PRECAST CONCRETE DOUBLE TEE UNIT OUTFITTED WITH RAILING.PEDESTRIAN BRIDGE SHALL BE REMOVED WHEN CONSTRUCTION WORK REQUIRES AND PLACED BACK INTO SERVICE.

AFTER COMPLETION OF BRIDGE WORK, CONNECT PEDESTRIAN BRIDGE PERMANENTLY TO SUPPORT POINTS ON MODIFIED ABUTMENT BACKWALLS AND PROVIDE PERMANENT CONNECTIONS TO EXISTING PLATFORM AT EAST END AND RECONSTRUCTED STRIRGASE AT WEST END.


#### SOUND BEACH AVE.

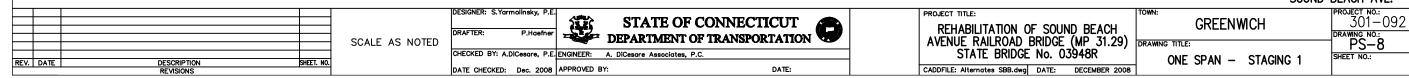

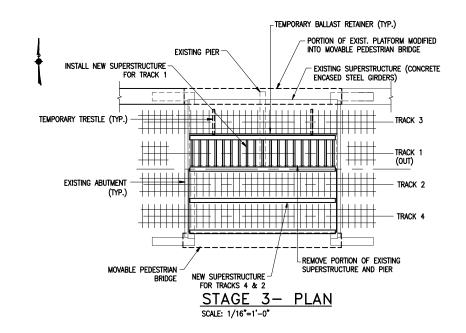


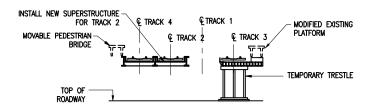


# STAGE 2B/3A-SECTION SCALE: 1/16"=1'-0"

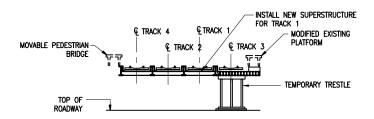

STAGE 3B—SECTION
SCALE: 1/16"=1'-0"

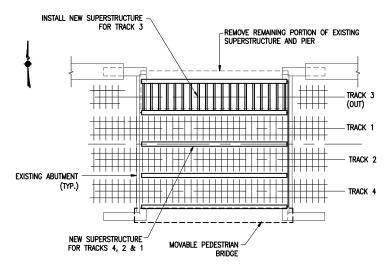

STAGE 4-PLAN
SCALE: 1/16"=1'-0"

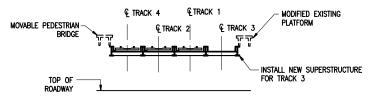

STAGE 4-SECTION
SCALE: 1/16"=1'-0"

#### SEQUENCE OF OPERATIONS


STAGE 3 TAKE TRACK 1 OUT OF SERVICE. RELOCATE TEMPORARY TRESTLES FROM ITS PRESENT POSITION TO THE NEW POSITION BENEATH TRACK 3. USING SHIMS, SUPPORT REMAINING BEAMS OF TRACK 3 ON TEMPORARY TRESTLES. INSTALL TEMPORARY BALLAST RETAINER ON TOP OF FIRST REMAINING BEAM. REMOVE EXISTING SUPERSTRUCTURE OF TRACK 1 AS REQUIRED FOR NEW SUPERSTRUCTURE INSTALLATION WITHOUT COMPROMISING TRACK 3 SUPPORT.


REMOVE PORTION OF EXISTING PIER AND ITS FOUNDATION AS REQUIRED. INSTALL TRACK 1 NEW SUPERSTRUCTURE, BALLAST AND TRACK. PLACE TRACK 1 BACK INTO SERVICE. MODIFY EXISTING PLATFORM INTO MOVABLE PEDESTRIAN BRIDGE SIMILAR TO ONE USED ON SOUTH SIDE OF BRIDGE.

STAGE 4 TAKE TRACK 3 OUT OF SERVICE. REMOVE EXISTING SUPERSTRUCTURE AND EXISTING PIER. INSTALL TRACK 3 NEW SUPERSTRUCTURE, BALLAST AND TRACK. PLACE TRACK 3 BACK INTO SERVICE.

CONNECT PEDESTRIAN BRIDGES ON BOTH SIDES OF RAILROAD BRIDGE PERMANENTLY TO SUPPORT POINTS ON MODIFIED ABUTMENT BACKWALLS AND CONNECT THEM PERMANENTLY TO EXISTING PLATFORMS AND STAIRCASES.


COMPLETE ROADWAY WORK UNDER THE BRIDGE.

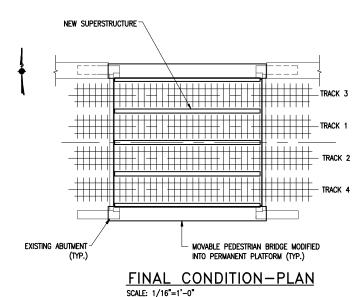


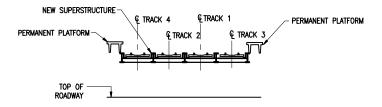



FINAL CONDITION—SECTION
SCALE: 1/16"=1'-0"

SOUND BEACH AVE.

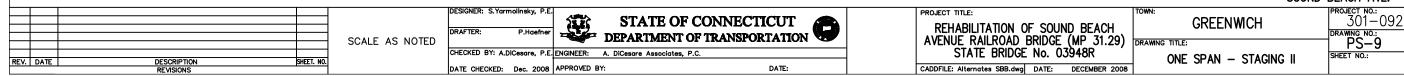

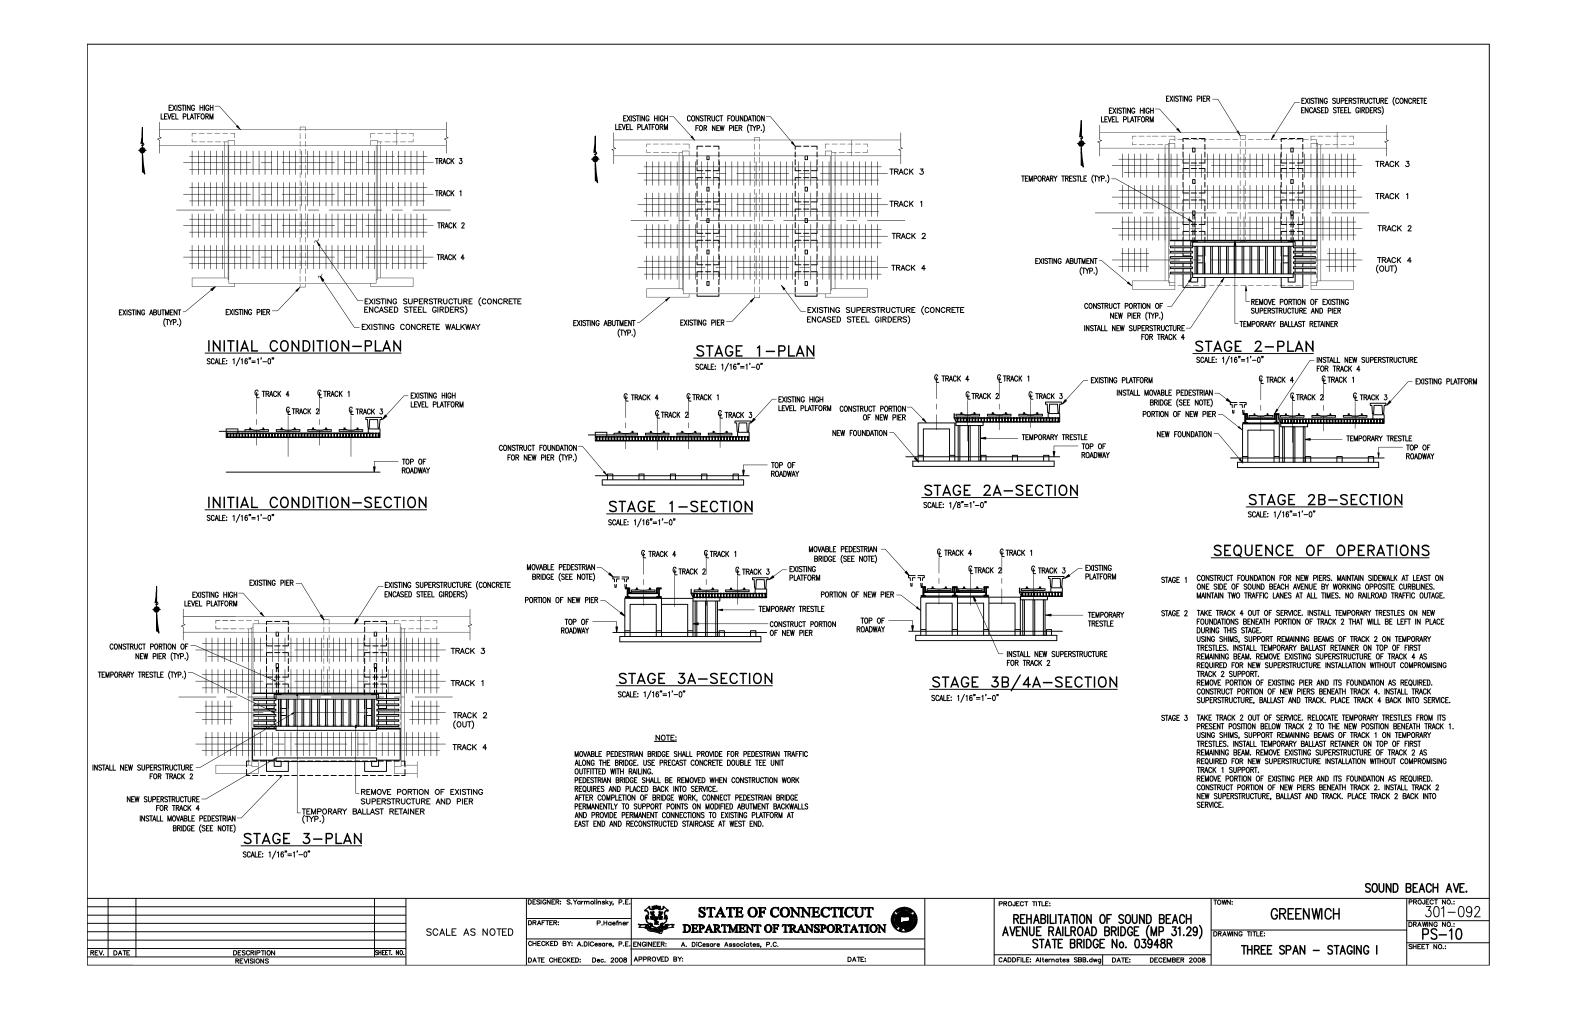


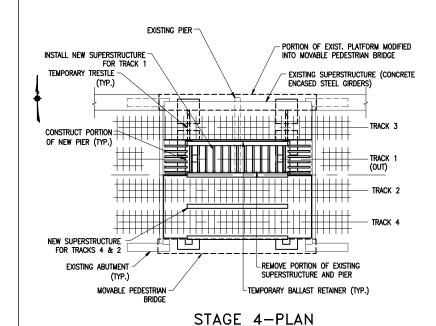

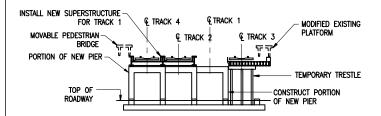



SCALE: 1/16"=1'-0"

### STAGE 3B/4A-SECTION SCALE: 1/16"=1'-0"

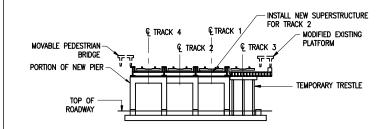

STAGE 4B-SECTION SCALE: 1/16"=1'-0"

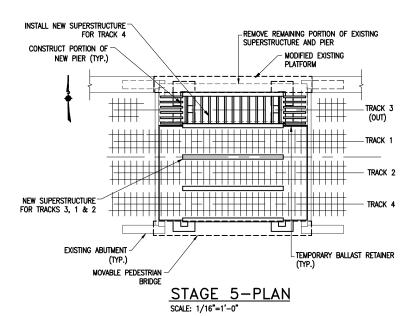

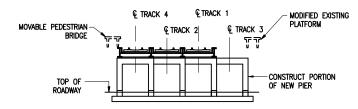

## STAGE 5-SECTION

#### SEQUENCE OF OPERATIONS (CONTINUATION)


STAGE 4 TAKE TRACK 1 OUT OF SERVICE. RELOCATE TEMPORARY TRESTLES FROM ITS PRESENT POSITION TO THE NEW POSITION BENEATH TRACK 3. USING SHIMS, SUPPORT REMAINING BEAMS OF TRACK 3 ON TEMPORARY TRESTLES. INSTALL TEMPORARY BALLAST RETAINER ON TOP OF FIRST REMAINING BEAM. REMOVE EXISTING SUPERSTRUCTURE OF TRACK 1 AS REQUIRED FOR NEW SUPERSTRUCTURE INSTALLATION WITHOUT COMPROMISING REMOVE PORTION OF EXISTING PIER AND ITS FOUNDATION AS REQUIRED.

CONSTRUCT PORTION OF NEW PIERS BENEATH TRACK 1. INSTALL TRACK 1 NEW SUPERSTRUCTURE, BALLAST AND TRACK, PLACE TRACK 1 BACK INTO SERVICE. MODIFY EXISTING PLATFORM INTO MOVABLE PEDESTRIAN BRIDGE SIMILAR TO ONE USED ON SOUTH SIDE OF BRIDGE.


STAGE 5 TAKE TRACK 3 OUT OF SERVICE. REMOVE EXISTING SUPERSTRUCTURE AND EXISTING PIER. CONSTRUCT REMAINING PORTION OF NEW PIERS. INSTALL TRACK 3 NEW SUPERSTRUCTURE, BALLAST AND TRACK. PLACE TRACK 3 BACK INTO SERVICE.

CONNECT PEDESTRIAN BRIDGES ON BOTH SIDES OF RAILROAD BRIDGE
PERMANENTLY TO SUPPORT POINTS ON MODIFIED ABUTMENT BACKWALLS AND
CONNECT THEM PERMANENTLY TO EXISTING PLATFORMS AND STAIRCASES.

COMPLETE ROADWAY WORK UNDER THE BRIDGE.

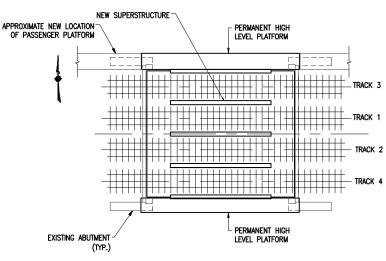


#### FINAL CONDITION-PLAN SCALE: 1/16"=1'-0"

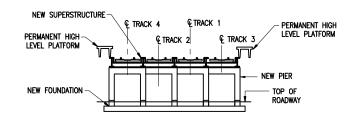

FINAL CONDITION-SECTION SCALE: 1/16"=1'-0"

SOUND BEACH AVE.

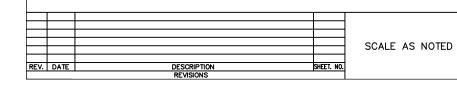

DATE CHECKED: Dec. 2008 APPROVED BY:



STATE OF CONNECTICUT DEPARTMENT OF TRANSPORTATION


DATE:

REHABILITATION OF SOUND BEACH AVENUE RAILROAD BRIDGE (MP 31.29) DRAWING TITLE: STATE BRIDGE No. 03948R CADDFILE: Alternates SBB.dwg DATE: DECEMBER 2008


PROJECT TITLE:


301-092 **GREENWICH** PS-11 SHEET NO.: THREE SPAN - STAGING II

CHECKED BY: A.DiCesare, P.E. ENGINEER: A. DiCesare Associates, P.C.

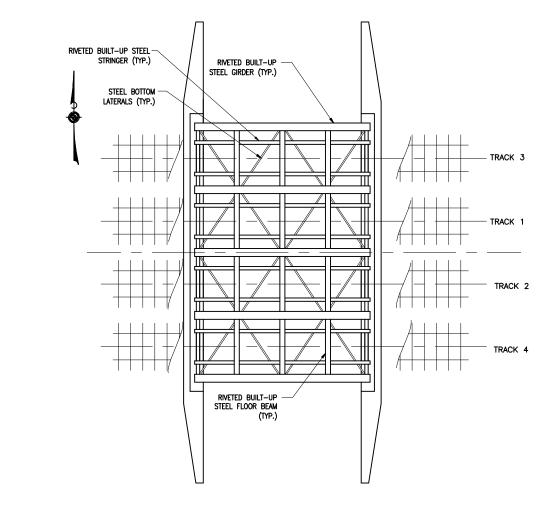


## SCHEMATIC FRAMING PLAN

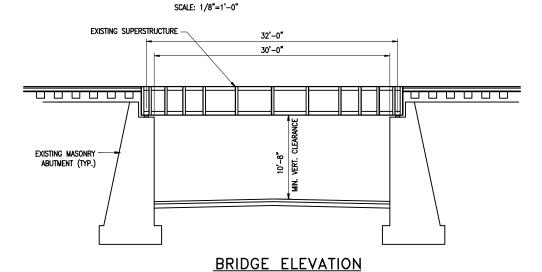


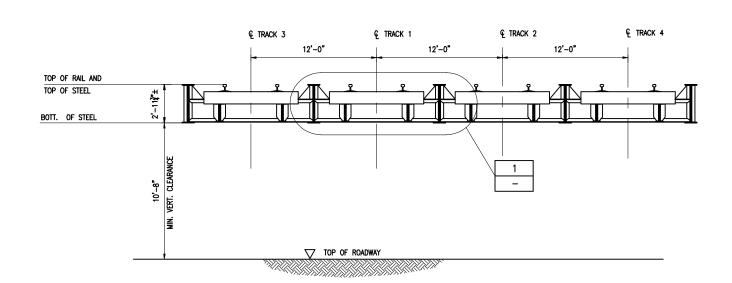



TYPICAL SECTION
SCALE: 1/4"=1'-0"

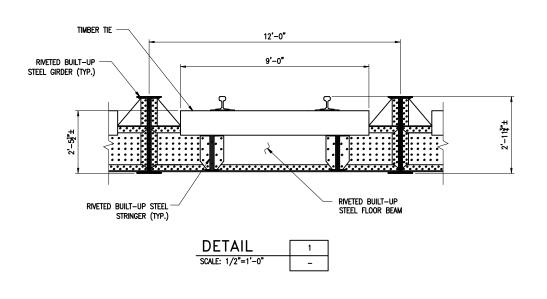


TOMAC AVENUE

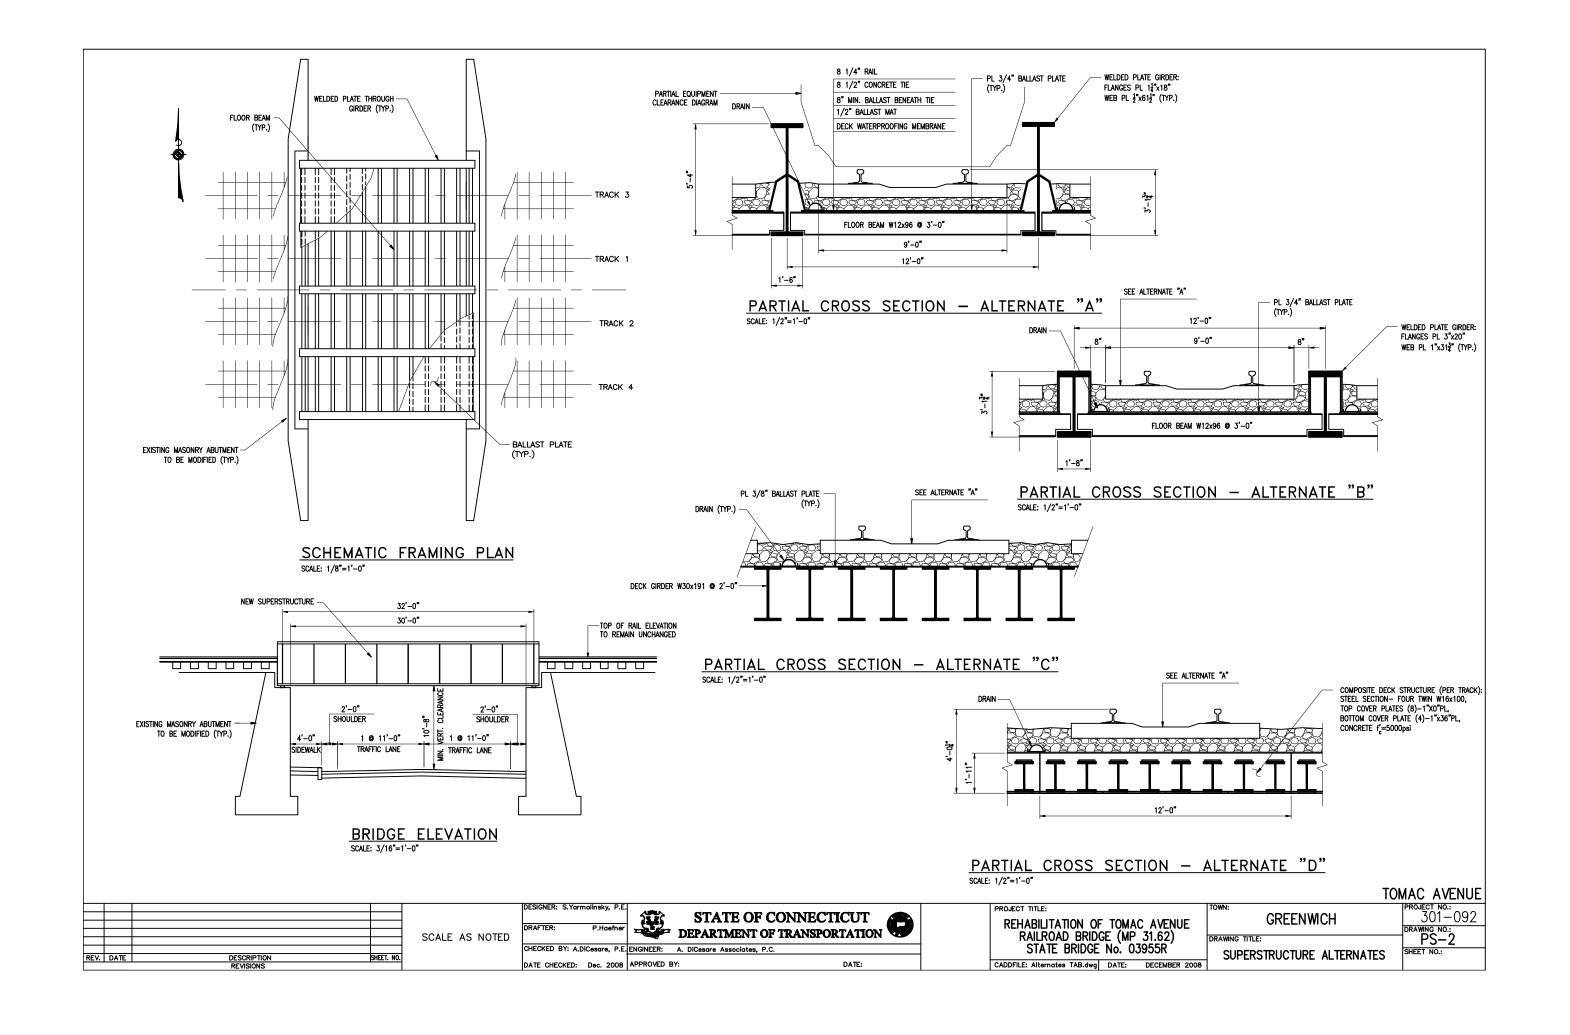

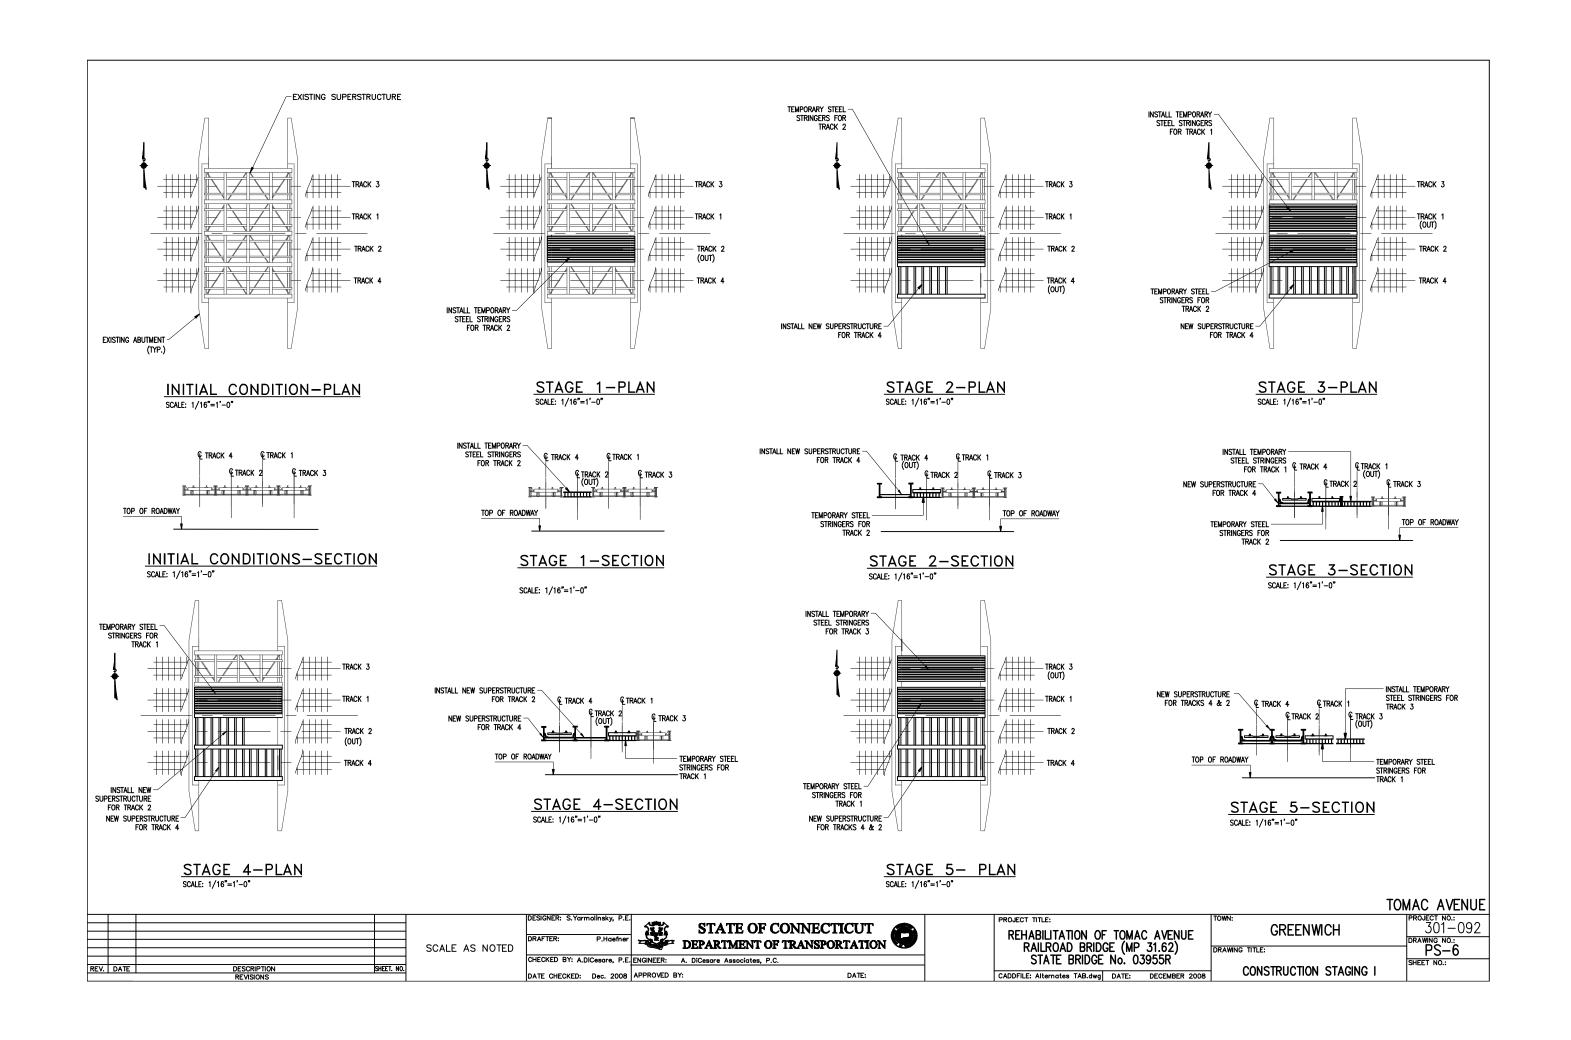


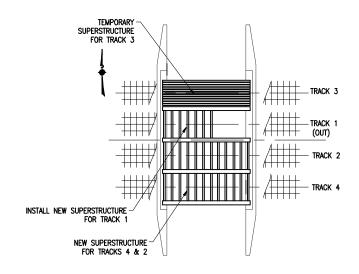


# STAGE 6- PLAN

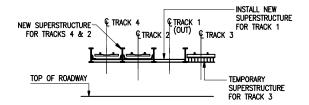


#### STAGE 6-SECTION SCALE: 1/16"=1'-0"

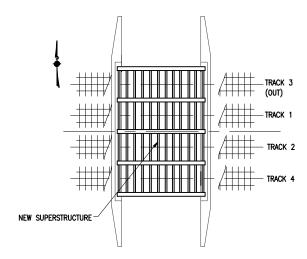


FINAL CONDITIONS 6- PLAN

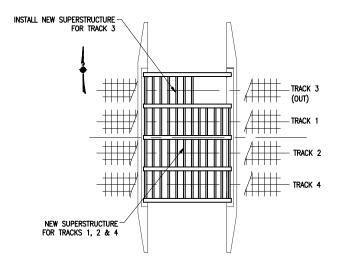

#### STAGE 7- PLAN SCALE: 1/16"=1'-0"

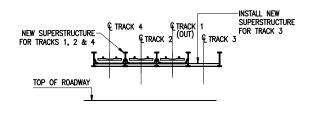

STAGE 7-SECTION SCALE: 1/16"=1'-0"

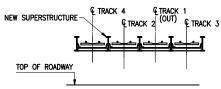

### SEQUENCE OF OPERATIONS

- STAGE 1 TAKE TRACK 2 OUT OF SERVICE. REMOVE EXISTING SUPERSTRUCTURE EXCEPT FOR GIRDERS.
  INSTALL TEMPORARY SUPERSTRUCTURE (STEEL ROLLED BEAMS AS REQUIRED TO PROVIDE SUPPORT FOR TRACK AND SPACE FOR NEW STRUCTURE INSTALLATION ON ADJACENT TRACKS).
  INSTALL TIES AND RAILS, USE TIMBER TIES LONG ENOUGH TO COVER ALL TEMPORARY STRINGERS, YET LEAVING SPACE FOR NEW SUPERSTRUCTURE INSTALLATION ON TRACK 4. PLACE TRACK 2 INTO SERVICE.
- STAGE 2 TAKE TRACK 4 OUT OF SERVICE. REMOVE EXISTING TRACK 4 SUPERSTRUCTURE INCLUDING GIRDERS. INSTALL TRACK 4 NEW SUPERSTRUCTURE, BALLAST AND TRACK. PLACE TRACK 4 INTO SERVICE.
- STAGE 3 TAKE TRACK 1 OUT OF SERVICE. REMOVE EXISTING SUPERSTRUCTURE EXCEPT FOR GIRDER BETWEEN TRACKS 1 AND 3. INSTALL TEMPORARY SUPERSTRUCTURE (STEEL ROLLED BEAMS AS REQUIRED TO PROVIDE SUPPORT FOR TRACK AND SPACE FOR NEW STRUCTURE INSTALLATION ON ADJACENT TRACKS).
  INSTALL TIES AND RAILS, USE TIMBER TIES LONG ENOUGH TO COVER ALL TEMPORARY
  STRINGERS, YET LEAVING SPACE FOR NEW SUPERSTRUCTURE INSTALLATION ON TRACK 2.
  - PLACE TRACK 1 INTO SERVICE.
- STAGE 4 TAKE TRACK 2 OUT OF SERVICE AGAIN. REMOVE TEMPORARY STRINGERS INSTALLED DURING STAGE 1. INSTALL TRACK 2 NEW SUPERSTRUCTURE, BALLAST AND TRACK. PLACE TRACK 2 INTO SERVICE.
- STAGE 5 TAKE TRACK 3 OUT OF SERVICE. REMOVE EXISTING SUPERSTRUCTURE. INSTALL TEMPORARY SUPERSTRUCTURE (STEEL ROLLED BEAMS AS REQUIRED TO PROVIDE SUPPORT FOR TRACK AND SPACE FOR NEW STRUCTURE INSTALLATION ON ADJACENT TRACKS).
  INSTALL TIES AND RAILS, USE TIMBER TIES LONG ENOUGH TO COVER ALL TEMPORARY CONTROLLED. PLACE TRACK 3 INTO SERVICE.
- STAGE 6 TAKE TRACK 1 OUT OF SERVICE AGAIN. REMOVE TEMPORARY STRINGERS INSTALLED DURING STAGE 3. INSTALL TRACK 1 NEW SUPERSTRUCTURE, BALLAST AND TRACK. PLACE TRACK 1 INTO SERVICE.
- STAGE 7 TAKE TRACK 3 OUT OF SERVICE AGAIN. REMOVE TEMPORARY STRINGERS INSTALLED DURING STAGE 5. INSTALL TRACK 3 NEW SUPERSTRUCTURE, BALLAST AND TRACK. PLACE TRACK 3 INTO SERVICE.



TOMAC AVENUE PROJECT TITLE: 301-092 DEPARTMENT OF TRANSPORTATION

A. DICEsare Associates C.C. STATE OF CONNECTICUT **GREENWICH** REHABILITATION OF TOMAC AVENUE PS-7 RAILROAD BRIDGE (MP 31.62) SCALE AS NOTED DRAWING TITLE: CHECKED BY: A.DiCesare, P.E. ENGINEER: A. DiCesare Associates, P.C. STATE BRIDGE No. 03955R SHEET NO .: REV. DATE SHEET. NO. CONSTRUCTION STAGING II DATE CHECKED: Dec. 2008 APPROVED BY: DATE: CADDFILE: Alternates TAB.dwg DATE: DECEMBER 2008