
STATE OF CONNECTICUT

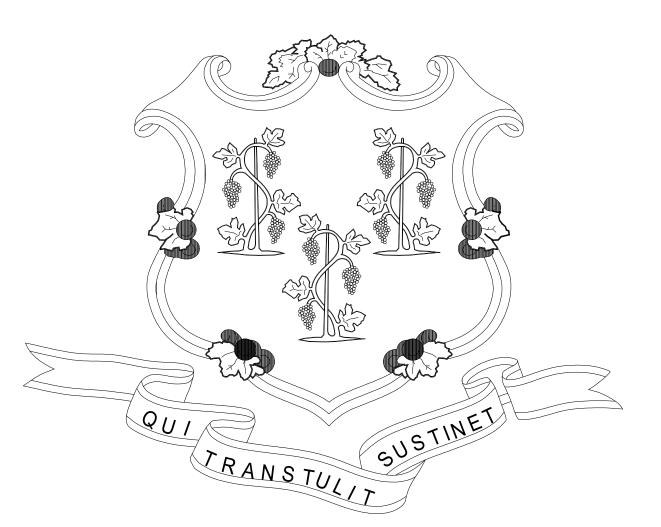



M. JODI RELL GOVERNOR

DEPARTMENT OF TRANSPORTATION

JOSEPH F. MARIE

COMMISSIONER

IMPROVEMENTS TO 424 CHAPEL STREET
PHASE ONE
NEW HAVEN, CONNECTICUT

ARCHITECT OF RECORD

AMENTA / EMMA ARCHITECTS, P.C. 201 ANN STREET HARTFORD, CT 06103 860.549.4725

MEP ENGINEER

LEGNOS & CRAMER. 70 INWOOD ROAD ROCKY HILL, CT 06067 860.509.5797

BID SET SUBMISSION - 12.18.2009

CONTRACT DRAWINGS

G0.0 COVER SHE

G1.0 CODE INFORMATION, EGRESS PLAN

GENERAL NOTES AND LEGENDS

.0 DEMOLITION PLAN

CONSTRUCTION PLAN, ENLARGED PLAN DETAILS, I

A3.0 REFLECTED CEILING PL
A4.0 PROJECT SPECIFICATION
A4.1 REPORT SPECIFICATION

E0.0 ELECTRICAL SYMBOL LIST, FIXTURE SCHEDULE, PANEL

ED1.0 ELECTRICAL DEMOLITION PLAN
E1.0 ELECTRICAL LIGHTING PLAN
E2.0 ELECTRICAL POWER PLAN
FP1.0 FIRE PROTECTION 2ND FLOOR PLAN

Grand total:





APPROVALS

DA

DATE

CODE TO WHICH THIS PROJECT WAS DESIGNED 2003 INTERNATIONAL BUILDING CODE CONNECTICUT SUPPLEMENT / AMENDMENT 2009 INTERNATIONAL FIRE CODE 2003 2005 CONNECTICUT SUPPLEMENT / AMENDMENT ICC / ANSI A117.1-2003 2003 28 CFR PART 36, DEPARTMENT OF JUSTICE ADA GUIDELINES 1994

OVERALL GROSS BUILDING AREA (IBC-503)							
FLOORS	BUILDING PART	EXISTING	NEW	TOTAL			
FIRST FLOOR	ENTIRE FLOOR	22,976 sq ft	N/A	22,976 sq ft			
FIRST FLOOR							
OFOOND FLOOD	OPEN OFFICE #100	2,885 sq ft	N/A	2,885 sq ft			
SECOND FLOOR	OPEN OFFICE #101	1,801 sq ft	N/A	1,801 sq ft			
	BALANCE OF FLOOR AREA	18,290 sq ft	N/A	18,290 sq ft			
TOTAL :				45,952 sq ft			

OCCUPANCY LOAD

	Number of Occupants Per	Actual Room	Occupant Load	
Room Name	Square Foot	Area	Calculated	Occupant Load
2nd Floor				
CONTRACT GROUP 'B' AREA 1	100 SF	1500 SF	15	15
CONTRACT GROUP 'B' AREA 2	100 SF	1385 SF	14	14
CONTRACT GROUP 'E'	100 SF	1800 SF	18	18
EXISTING CONFERENCE	100 SF	530 SF	5	6
ROOM				
EXISTING CORRIDOR		5784 SF		
EXISTING OPEN OFFICE AREA	100 SF	1413 SF	14	15

SECTION NO.	DESCRIPTION			
304.0	CHAPTER 3 - USE OR OCCUPANCY B = BUSINESS GROUP CONTRACT GROUP 'B' AREA 1, CONTRACT GROUP 'E'.	ACT GROUP 'B' AREA 2,		CHAPTER 8 - INTERIOR FINISHES CLASS II INTERIOR FINISHES (MIN)
	CHAPTER 4 - SPECIAL USE AND OCCUPANCY CHAPTER 5 - GENERAL BUILDING LIMITATIONS		901.2	CHAPTER 9 - FIRE PROTECTION SYSTEMS SUPRESSION SYSTEM
T-601	CHAPTER 6 - TYPES OF CONSTRUCTION CONSTRUCTION TYPE, MINIMUM REQUIRED - 2B, ASSUMMED - 2B FIRE-RESISTANCE RATING REQUIREMENTS FOR BUILDING ELEMENTS (HRS) STRUCTURAL FRAME/COLUMNS, GIRDERS, TRUSSES BEARING WALLS INTERIOR EXTERIOR NONBEARING WALLS AND PARTITIONS - EXTERIOR NONBEARING WALLS AND PARTITIONS - INTERIOR	0 HR(S) 0 HR(S) 0 HR(S) 0 HR(S) 0 HR(S)	906 1004 T-1005.1	PORTABLE FIRE EXTINGUISHERS: PROVIDE ABC TYPE, 75' TRAVEL DISTANCE CHAPTER 10 - MEANS OF EGRESS DESIGNED OCCUPANT LOAD 68 - 2 EXITS REQUIRE EGRESS WIDTH PER OCCUPANT SERVED (INCHES PER OCCUPANT) DOOR AND CORRIDOR CAPACITY
	FLOOR CONSTRUCTION-INCL. SUPPORTING BEAMS AND JOINTS ROOF CONSTRUCTION-INCL. SUPPORTING BEAMS AND JOISTS EXIT ACCESS CORRIDORS ENCLOSURES OF EXITS CHAPTER 7 - FIRE RESISTANT MATERIALS & CONSTRUCTION SHAFT ENCLOSURES	0 HR(S) 0 HR(S) 1 HR(S) 1 HR(S)	T-1014.1	SPACES WITH ONE MEANS OF EGRESS NO - 2 EXITS REQUIRI

CODE INFORMATION SCALE: NTS

			THE INFORMATION, INCLUDING ESTIMATED QUANTITIES OF WORK, SHOWN ON THESE SHEETS IS BASED ON LIMITED INVESTIGATIONS BY THE STATE AND IS IN NO WAY WARRANTED TO INDICATE THE CONDITIONS OF ACTUAL QUANTITIES OF WORK WHICH WILL BE REQUIRED.
REV. DATE	REVISION DESCRIPTION	SHEET NO.	Plotted Date: 12/18/2009 12:58:34

DESIGNER/DRAFTER: CHECKED BY: **SCALE AS NOTED**

STATE OF CONNECTICUT DEPARTMENT OF TRANSPORTATION Filename: C:\Users\CDL\Documents\424 Chapel_POST COMMENTS-CENTRAL_CDL.rvt

SIGNATURE/ BLOCK: OFFICE OF ENGINEERING AMENTA/EMMA

ARCHITECTS, P.C.

IMPROVEMENTS TO 424 CHAPEL STREET PHASE ONE

- EXISTING EGRESS STAIR

PROJECT NO. **NEW HAVEN** DRAWING NO. CODE INFORMATION, EGRESS PLAN G1.0

ASSEMBLY WITHOUT FIXED SEATS -

ASSEMBLY WITHOUT FIXED SEATS -


CONCENTRATED (CHAIRS ONLY)

ASSEMBLY WITH FIXED SEATS

EDUCATIONAL AREAS - CLASSROOM

BUSINESS AREAS

UNCONCENTRATED (TABLES & CHAIRS)

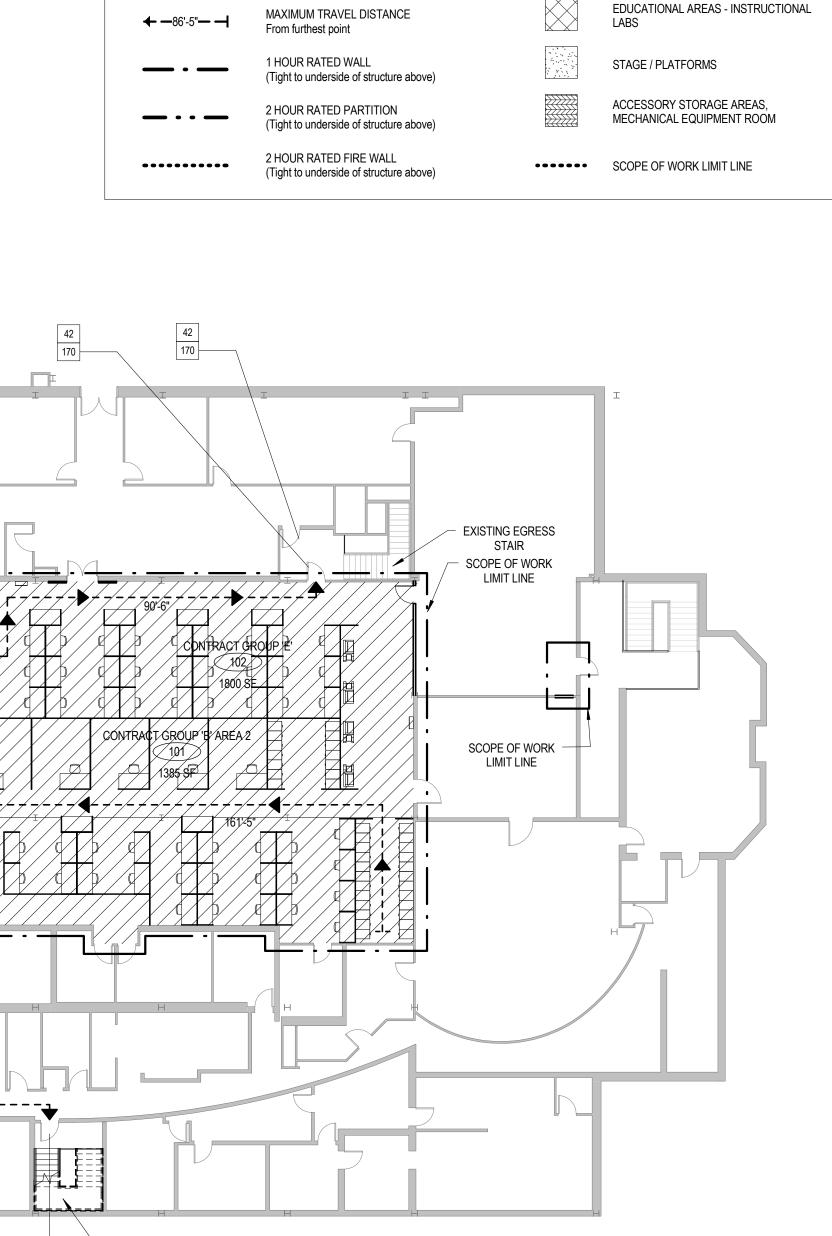

ROOM TAG

Room name

Room number

OCCUPANT LOAD

EXIT CAPACITY

Room area in square feet

ACCESSIBLE ELEMENT

DIRECTION OF TRAVEL With accumulated occupant load

 Actual occupant load of element Maximum allowable occupant load


Occupant load factor

ROOM 202A

355/20 = 18 P

72

2 SECOND FLOOR CODE COMPLIANCE PLAN SCALE: 1/16" = 1'-0" PROJECT TITLE:

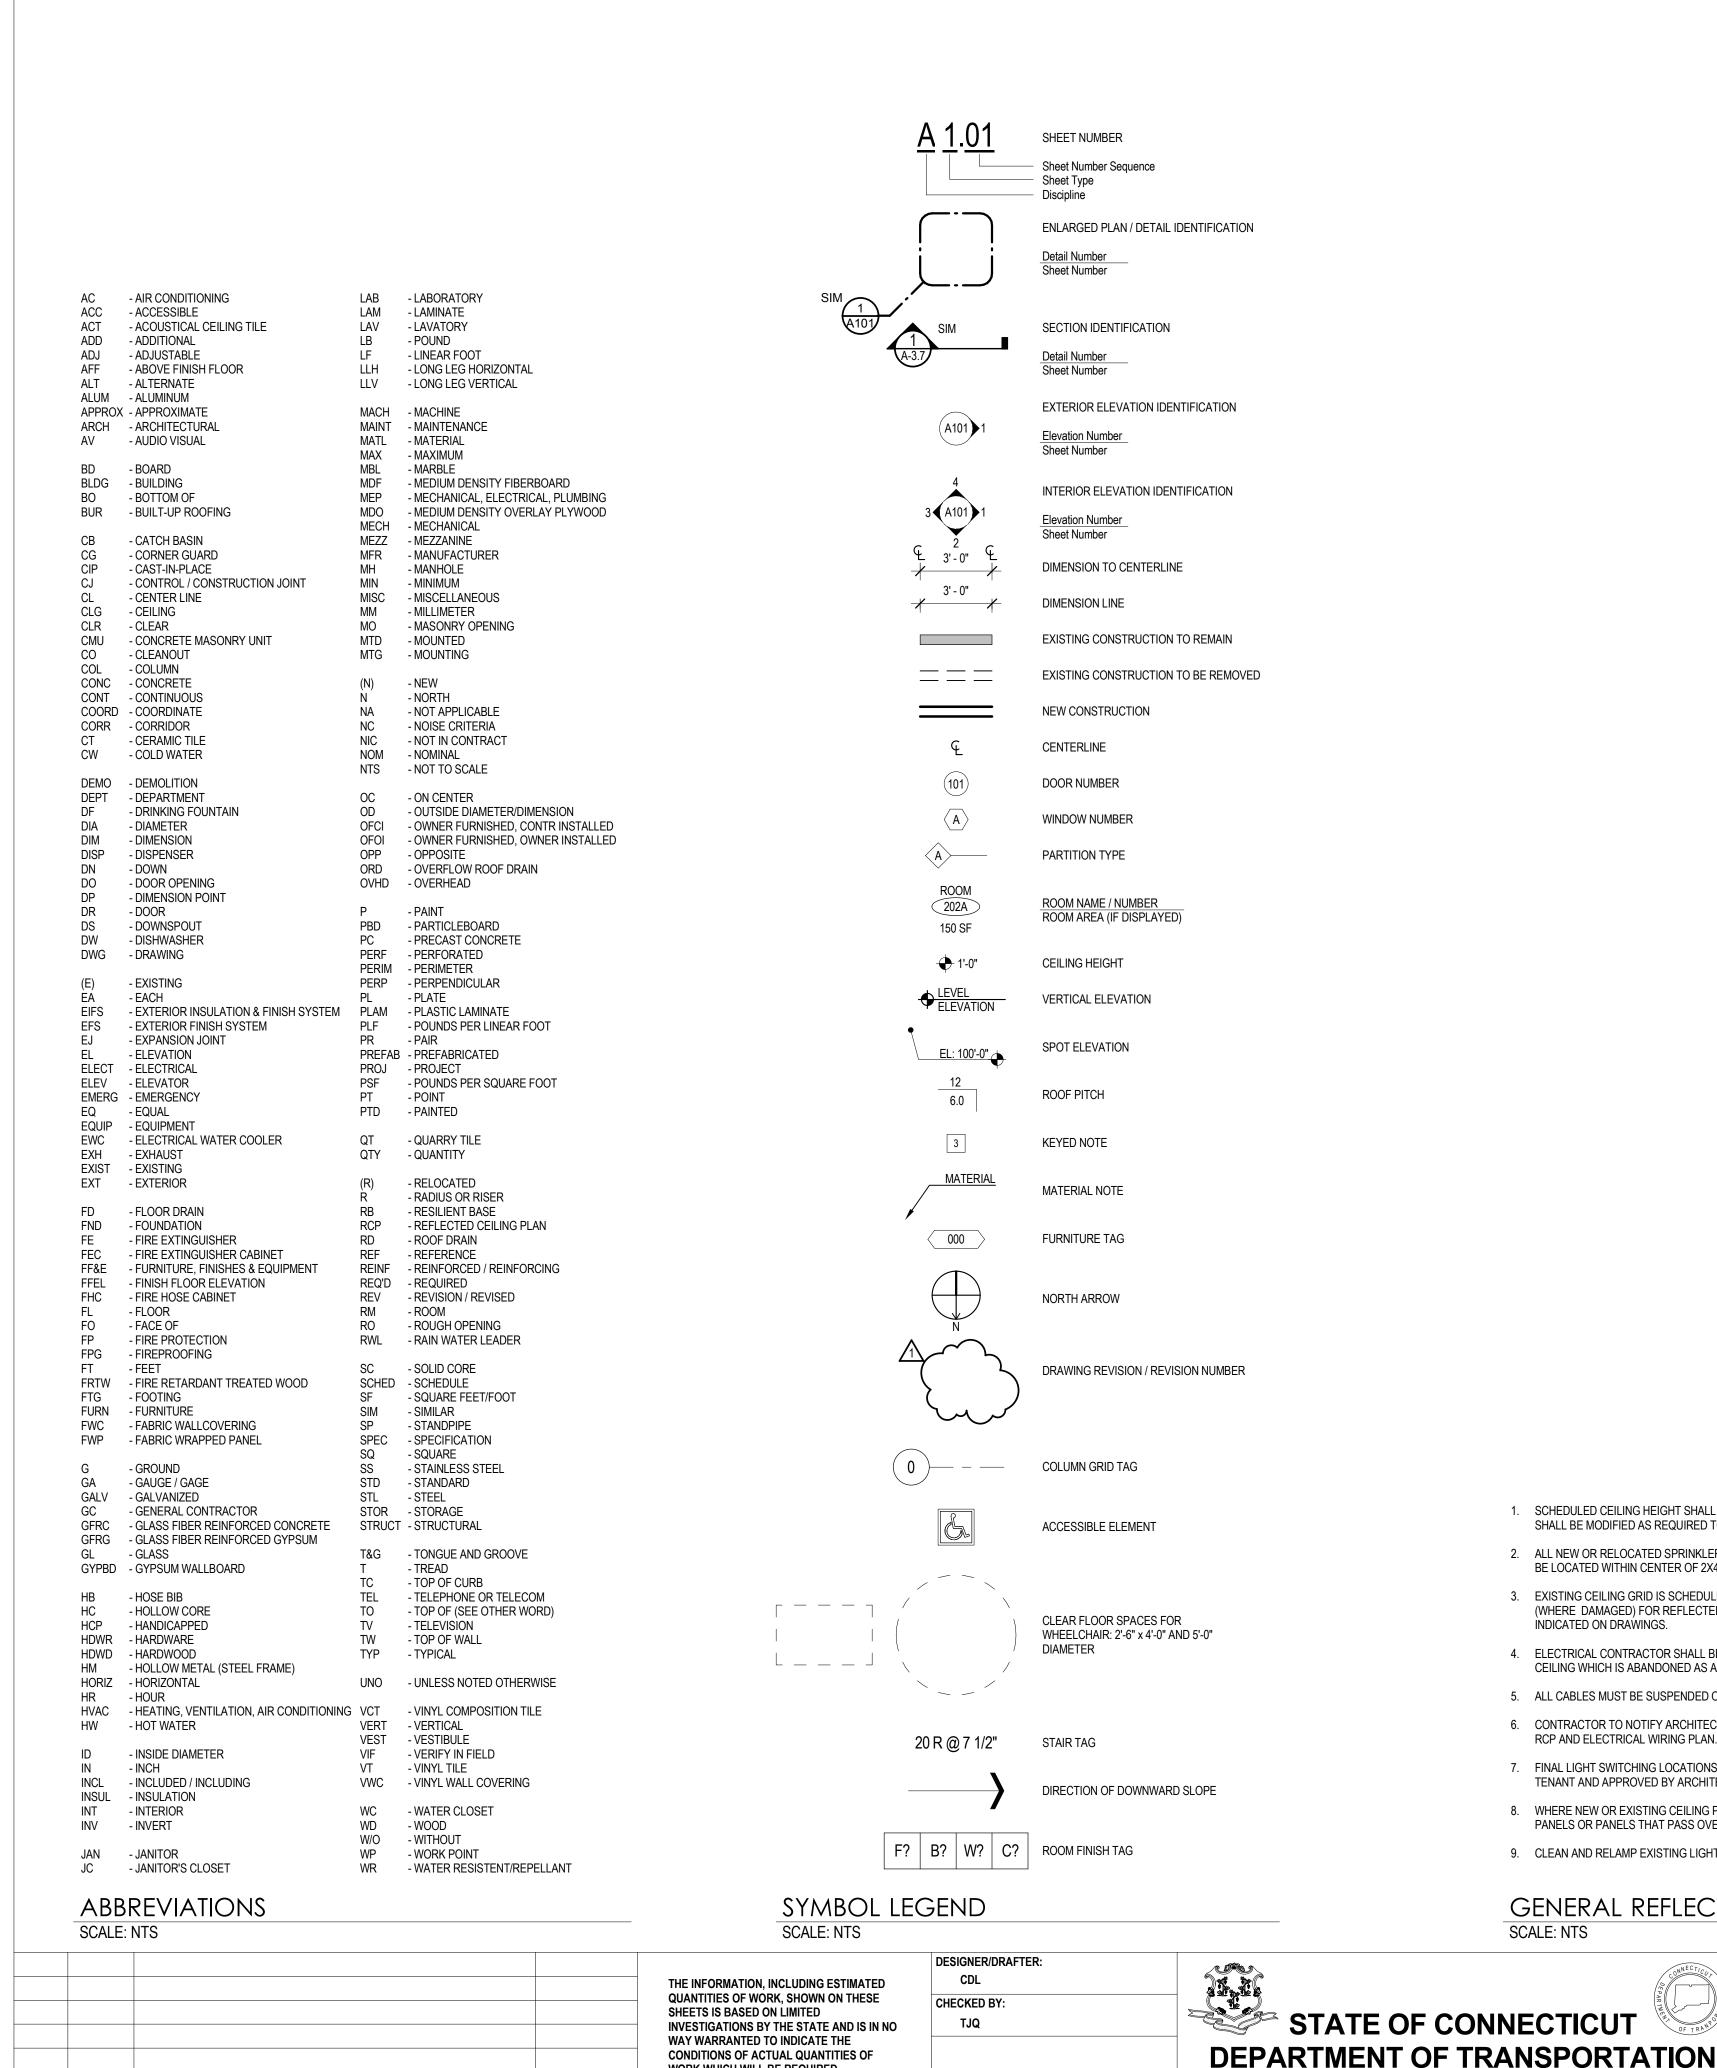

WORK WHICH WILL BE REQUIRED.

SHEET NO. | Plotted Date: 12/18/2009 3:07:45 PM

REV. DATE

REVISION DESCRIPTION

SCALE AS NOTED

ALTERNATE #1

PROVIDE ADDITIONAL/MODIFY EXISTING FIRE PROTECTION SYSTEM AS INDICATED ON SHEET FP1.0.

ALTERNATE LIST

- 1. ALL DIMENSIONS FROM FACE OF FINISH TO FACE OF FINISH UNLESS OTHERWISE INDICATED. ALL DIMENSIONS NOTED AS "HOLD" ARE CRITICAL.
- 2. PROVIDE FIRE TREATED WOOD BLOCKING, COMPLYING WITH ASTM E84 WITHIN NEW AND EXISTING WALLS AS REQUIRED FOR ANCHORING OF ALL BUILT-INS AND WALL MOUNTED ACCESSORIES, ETC.. VERIFY LOCATIONS WITH ARCHITECT/OWNER.
- 3. ALL WORK SHALL FOLLOW ALL APPLICABLE CODES.

1. SCHEDULED CEILING HEIGHT SHALL BE MAINTAINED. EXISTING HVAC AND PLUMBING SYSTEM

2. ALL NEW OR RELOCATED SPRINKLER HEADS, RECESSED CAN LIGHT FIXTURES, ETC. SHOWN TO

BE LOCATED WITHIN CENTER OF 2X4 OR 2X2 CEILING PANEL UNLESS OTHERWISE NOTED.

3. EXISTING CEILING GRID IS SCHEDULED TO REMAIN. REPAIR EXISTING CEILING GRID AS REQUIRED

4. ELECTRICAL CONTRACTOR SHALL BE RESPONSIBLE FOR REMOVAL OF ALL WIRING ABOVE THE

6. CONTRACTOR TO NOTIFY ARCHITECT IF ANY DISCREPANCIES EXIST BETWEEN ARCHITECTURAL

7. FINAL LIGHT SWITCHING LOCATIONS AND SWITCHING SCHEME SHALL BE COORDINATED WITH

8. WHERE NEW OR EXISTING CEILING PANELS HAVE A TEGULAR EDGE, KERF ALL CUT CEILING

PANELS OR PANELS THAT PASS OVER PARTITIONS TO MATCH EXISTING EDGE DESIGN.

9. CLEAN AND RELAMP EXISTING LIGHT FIXTURES SO ALL LAMP TEMPERATURES ARE THE SAME.

SIGNATURE/ BLOCK:

DRAWING PREPARED BY:

OFFICE OF ENGINEERING

AMENTA/EMMA

ARCHITECTS, P.C.

GENERAL REFLECTED CEILING NOTES

(WHERE DAMAGED) FOR REFLECTED CEILING PLAN. PROVIDE NEW CEILING PANELS WHERE

SHALL BE MODIFIED AS REQUIRED TO MEET CEILING HEIGHTS.

CEILING WHICH IS ABANDONED AS A PART OF THIS OR PAST WORK.

5. ALL CABLES MUST BE SUSPENDED OFF THE LAY-IN CEILING.

INDICATED ON DRAWINGS.

RCP AND ELECTRICAL WIRING PLAN.

SCALE: NTS

Filename: C:\Users\CDL\Documents\424 Chapel_POST COMMENTS-CENTRAL_CDL.rvt

TENANT AND APPROVED BY ARCHITECT.

- 4. PROVIDE (2) 20 GA. METAL STUDS AT JAMBS OF ALL NEW DOOR OPENINGS.
- 5. DETAILS NOTED AS TYPICAL APPLY TO ALL SIMILAR LOCATIONS UNLESS OTHERWISE NOTED.
- 6. G.C. TO MAINTAIN CLEAR EGRESS PATHS AT ALL TIMES DURING CONSTRUCTION
- 7. UNLESS INDICATED OTHERWISE, ALL NEW DOORS SHALL BE LOCATED 4" OFF FINISHED WALL (4" TO INSIDE FACE OF FRAME).
- 8. CONTRACTOR'S PRICE SHALL INCLUDE A COMPLETE CONSTRUCTION CLEAN-UP.
- 9. PATCH ALL EXISTING WALLS WHERE REQUIRED TO CREATE SMOOTH SURFACE FOR PAINT
- 10. PREPARE EXISTING FLOOR SUBSTRATE AS REQUIRED FOR NEW SCHEDULED FLOOR FINISH.

LOGICAL GROUT JOINT. INSTALL NEW TILE AND GROUT TO MATCH EXISTING.

- 11. AT ANY EXISTING CONSTRUCTION TO RECEIVE WORK (RE: NEW DOOR, INFILL PARTITION. REMOVAL OF JUNCTION BOXES ETC.) OR AFFECTED BY DEMOLITION WORK, G.C. TO PATCH EXISTING CONSTRUCTION AS REQUIRED TO MATCH EXISTING ADJACENT SURFACE. WHERE SURFACE TO BE PATCHED IS CERAMIC TILE, G.C. SHALL REPLACE CERAMIC TILE BACK TO
- 12. RELOCATE ALL STORED ITEMS WITHIN THE SCOPE OF WORK AREA TO A LOCATION WITHIN THIS BUILDING AS DIRECTED BY OWNER.
- 13. CONTRACTOR TO HAVE A "SHOP VAC" OR SIMILAR EQUIP. ON SITE TO KEEP SITE CLEAN DURING THE CONSTRUCTION PROCESS.
- 14. ALL WIRING, CONDUIT, RACEWAYS, ETC. SHALL BE CONCEALED WITHIN WALLS. G.C. TO PROVIDE CUTTING, PATCHING, PLASTER RINGS AND PULL STRINGS AS REQUIRED TO PROVIDE SUCH CONCEALMENT. PATCH AND PAINT ENTIRE WALL AFFECTED BY NEW WORK.
- 15. CONTRACTOR SHALL BE RESPONSIBLE FOR VISITING THE SITE PRIOR TO BIDDING TO DETERMINE ALL EXIST'G CONDITIONS. CONTRACTOR IS RESPONSIBLE FOR VERIFYING EXTENT OF ALL DEMOLITION AND NEW WORK. G.C. SHALL VERIFY CONDITION OF EXIST'G WALLS TO REMAIN. G.C. SHALL VERIFY SCOPE OF THIS WORK BEFORE PRICING PROJECT. CONTRACTOR IS RESPONSIBLE FOR NOTIFYING THE ARCHITECT OF ANY DISCREPANCIES.
- 16. CEILING HEIGHTS MAY NOT BE MODIFIED DUE TO ANY CONDITIONS NEW OR EXISTING. MODIFY EXISTING CONDITIONS AS REQUIRED TO MAINTAIN SCHEDULED CEILING HEIGHT.
- 17. WHERE ANY TELEPHONE, DATA, & ELECTRICAL WIRING HAVE BEEN DEMOLISHED, PATCH SUBSTRATE & FINISH AS SCHEDULED. WHERE ANY EXIST'G JUNCTION BOXES OR CONDUIT HAVE BEEN REMOVED, PATCH SUBSTRATE & FINISH AS SCHEDULED UNLESS INDICATED OTHERWISE.
- 18. CONTRACTOR RESPONSIBLE FOR PROTECTING PAINTED DOOR FRAMES DURING CONSTRUCTION, PARTICULARLY DURING CARPET INSTALLATIONS AS REQUIRED.
- 19. PROVIDE NEW FIRE EXTINGUISHER CABINETS WITHIN THE TENANT SPACE TO MATCH EXISTING SALVAGED STYLE IF WALL CONSTRUCTION DEPTH CANNOT ACCOMMODATE SALVAGED
- 20. PROVIDE THROUGH PENETRATION FIRESTOPPING JOINT SYSTEMS AND FIRESTOPPING JOINT SYSTEMS @ ALL PENETRATIONS THRU RATED CONSTRUCTION ASSEMBLIES. FIRESTOPPING SHALL BE DESIGNED TO RESIST THE SPREAD OF FIRE FOR THE TIME PERIOD NOT LESS THAN THE REQUIRED FIRE RESISTANT RATING OF THE ADJACENT ASSEMBLY. ALL FIRE-STOPPING ASSEMBLIES SHALL BE U.L. LISTED ASSEMBLIES.

- 1. PROTECT ACOUSTICAL LAY-IN CEILING SYSTEM GRID TO REMAIN; REMOVE CEILING TILES WHERE INDICATED FOR NEW ACOUSTICAL CEILING TILES.
- 2. REMOVE ALL CARPETING, VCT, VINYL WALL BASE, ADHESIVES DOWN TO SUBSTRATE WITHIN SCOPE OF WORK AREA UNLESS OTHERWISE NOTED.
- 3. PROVIDE NECESSARY BARRIERS AS REQ'D TO SECURE SCOPE OF WORK AREA @ END OF EACH 4. WHERE DOOR OR SIDELIGHT ARE SHOWN DASHED, REMOVE ENTIRE ASSEMBLY INCLUDING
- DOOR, FRAME, SIDELIGHT, HARDWARE, ETC. SAVE FOR REUSE IN THIS CONTRACT, WHERE INDICATED, OR OWNER REUSE. (WHERE INDICATED) COORDINATE DISPOSAL OF DOOR FRAMES / SIDELIGHTS PER DIRECTION OF OWNER.
- 5. ANY ELECTRICAL, PHONE, THERMOSTAT, OR OTHER DEVICES & WIRING LOCATED WITHIN SCOPE OF WORK AREA SCHEDULED TO BE DEMOLISHED SHOULD BE RELOCATED OUT OF REACH FOR FURTHER DEMOLITION BY THEIR RESPECTIVE TRADES.
- EXISTING WALLS SCHEDULED TO REMAIN. REMOVE ANY DEVICES AND WIRING THAT DO NOT CORRESPOND W/ PROPOSED ELEC. PLAN LAYOUT. REUSE EXISTING OUTLETS WHERE POSSIBLE. VERIFY WITH ARCHITECT PRIOR TO REMOVAL OF DEVICES.

6. G.C. TO FIELD VERIFY PHONE, ELECTRICAL, THERMOSTAT, OR OTHER DEVICES OR WIRING @


- 7. REMOVE ALL ABANDONED TELEPHONE, DATA, AND ELECTRICAL WIRING FROM ABOVE CEILING AND EXISTING WALLS THAT WILL REMAIN IN PLACE.
- 8. G.C. TO PROVIDE PROTECTION OF ADJACENT AREAS NOT TO BE DISTURBED INCLUDING PATHS OF TRAVEL FROM BUILDING ENTRANCE TO SCOPE OF WORK.
- 9. GENERAL CONTRACTOR TO PROVIDE DEMOLITION AS REQUIRED FOR INSTALLATION OF OUTLET BOXES (LIGHT SWITCHES, RECEPTACLES, FIRE ALARM DEVICES, ELECTRICAL CONDUIT, PLUMBING, PIPING, ETC.) IN ORDER THAT ALL NEW WORK BE CONCEALED. SET OUTLETS AND LIGHT SWITCHES AT BUILDING STANDARD HEIGHT.
- 10. SALVAGE PER OWNER'S DIRECTION ALL EXISTING EQUIPMENT AND FURNITURE.
- 11. REMOVE EXISTING FLOOR MOUNTED DEVICES AND ASSOCIATED WIRING AND CONDUIT DUE TO NEW LAYOUT.
- 12. REMOVE EXISTING LIGHT FIXTURES, DIFFUSERS, ETC. AS REQUIRED DUE TO NEW LAYOUT. SAVE CEILING ITEMS FOR REUSE WHERE POSSIBLE. REFER TO REFLECTED CEILING PLAN FOR SCOPE OF WORK REGARDING NEW CEILING AND EXISTING CEILING TO REMAIN. SPRINKLER PIPING AND DUCTWORK SHALL BE MODIFIED AS REQUIRED TO ACCOMMODATE NEW LAYOUT. REMOVE AND REPLACE EXISTING CEILING PANELS AS REQUIRED FOR SCOPE OF WORK.


GENERAL CONSTRUCTION NOTES SCALE: NTS


GENERAL DEMOLITION NOTES

IMPROVEMENTS TO 424 CHAPEL STREET PHASE ONE

SCALE: NTS PROJECT TITLE: PROJECT NO. **NEW HAVEN** DRAWING NO. SHEET NO. GENERAL NOTES AND LEGENDS

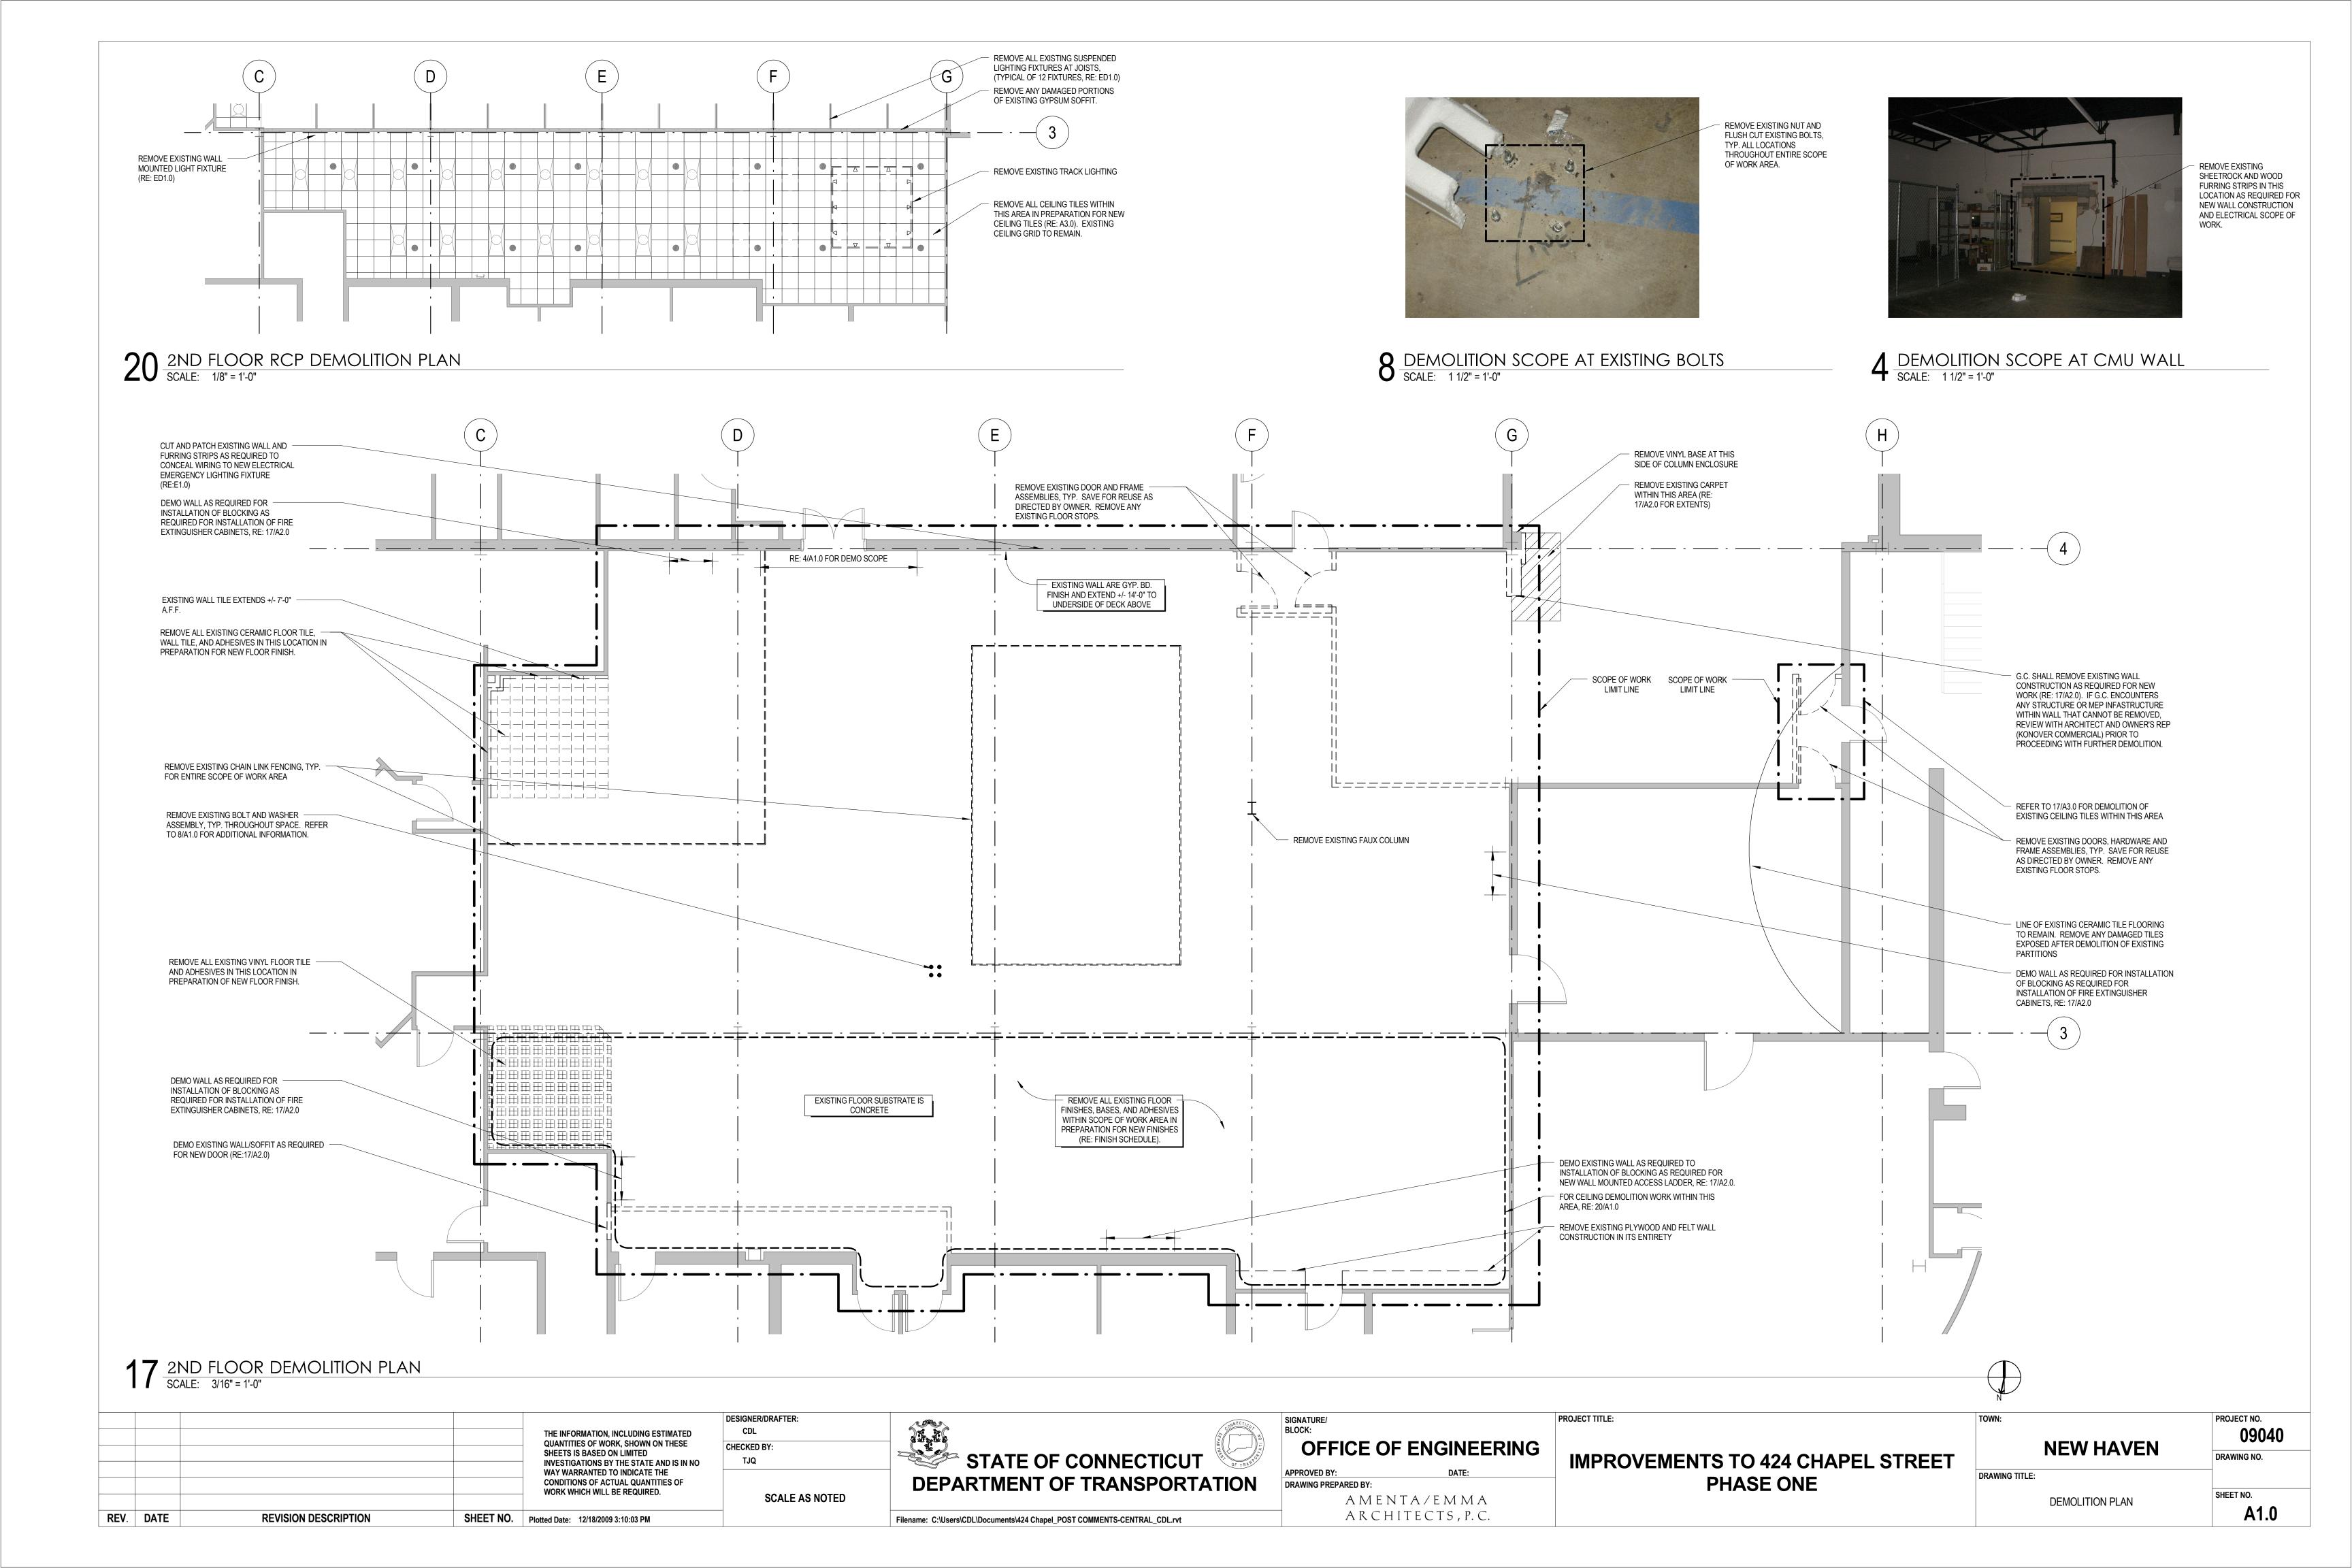

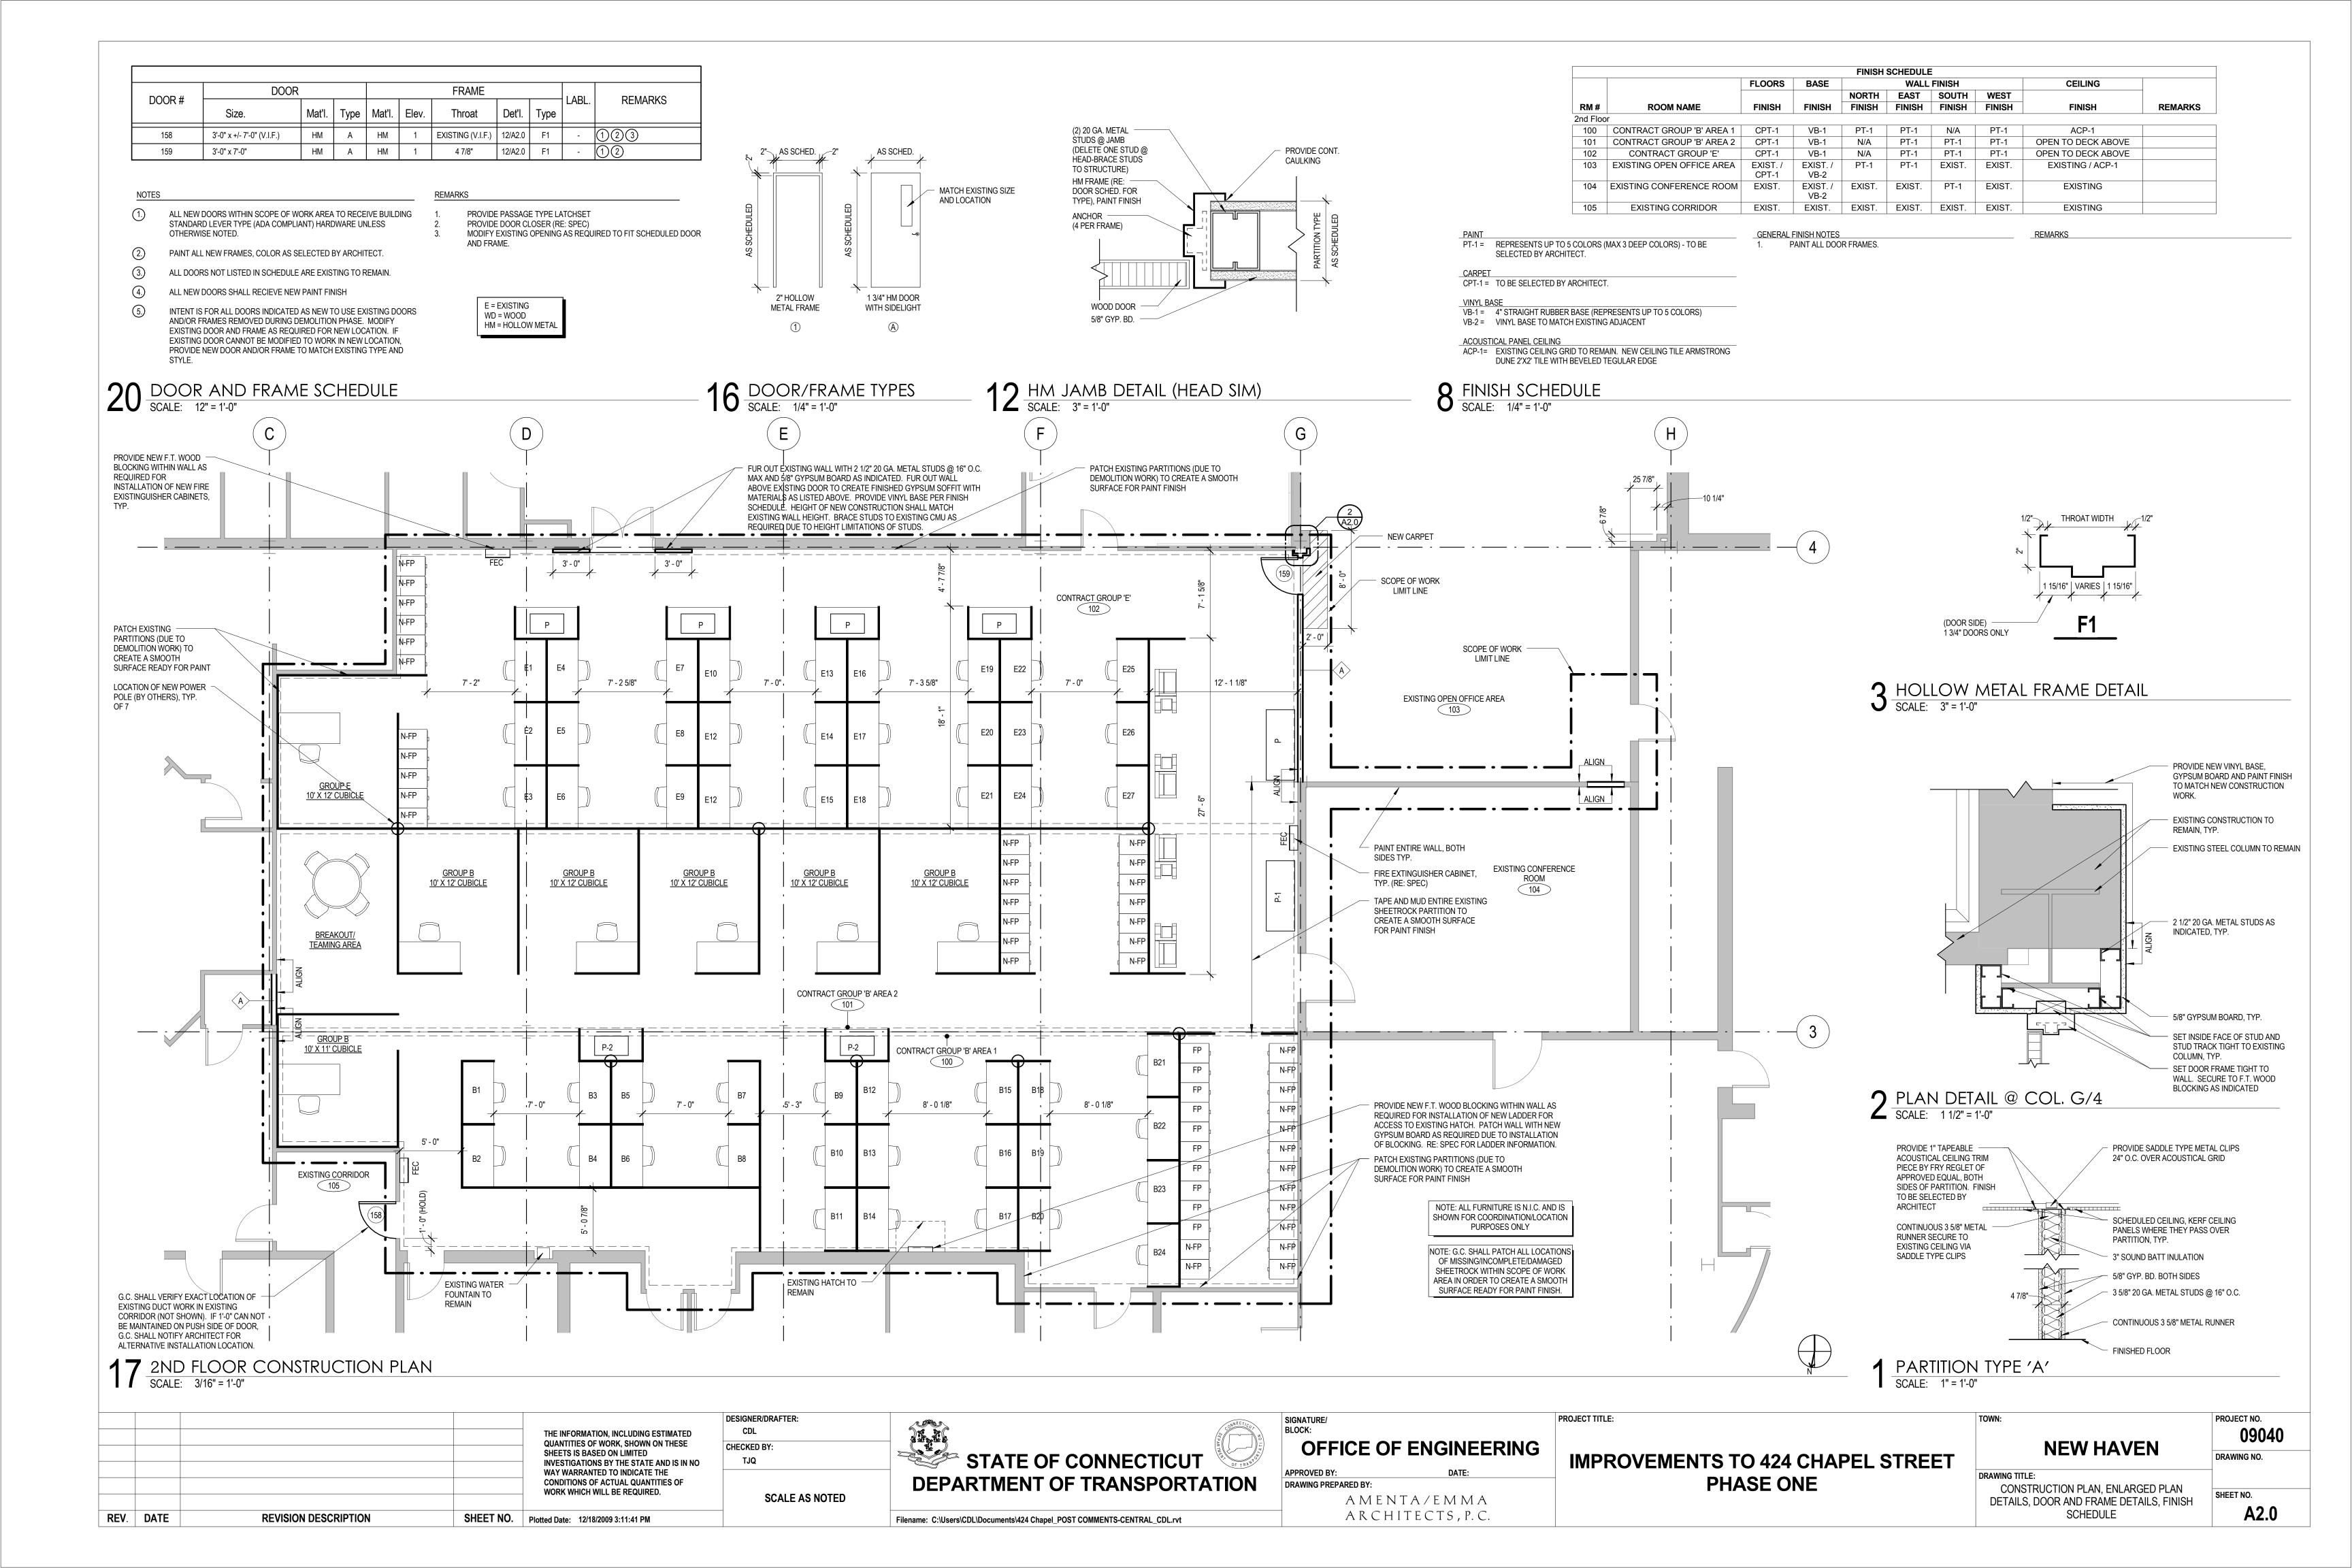

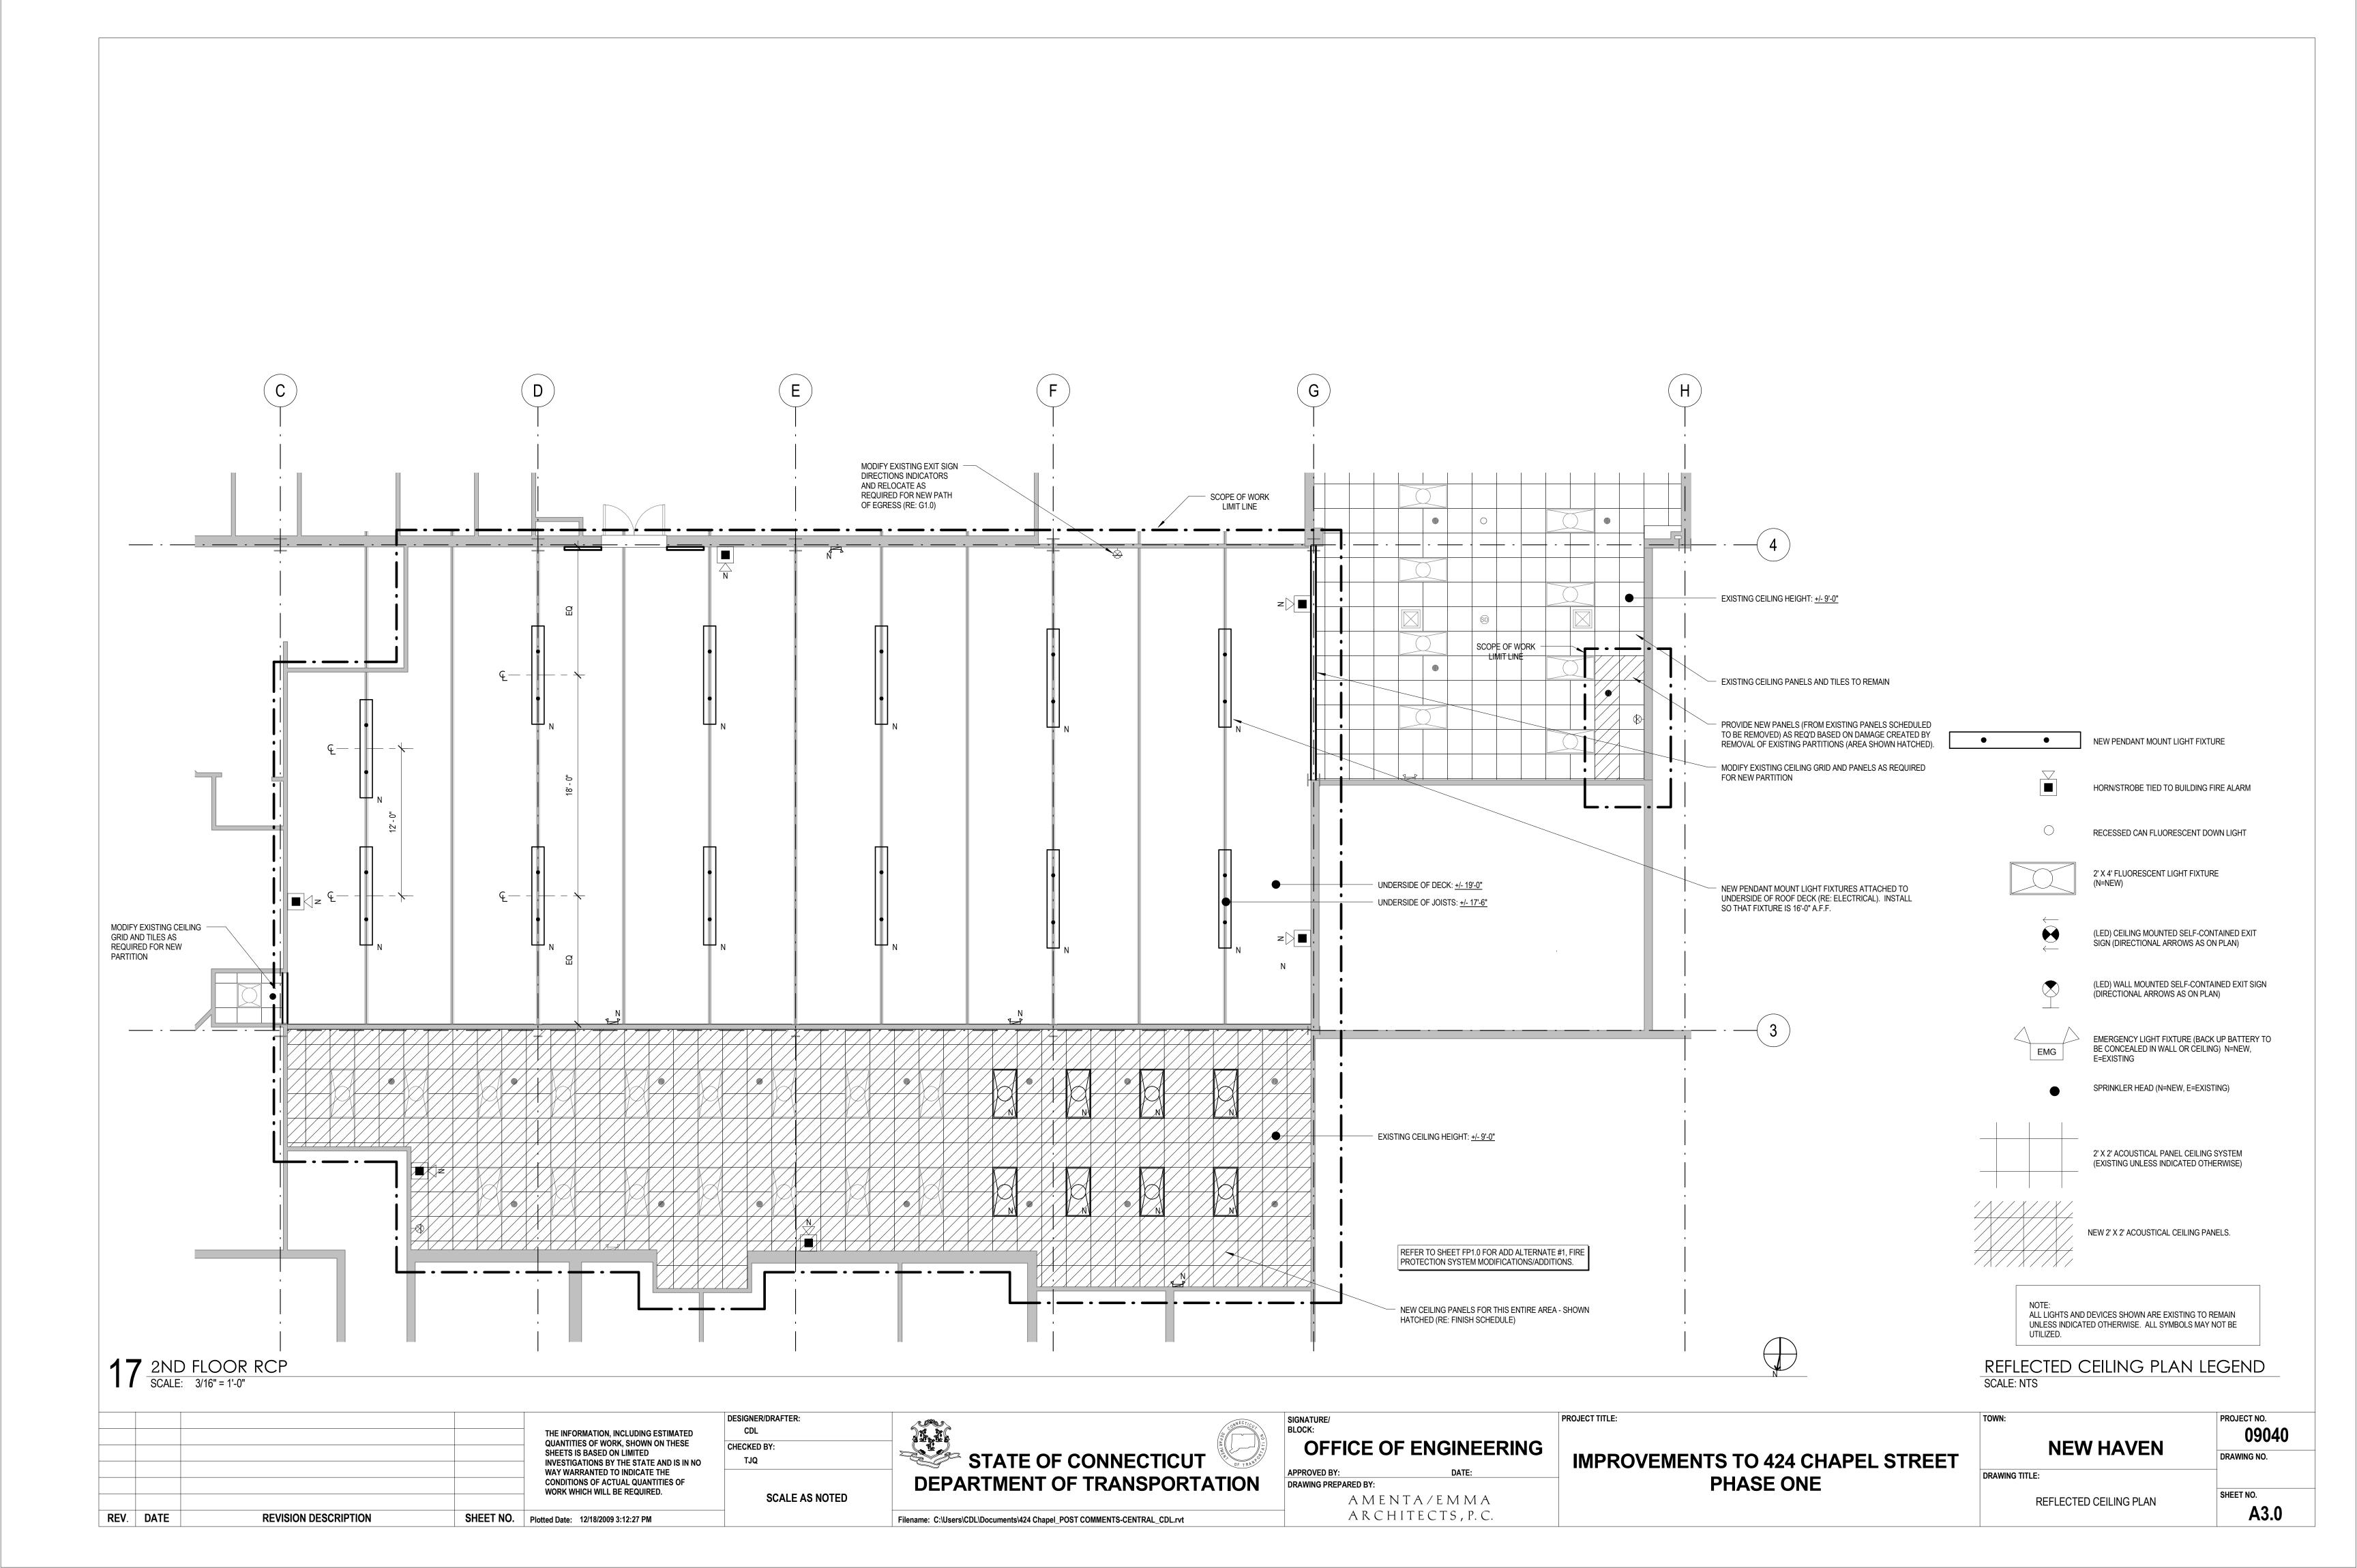

THE INFORMATION, INCLUDING ESTIMATED
QUANTITIES OF WORK, SHOWN ON THESE
SHEETS IS BASED ON LIMITED
INVESTIGATIONS BY THE STATE AND IS IN NO
WAY WARRANTED TO INDICATE THE
CONDITIONS OF ACTUAL QUANTITIES OF
WORK WHICH WILL BE REQUIRED.

SHEET NO. | Plotted Date: 12/18/2009 12:58:30

REVISION DESCRIPTION

REV. DATE

DESIGNER/DRAFTER:
CDL
CHECKED BY:
TJQ

SCALE AS NOTED

STATE OF CONNECTICUT DEPARTMENT OF TRANSPORTATION

OFFICE OF ENGINEERING

APPROVED BY: DATE:

DRAWING PREPARED BY:

AMENTA/EMMA

ARCHITECTS, P.C.

IMPROVEMENTS TO 424 CHAPEL STREET PHASE ONE

NEW HAVEN
DRAWING TITLE:

PROJECT SPECIFICATIONS

SHEET NO.

A4.0

DRAWING NO.

PROJECT SPECIFICATIONS (cont'd)

REVISION DESCRIPTION

REV. DATE

THE INFORMATION, INCLUDING ESTIMATED QUANTITIES OF WORK, SHOWN ON THESE SHEETS IS BASED ON LIMITED INVESTIGATIONS BY THE STATE AND IS IN NO WAY WARRANTED TO INDICATE THE CONDITIONS OF ACTUAL QUANTITIES OF WORK WHICH WILL BE REQUIRED.

SHEET NO. | Plotted Date: 12/18/2009 1:04:42 PM

DESIGNER/DRAFTER: CHECKED BY: TJQ

SCALE AS NOTED

STATE OF CONNECTICUT **DEPARTMENT OF TRANSPORTATION**

SIGNATURE/ BLOCK: **OFFICE OF ENGINEERING**

ARCHITECTS, P.C.

APPROVED BY:

DRAWING PREPARED BY:

AMENTA/EMMA

PROJECT TITLE:

IMPROVEMENTS TO 424 CHAPEL STREET PHASE ONE

PROJECT NO. **NEW HAVEN** DRAWING NO. DRAWING TITLE: SHEET NO.

A4.1

PROJECT SPECIFICATIONS

Filename: C:\Users\CDL\Documents\424 Chapel POST COMMENTS-CENTRAL CDL.rvt

ELECTRICAL LEGEND

	N O T E : ALL MOUNTING HEIGHTS GIVE	N ARE TO CENTERLIN	E OF DEVICE UNLESS OTHERWISE NOTED.
SYMBOL	DESCRIPTION	SYMBOL	DESCRIPTION
0	CEILING MOUNTED LIGHT FIXTURE - SUBLETTER INDICATES TYPE		ELECTRIC PANEL - 120/208V
0	RECESSED DOWNLIGHT FIXTURE - SUBLETTER INDICATES TYPE		SPECIAL PURPOSE ELECTRICAL PANEL
Ю	WALL MOUNTED LIGHT FIXTURE - SUBLETTER INDICATES TYPE	~~~~	FLEXIBLE EQUIPMENT CONNECTION
	SURFACE MOUNTED FLUORESCENT LIGHT FIXTURE - SUBLETTER INDICATES TYPE		FIXED/HARD-WRED EQUIPMENT CONNECTION
	CEILING RECESSED MOUNTED FLUORESCENT LIGHT FIXTURE — SUBLETTER INDICATES TYPE	P	PHOTOCELL
	FLUORESCENT LIGHT FIXTURE WITH EMERGENCY BALLAST — SUBLETTER INDICATES TYPE	TC	TIMECLOCK
• •	PENDANT MOUNTED FLUORESCENT LIGHT FIXTURE - SUBLETTER INDICATES TYPE	С	CONTACTOR
HXI XI	SINGLE FACE EXIT SIGN WITH BATTERY AND DIRECTIONAL ARROWS AS SHOWN — WALL/CEILING MOUNTED	ES	ELECTRIC DOOR STRIKE
<u> </u>	DOUBLE FACE EXIT SIGN WITH BATTERY AND DIRECTIONAL ARROWS AS SHOWN — WALL/CEILING MOUNTED		DOOR CONTACT SWITCH
44	EMERGENCY BATTERY UNIT WITH TWO DIRECTIONAL HEADS		VIDEO CAMERA WITH MOUNTING HARDWARE
S	SINGLE POLE TOGGLE SWITCH - MOUNT AT 48" A.F.F.	VR	VIDEO RECORDER
S 3	THREE WAY TOGGLE SWITCH - MOUNT AT 48" A.F.F.	VM	VIDEO MONITOR
S ₄	FOUR WAY TOGGLE SWITCH - MOUNT AT 48" A.F.F.	K	CARD READER - MOUNTED AT 48" A.F.F.
SP	SINGLE POLE TOGGLE SWITCH AND PILOT LIGHT - MOUNT AT 48" A.F.F.	M M →	CEILING OR WALL MOUNTED MOTION DETECTOR
SR/A	REVERSE ACTION SWITCH		INFRARED BEAM DETECTOR
ST	THERMAL OVERLOAD SWITCH - MOUNT AT FRACTIONAL HP MOTORS	+∭ ∭ ∭ FA	MICROPHONE OUTLET - WALL MOUNTED, FLOOR MOUNTED, FIRE ALARM
SE	EMERGENCY BURNER SHUT-OFF SWITCH - MOUNT AT 60" A.F.F.	A	AMPERE
-	GROUNDED DUPLEX RECEPTACLE — MOUNT AT 18" A.F.F.	A.F.F.	ABOVE FINISHED FLOOR
→ A	GROUNDED DUPLEX RECEPTACLE - MOUNT ABOVE COUNTER BACKSPLASH OR 42" A.F.F.	A.F.G.	ABOVE FINISHED GRADE
-⊕ B	GROUNDED DUPLEX RECEPTACLE - MOUNT HORIZONTALLY IN CASEWORK TOE SPACE	AHU	AIR HANDLING UNIT
⇒ GFI	GROUNDED DUPLEX RECEPTACLE - GFI TYPE - MOUNT AT 18" A.F.F SEE NOTE BELOW	С	CONDUIT
₩P	GROUNDED DUPLEX RECEPTACLE - WEATHERPROOF TYPE - MOUNT AT 24" A.F.G.	C/B	CIRCUIT BREAKER
#	GROUNDED DOUBLE DUPLEX RECEPTACLE — MOUNT AT 18" A.F.F.	CHP	CONSOLE HEAT PUMP
\$	SPECIAL PURPOSE RECEPTACLE - MATCH NEMA CONFIGURATION OF EQUIPMENT SERVED - MOUNT AT 18" A.F.F.	CIR	CIRCUIT
•	TELEPHONE OUTLET WITH BACKBOX, COVER PLATE AND CONDUIT TO CEILING SPACE - MOUNT AT 18" A.F.F.	CUH	CABINET UNIT HEATER
⋖ w	TELEPHONE OUTLET WITH BACKBOX, COVER PLATE AND CONDUIT TO CEILING SPACE - MOUNT AT 48" A.F.F.	DHP	DUCTED HEAT PUMP
◀P	PAY TELEPHONE OUTLET WITH BACKBOX, COVER PLATE AND CONDUIT TO CEILING SPACE - MOUNT AT 48" A.F.F.	(E)	EXISTING TO REMAIN
И	DATA OUTLET WITH BACKBOX, COVER PLATE AND CONDUIT TO CEILING SPACE - MOUNT AT 18" A.F.F.	EBR	ELECTRIC BASEBOARD RADIATION
Ŷ	VIDEO OUTLET WITH BACKBOX, COVER PLATE AND CONDUIT TO CEILING SPACE — MOUNT AT 18" A.F.F.	EBU	EMERGENCY BATTERY UNIT
仓	FIRE ALARM MASTER BOX	EF	EXHAUST FAN
E	MANUAL FIRE ALARM PULL STATION — MOUNT AT 48" A.F.F.	EM	ITEM PROVIDED WITH OR CONNECTED TO EMERGENCY POWER
<u> </u>	SMOKE DETECTOR	EMT	ELECTRICAL METALLIC TUBING
Θ	HEAT DETECTOR	EWC	ELECTRIC WATER COOLER
⊕ ₂₀₀ .	HEAT DETECTOR - 200° RATED	EWH	ELECTRIC WATER HEATER
© _D	DUCT SMOKE DETECTOR	EX	EXISTING
M	MAGNETIC DOOR HOLDER	FA	FIRE ALARM
ф	FIRE ALARM VISUAL ONLY INDICATING UNIT — MOUNT AT 6'-8" AFF	FMC	FLEXIBLE METALLIC TUBING
SIC	FIRE ALARM VOICE EVACUATION SPEAKER AND VISUAL INDICATING UNIT — MOUNT AT 6'-8" A.F.F.	GFI	GROUND FAULT INTERRUPTER
	FIRE ALARM MINI-HORN AND VISUAL INDICATING UNIT - MOUNT AT 6'-8" A.F.F.	IEF	IN-LINE EXHAUST FAN
	FIRE ALARM HORN AND VISUAL INDICATING UNIT — MOUNT AT 6'-8" A.F.F.	IG	ISOLATED GROUND
SD —	FIRE ALARM SMOKE DAMPER — PROVIDED AND INSTALLED BY DIV. 15 WIRED BY DIV. 16	JB	JUNCTION BOX
FS	FLOW SWITCH	MAH	MAKE-UP AIR UNIT
TS	TAMPER SWITCH	MD	MOTORIZED DAMPER
SS	SUPERVISORY SWITCH	NL	NEW LOCATION OF EXISTING RELOCATED
PS	PRESSURE SWITCH	(RP	NEW TO REPLACE EXISTING
FACP	FIRE ALARM CONTROL PANEL	Р	POLE
RAP	FIRE ALARM REMOTE ANNUNCIATOR PANEL	PE	PRIMARY ELECTRIC SERVICE
<u>S</u>	COMBINATION SPEAKER CLOCK IN COMMON ENCLOSURE — MOUNT AT 8'-0" AFF TO BOTTOM OF DEVICE	PGFI	PERSONAL GROUND FAULT INTERRUPTER
<u> </u>	CEILING MOUNTED SOUND SYSTEM SPEAKER	PVC	POLYVINYL CHLORIDE CONDUIT
S	EMERGENCY "CALL-FOR-AID" SWITCH - MOUNT AT 48" A.F.F. WITH PULL CORD TO 6" A.F.F.	RAP	REMOTE ANNUNCIATOR PANEL
■Q B	EMERGENCY "CALL-FOR-AID" BUZZER/LIGHT - MOUNT AT 7'-6" A.F.F.	RE	REMOVE EXISTING
G (H	EMERGENCY SHUT-OFF SWITCH - MOUNT AT 48" A.F.F G = GAS - E = ELECTRIC	REF	ROOF EXHAUST FAN
J	JUNCTION BOX	RGS	RIGID GALVANIZED STEEL CONDUIT
N/	MOTOR	RL	RELOCATE EXISTING
	NON-FUSED DISCONNECT SWITCH	RR	REMOVE AND REPLACE ON NEW SURFACE
	FUSED DISCONNECT SWITCH	RTU	ROOFTOP UNIT
	MAGNETIC MOTOR STARTER	SD	SMOKE DAMPER
	SWITCH LEG WIRING	SE	SECONDARY ELECTRIC SERVICE
	BRANCH CIRCUIT WIRING	T	TELEPHONE SERVICE
	BRANCH CIRCUIT FEEDER	TCP	TEMPERATURE CONTROL PANEL
	CONTROL WIRING	TV	TELEVISION
<u> </u>	EMERGENCY WIRING	TX	TRANSFORMER
<u> </u>	NIGHT LIGHT CIRCUIT	UF	UNFUSED
——————————————————————————————————————	ELECTRICAL GROUND	WEF	WALL EXHAUST FAN
	EXISTING CONDUIT WITH NEW WIRING	WP	WEATHER PROOF

ELECTRICAL NOTES:

- 1. RECEPTACLES LOCATED WITHIN 5' OF A WATER SOURCE AND WHERE REQUIRED BY CODE SHALL BE PROVIDED WITH A GFI TYPE RECEPTACLE WHETHER INDICATED OR NOT.
- 2. ALL SYMBOLS MAY NOT BE USED.
- 3. MINIMUM AWG WIRE SIZE TO BE #12. USE THHN/THWN (Cu) CONDUCTORS.
- 4. ELECTRICAL CONTRACTOR TO OBTAIN ELECTRICAL PERMIT AND PAY ASSOCIATED FEES.
- 5. ALL WORK TO MEET STATE BUILDING CODE, NATIONAL ELECTRICAL CODE, AND LOCAL BUILDING CODE REQUIREMENTS IF ANY.
- 6. ELECTRICAL INSTALLATION SHALL BE CHECKED AND TESTED FOR PROPER OPERATION. ANY WORK FOUND NOT SATISFACTORY OR OPERATING PROPERLY, SHALL BE REPAIRED/REPLACED, RETESTED AND SHOWN TO BE OPERATING AS REQUIRED.
- 7. ELECTRICAL CONTRACTOR TO COORDIANTE WITH OTHER CONTRACTORS, ARCHITECT, TENANT AND OTHER NECESSARY PARTIES TO INSURE WORK PROGRESSES IN A TIMELY FASHION.
- 8. ALL DEVICES TO BE COMMERCIAL GRADE, 20A RATED.
- 9. ALL WORK TO BE WARRANTIED FOR ONE (1) YEAR FROM DATE OF ACCEPTANCE.


LIGHTING NOTES:

- 1. ALL FLUORESCENT FIXTURES TO BE PROVIDED WITH ELECTRONIC LAMPS AND BALLASTS. BALLASTS TO BE RATED <10% TOTAL HARMONIC DISTORTION (THD).
- 2. ALL FLUORESCENT LAMPS TO BE COLOR TEMPERATURE 3500°K.

3. SEISMIC RESTRAINTS:

IN ADDITION TO THE REQUIREMENTS OF IBC 2003 SECTION 1621 AND THE NEC SECTION 410-16(c), ALL RECESSED LIGHT FIXTURES SHALL BE PROVIDED WITH SUPPORT WIRES AT A MINIMUM OF FOUR (4) PER FIXTURE AND LOCATED NOT MORE THAN SIX (6") INCHES FROM EACH CORNER, EXTENDED AND ATTACHED TO THE BUILDING STRUCTURE. HANGER WIRES SHALL BE GALVANIZED CARBON STEEL, ASTM A641, SOFT TEMPER, PRE-STRETCHED WITH A YIELD STRESS LOAD OF ATLEAST THREE (3) TIMES DESIGN LOAD BUT NOT LESS THAN 12 GAUGE (0.106"). FOR ROUND FIXTURES OR FIXTURES SMALLER THAN THE CEILING GRID, PROVIDE A MINIMUM OF FOUR (4) WIRES PER FIXTURE AND LOCATE AT EACH CORNER OF THE CEILING GRID IN WHICH THE FIXTURE IS TO BE LOCATED. ADDITIONALLY, WHERE FIXTURES OF SIZES LESS THAN THE CEILING GRID ARE INDICATED TO BE CENTERED IN THE ACOUSTICAL PANEL, SUCH FIXTURES SHALL BE SUPPORTED WITH A MINIMUM OF TWO (2) 3/4" METAL CHANNELS SPANNING AND SECURED TO THE CEILING TEES.

4. WIRE ALL EMERGENCY AND EXIT LIGHT FIXTURES TO THE LINE SIDE OF AREA LIGHTING CIRCUIT TO SENSE LOSS OF NORMAL LIGHT CIRCUIT POWER AND FOR CONTINUOUS TRICKLE CHARGE.

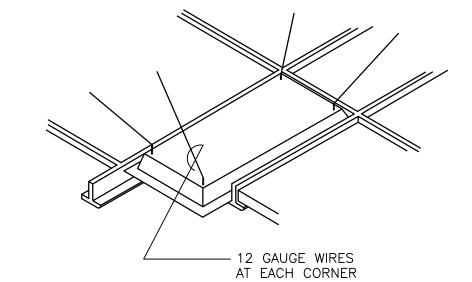

LIGHTING FIXTURE BRACING DETAIL

	LIGHTING FIXTURE SCHEDULE								
TYPE	MANUFACTURER	CATALOG NUMBER	LAMPS		VOLTO	MOUNTING	FINISH	EQUALS	
IIIFL	WANDFACTORER	CATALOG NOMBER	QTY	TYPE	VOLTS	MOONTING	ГІМІЗП	EQUALS	
Α	LITE CONTROL	P-SD-1848T5HO-PBSS	4	T5HO	277	AIRCRAFT CABLE		METALUMEN, FOCAL POINT	
В	LITHONIA	2SP-G-3-32-7815-LD-MVOLT-1/3	3	Т8		RECESSED		DAYBRITE, HUBBELL	
EM	LIGHTALARMS	LCA-2SQ	INCL			WALL		DUAL LITE, SURE-LITES	

PANEL SCHEDULE							A							
	VOLTAGE	120	/208		M	IAIN RATING		100				MOUNTING	SURI	FACE
	PHASE		3			MLO/MCB	ľ	MLO				LOCATION	SEE P	PLANS
	WIRE		4			FEEDER	4#6+1	I#10G, 1"	C		DE	MAND LOAD	16	5.0
				CONN	ECTED LOAD I	IN KW	ြ တ					CONNE	ECTED LOAD	IN KW
CKT#	AREA SERVED	C/B	WIRE	MOTOR	RECEPT.	LIGHT	PHAS	CKT#	AREA SERVED	C/B	WIRE	MOTOR	RECEPT.	LIGHT
1	CUBICLES	20/1	#12		0.8		Α	2	CUBICLES	20/1	#12		0.8	
3	CUBICLES	20/1	#12		1.2		В	4	CUBICLES	20/1	#12		1.2	
5	CUBICLES	20/1	#12		0.8		С	6	COPIER	20/1	#12		1.2	
7	COPIER	20/1	#12		1.2		Α	8	COPIER	20/1	#12		1.2	
9	COPIER	20/1	#12		1.2		В	10	CUBICLES	20/1	#12		1.4	
11	CUBICLES	20/1	#12		1.2		С	12	CUBICLES	20/1	#12		0.6	
13	CUBICLES	20/1	#12		1.2		Α	14	CUBICLES	20/1	#12		1.2	
15	CUBICLES	20/1	#12		1.2		В	16	CUBICLES	20/1	#12		1.2	
17	CUBICLES	20/1	#12		1.2		С	18	PRINTER	20/1	#12		1.2	
19	GEN RECEPTS	20/1	#12		0.8		Α	20	PRINTER	20/1	#12		1.2	
21	RELOCATED 20A/1P FROM PANEL 'NLA'						В	22	RELOCATED 20A/1P FROM PANEL 'NLA'					
23							С	24	RELOCATED 20A/1P FROM PANEL 'NLA'					

NOTE: PANEL TO BE A LOAD CENTER MANUFACTURED BY G.E., EATON, SQUARE-D OR SIEMENS

ARCHITECTS, P.C.




0 0 0 0 0 0	00
LEGNOS&CRAMER	MECHANICAL AND ELECTRICAL ENGINEERING
	70 Inwood Road, Rocky Hill, CT 06067 P: 860-246-8875 F: 860-525-2544


THE INFORMATION, INCLUDING ESTIMATED QUANTITIES OF WORK, SHOWN ON THESE SHEETS IS BASED ON LIMITED INVESTIGATIONS BY THE STATE AND IS IN NO WAY WARRANTED TO INDICATE THE THE INFORMATION, INCLUDING ESTIMATED CHECKED BY: CHECKED BY: LJS STATE OF CONNECTICUT	REV. DATE	REVISION DESCRIPTION	SHEET NO.	WORK WHICH WILL BE REQUIRED. Plotted Date: 12/10/2009	SCALE: NO SCALE	Filename:
DESIGNER/DRAFTER-				THE INFORMATION, INCLUDING ESTIMATED QUANTITIES OF WORK, SHOWN ON THESE SHEETS IS BASED ON LIMITED INVESTIGATIONS BY THE STATE AND IS IN NO WAY WARRANTED TO INDICATE THE	CHECKED BY:	


SIGNATURE/ BLOCK:		PROJECT TITLE:
OFF	ICE OF ENGINEERING	 IMPROVEMENTS
APPROVED BY	: DATE:	
DRAWING PRE	PARED BY:	PH.
	A M E N T A / E M M A	


•	IMPROVEMENTS TO 424 CHAPEL STREET	DRA
	PHASE ONE	EL

N	F: 860-525-	2544
TOWN:		PROJECT NO.
NEW HA	AVEN	09040 DRAWING NO.
DRAWING TITLE: ELECTRICAL SYMBOL LIST, F PANEL SCHEDULE, A	IXTURE SCHEDULE AND NOTES	SHEET NO. E0.0

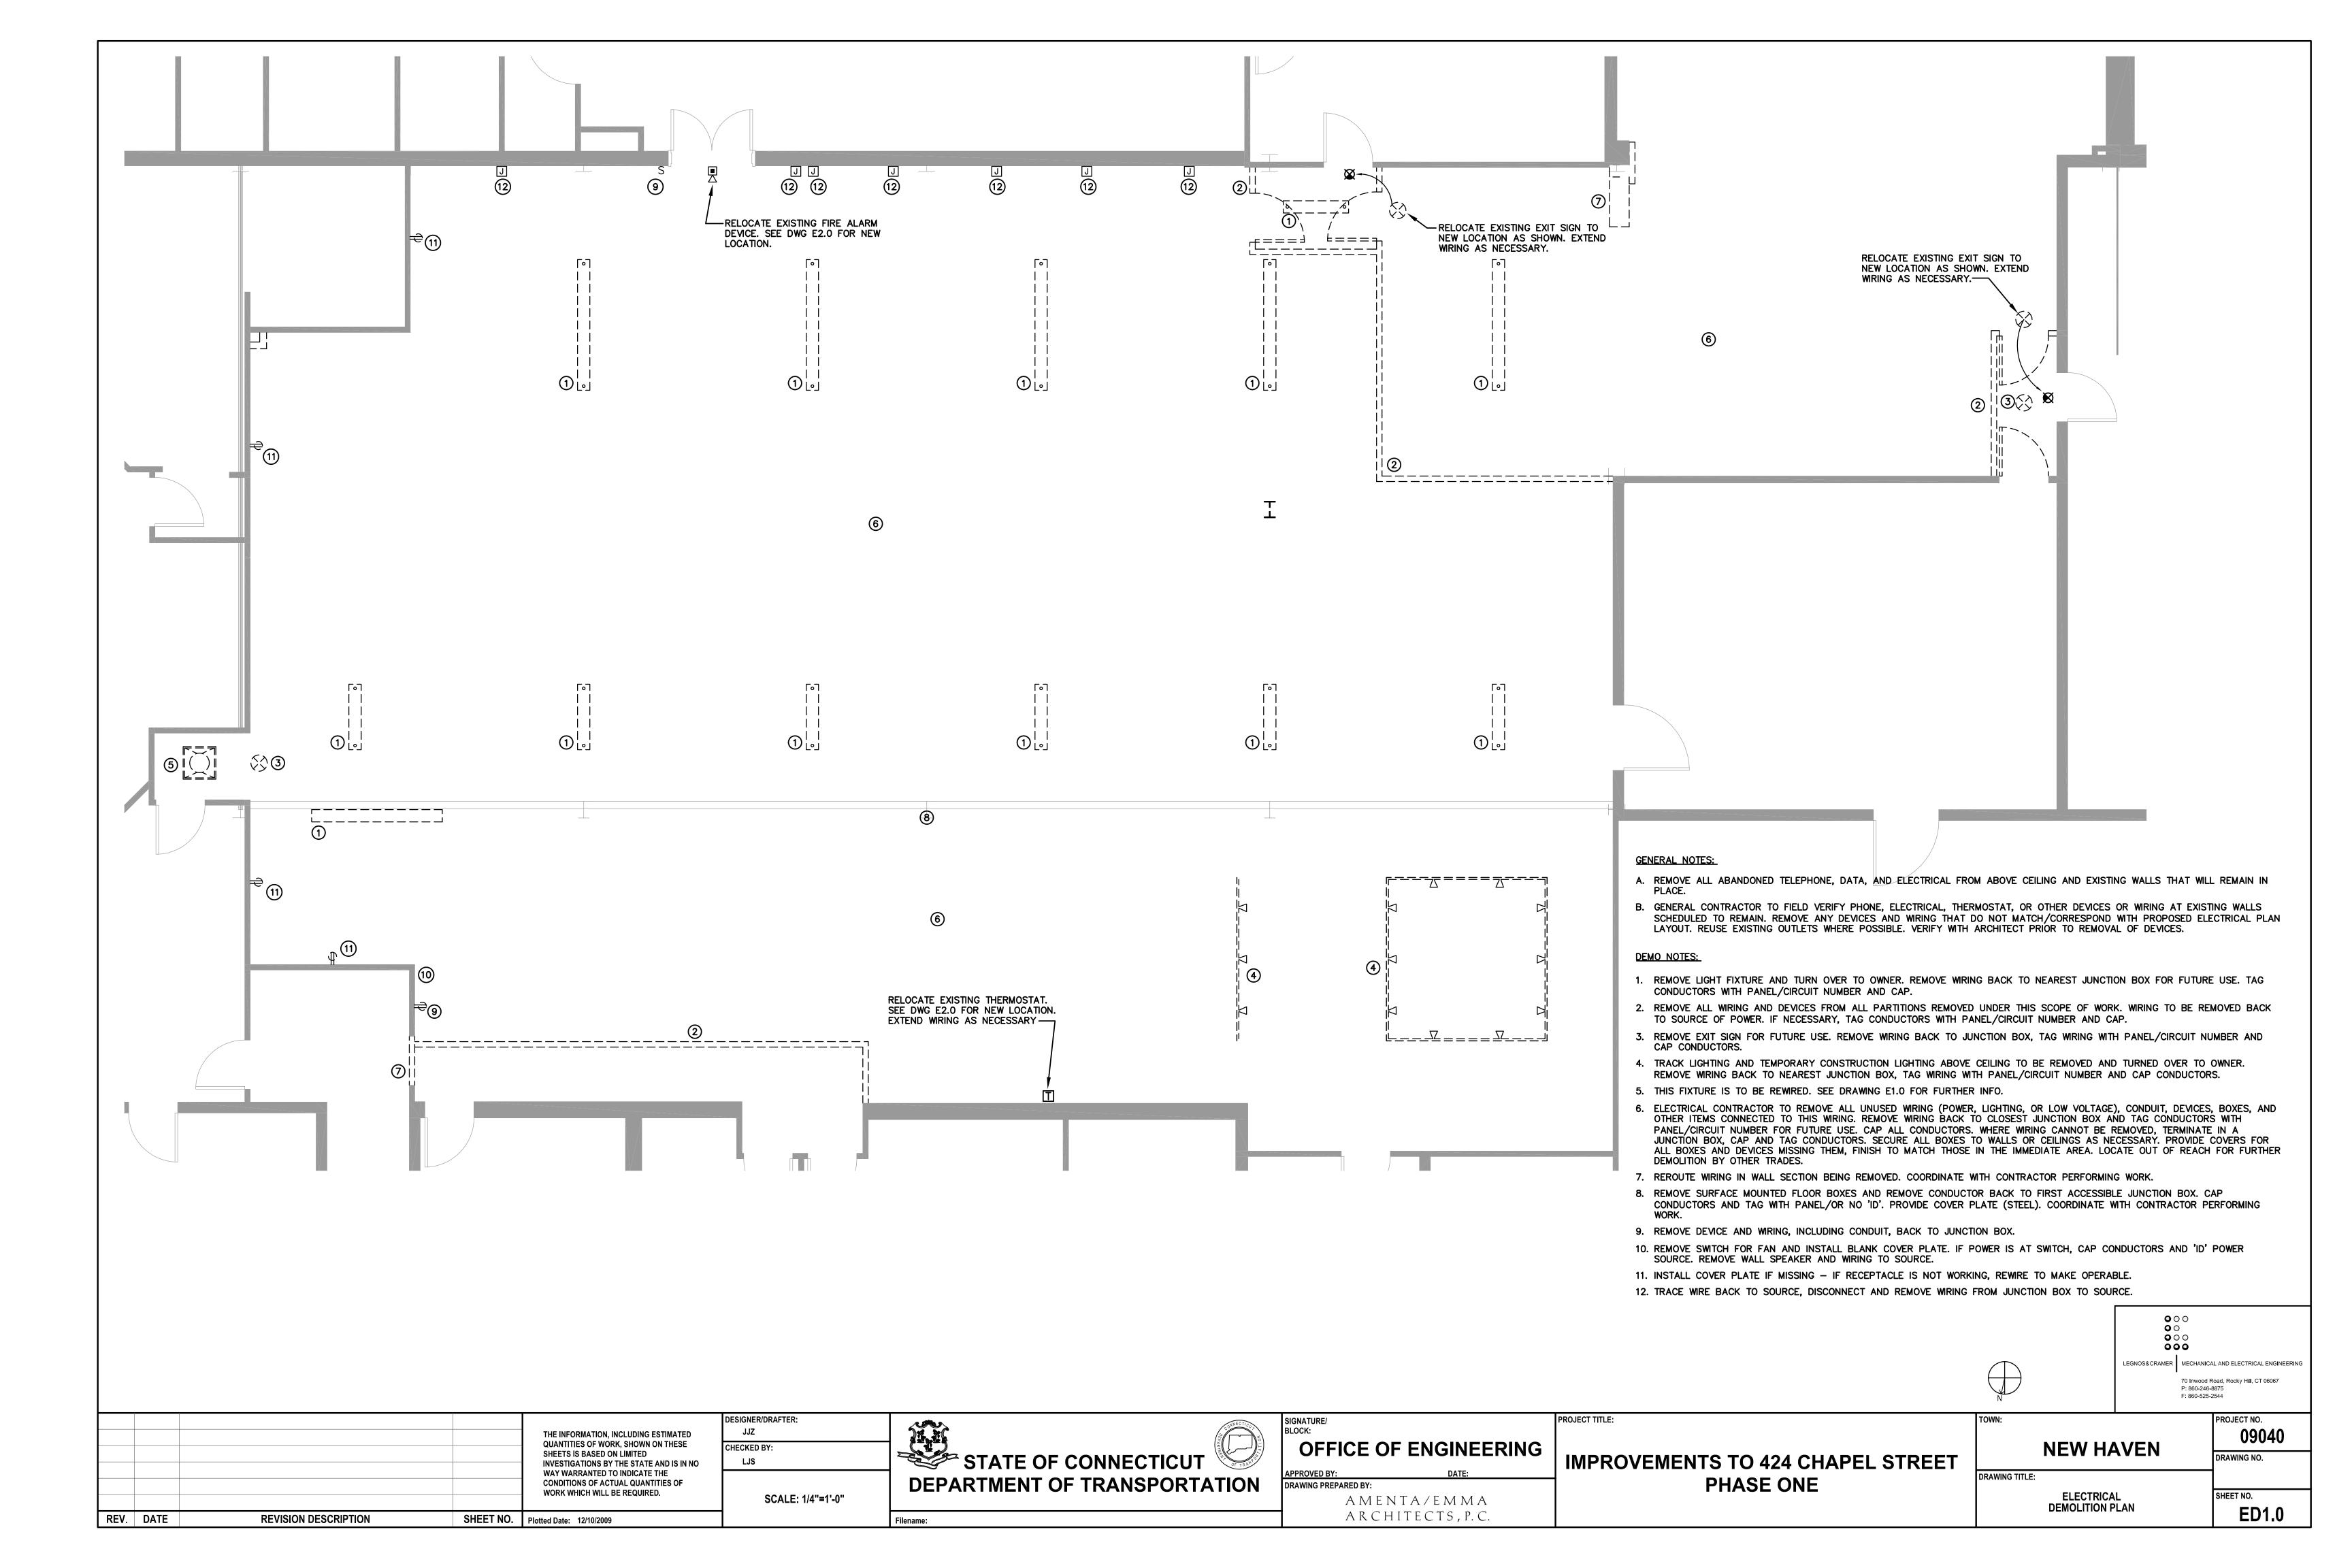

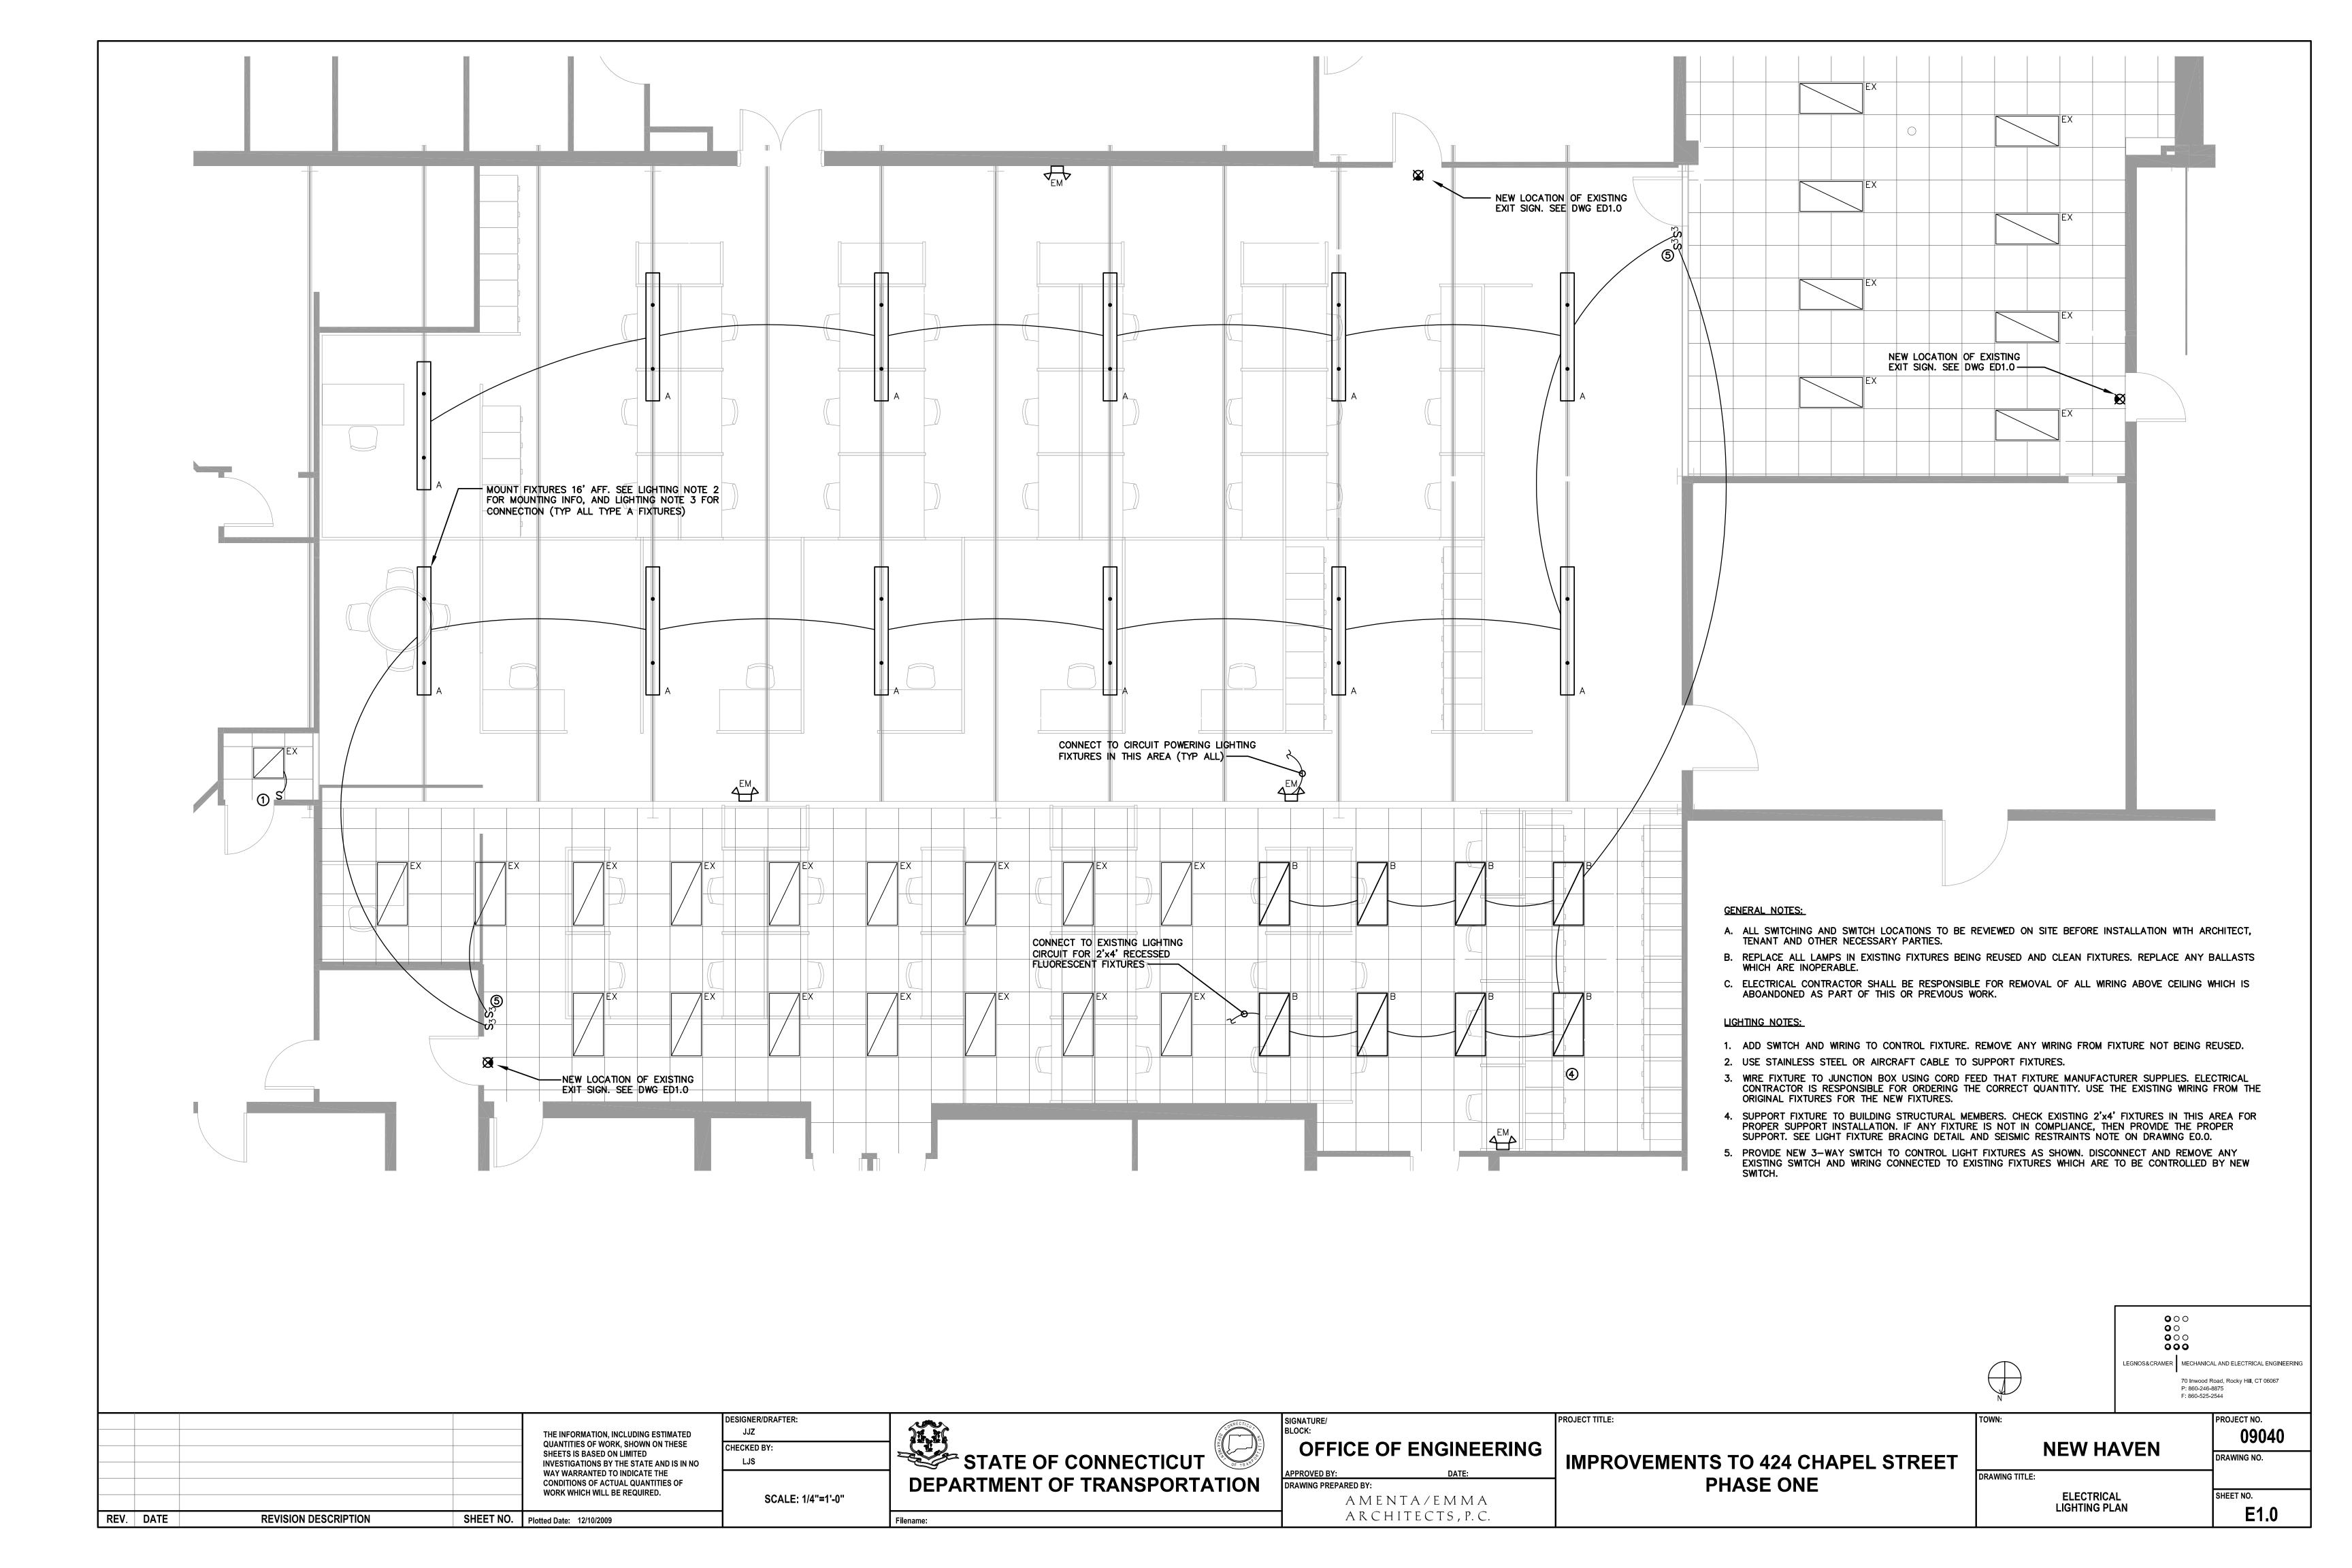

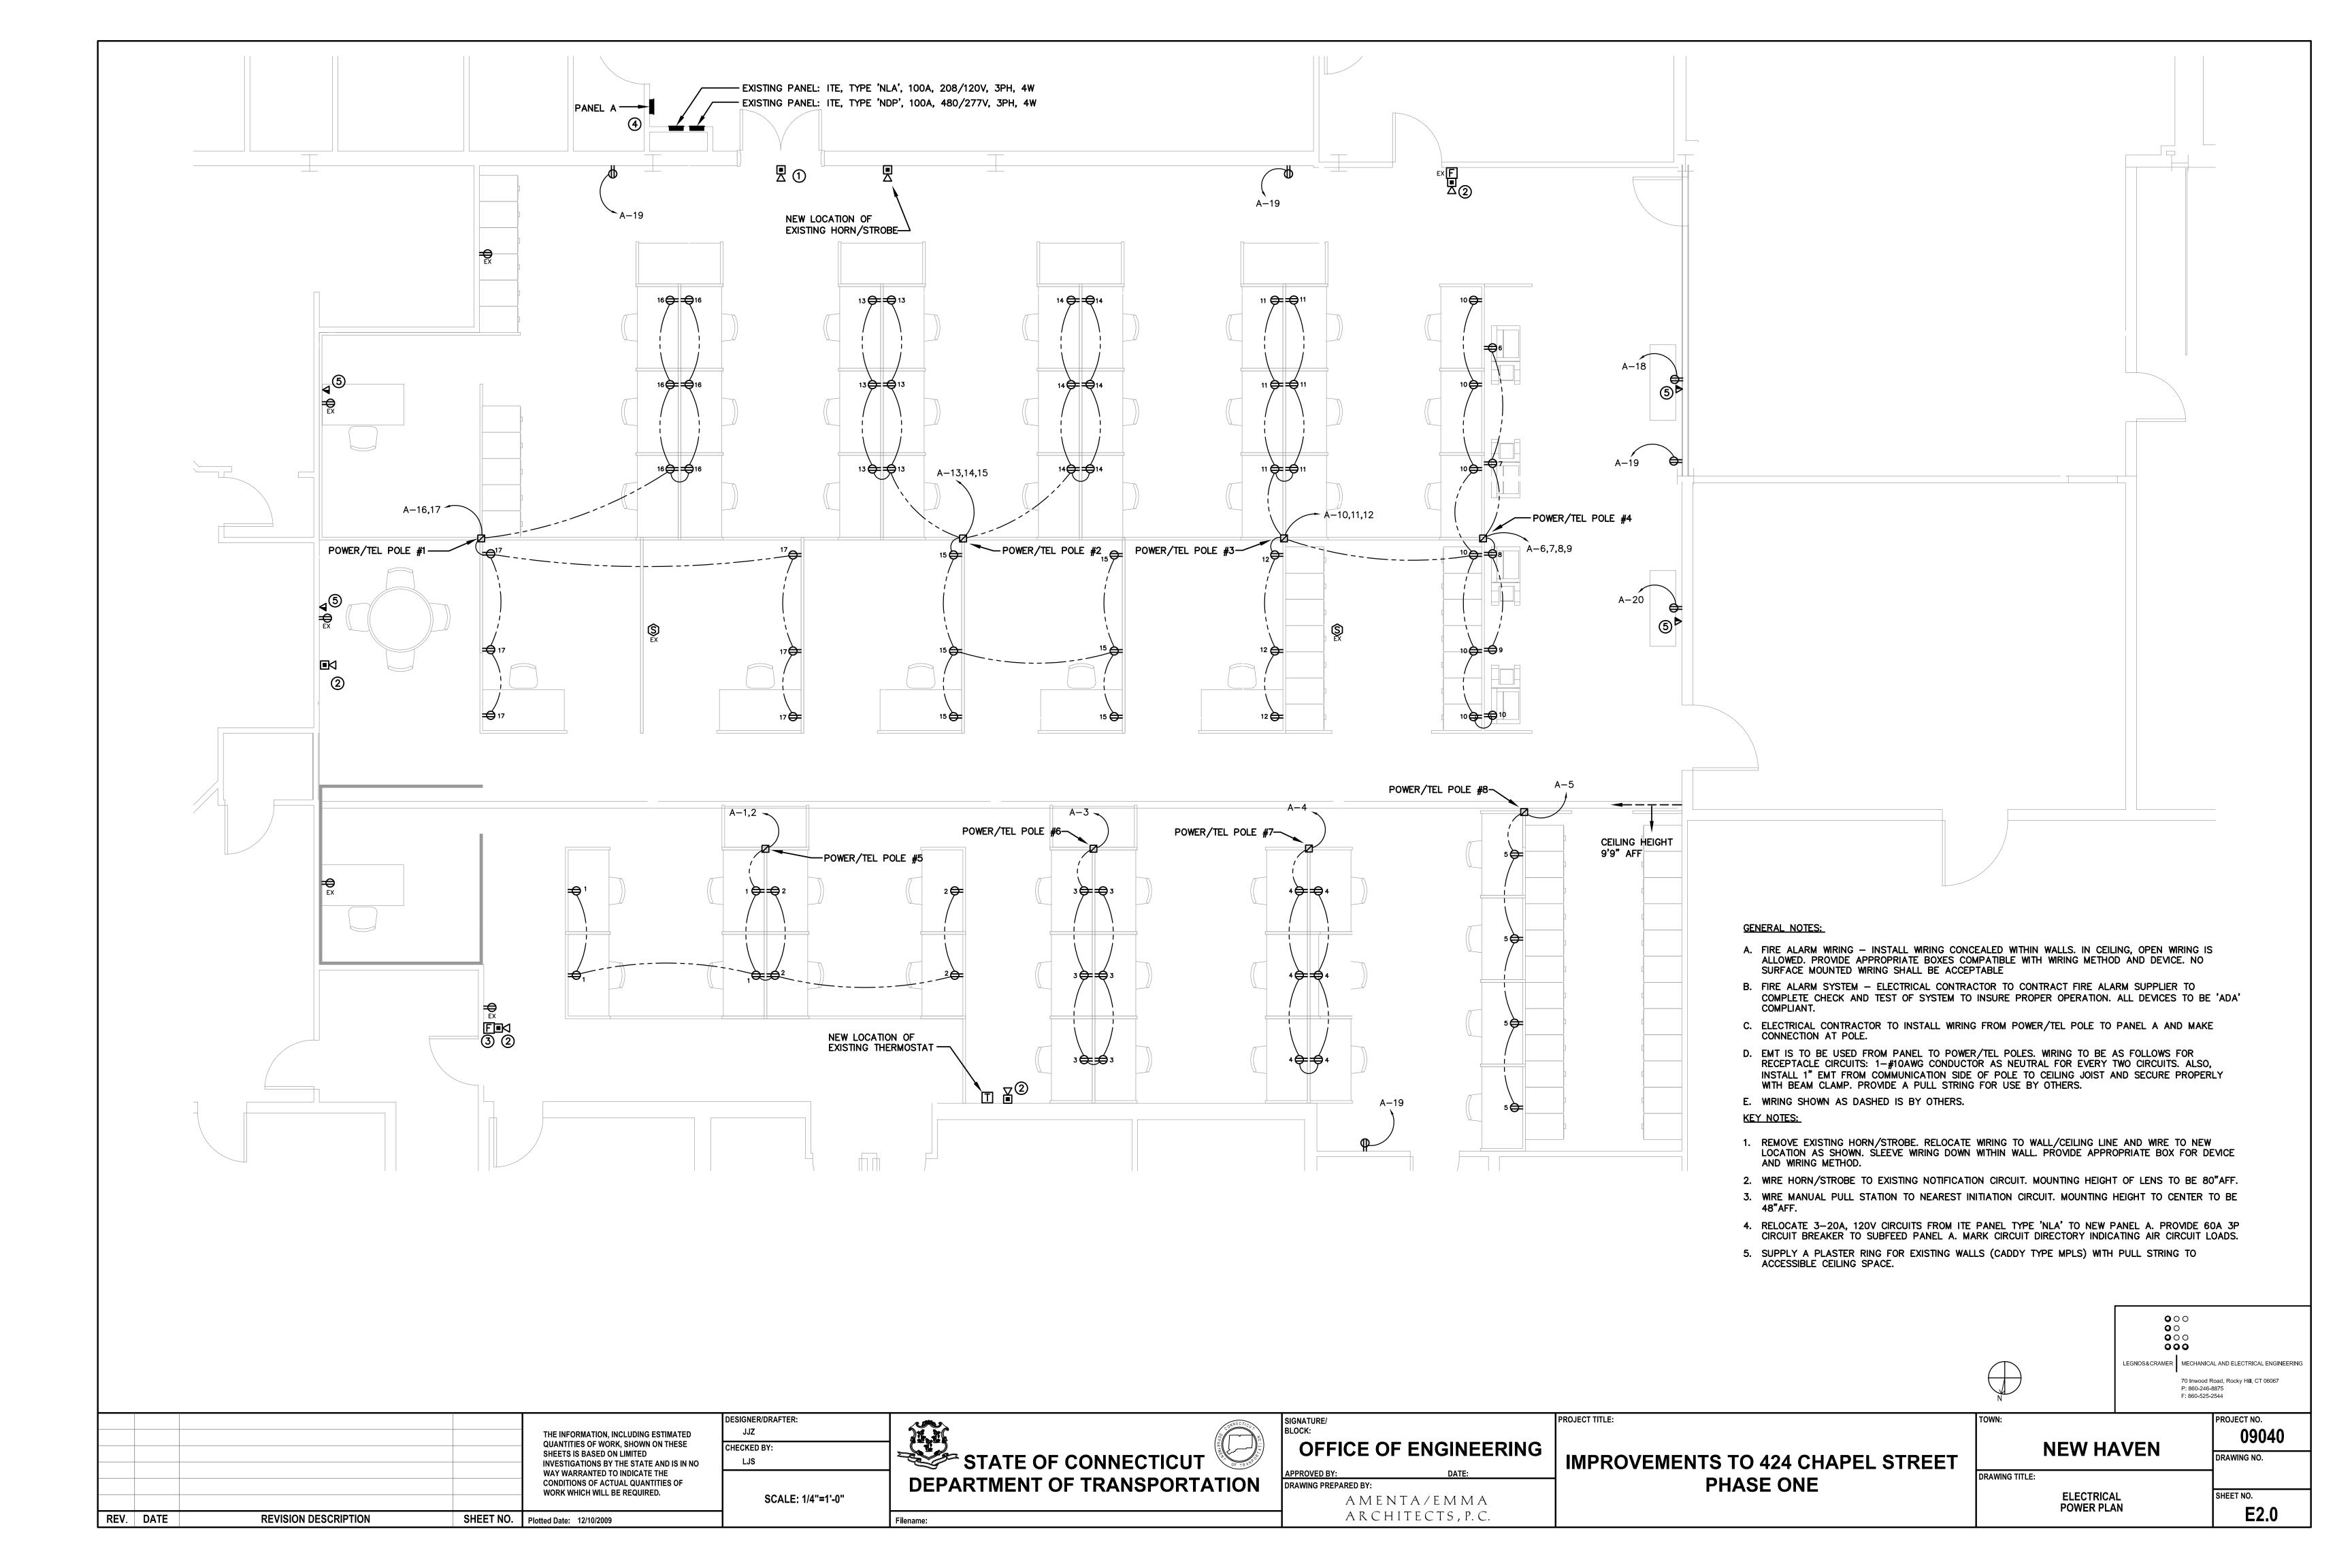

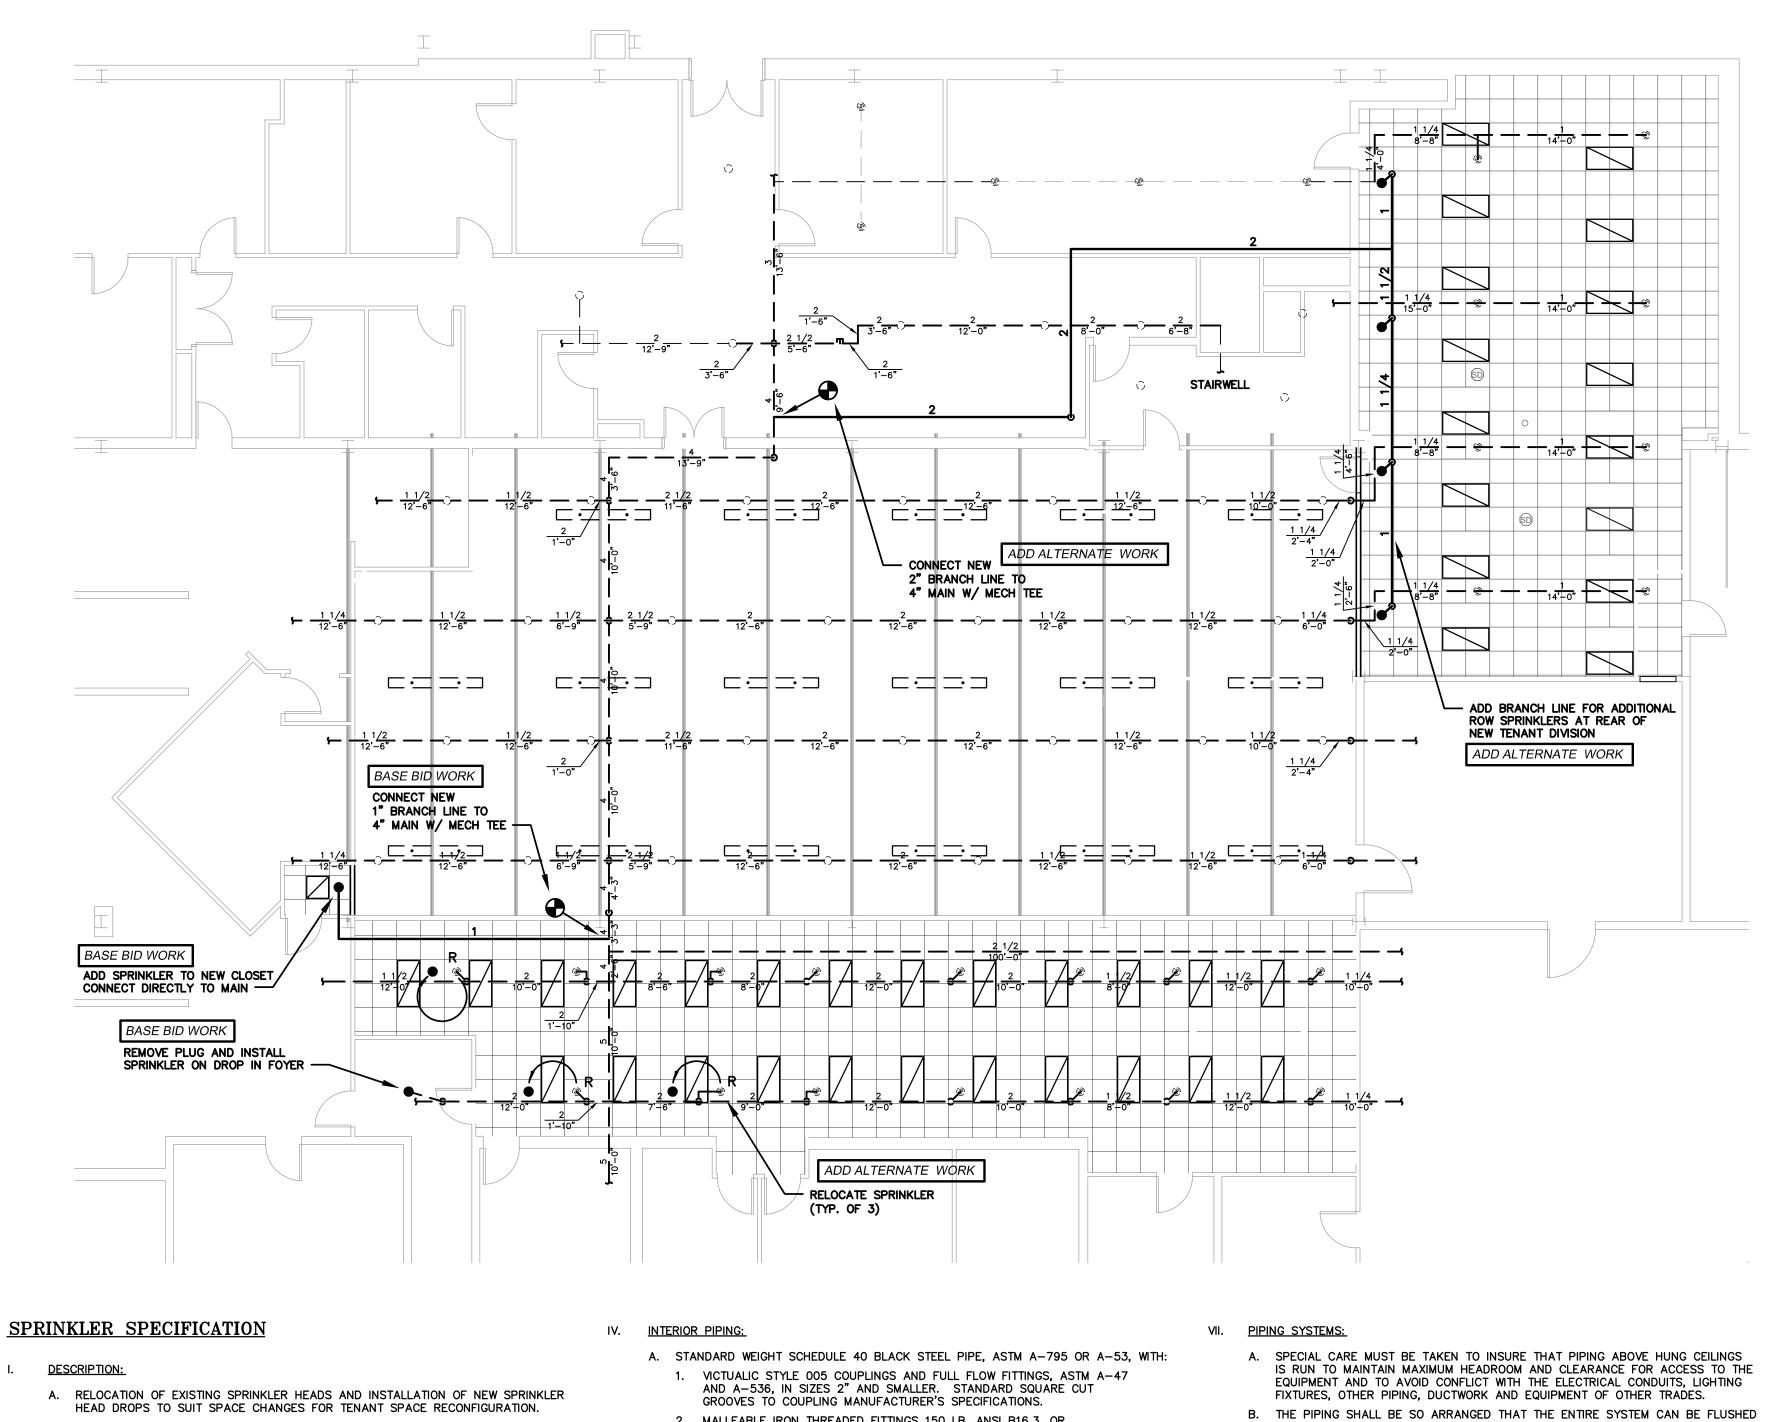

FIRE PROTECTION LEGEND

EXISTING FIRE PROTECTION PIPING WITH SIZE AND LENGTH EXISTING UPRIGHT SPRINKLER EXISTING RECESSED SPRINKLER RELOCATE EXISTING SPRINKLER HEAD DROP WITH A PIPE ARMOVER PROPOSED SPRINKLER PIPING WITH SIZE NEW RECESSED SPRINKLER POINT OF CONNECTION PENDANT FLUORESCENT LIGHT FIXTURE RECESSED FLUORESCENT LIGHT FIXTURE

- B. FURNISH ALL NECESSARY LABOR, MATERIAL, TOOLS, EQUIPMENT, APPURTENANCES, INSTRUMENTS, ETC., NECESSARY TO FULLY COMPLETE THE FIRE PROTECTION SYSTEM IN ACCORDANCE WITH THE PLANS AND SPECIFICATIONS AND BOTH LOCAL AND STATE FIRE CODES AND N.F.P.A. #13.
- II. <u>CONTRACTOR'S RESPONSIBILITIES:</u>
 - A. ALL PERMITS AND FEES.
 - B. HOISTING, RIGGING, TRANSPORTATION COSTS AND INSTALLATION OF NECESSARY APPURTENANCES.
 - C. THE CONTRACTOR SHALL VISIT THE PREMISES AND NOTE ALL PERTINENT FACTS AND DETAILS INCLUDING CONDITIONS UNDER WHICH THE WORK MUST BE CARRIED
 - OUT. NO ALLOWANCE WILL BE MADE FOR FAILURE TO HAVE DONE SO. D. THE FIRE PROTECTION CONTRACTOR SHALL PROVIDE NOTIFICATION OF OUTAGE AND IMPAIRMENT TO THE EXISTING FIRE PROTECTION SYSTEMS TO GENERAL CONTRACTOR, BUILDING OWNER AND LOCAL AUTHORITIES. LEAVE SPRINKLER SYSTEM OPERATIONAL
 - DURING CONSTRUCTION TO GREATEST EXTENT POSSIBLE. E. EXPENSES FOR FIRE WATCHES ARE THE RESPONSIBILITY OF THE FIRE PROTECTION CONTRACTOR.
 - F. HOLES CUTTING AND PATCHING: CUTTING WILL BE BY CORE BORING, PATCHING WILL REQUIRE BOTH WATERPROOFING AND FIREPROOFING.
 - G. DRAWINGS ARE DIAGRAMMATIC; DO NOT SCALE DRAWINGS. MAKE SUCH
 - DEVIATIONS AND OFFSETS AS NECESSARY TO MEET SPACE REQUIREMENTS. H. THE CONTRACTOR SHALL BE RESPONSIBLE FOR WATER DAMAGE TO THE PROPERTY OF THE OWNER, THE WORK OF OTHER TRADES, AND TO EXISTING BUILDING SYSTEMS DURING ALL PHASES OF THE WORK.

III. <u>PRODUCTS:</u>

ALL PIPING, FITTINGS, VALVES, MATERIAL, ETC., TO BE EQUAL TO EXISTING, THE SAME TYPE AND QUALITY.

- 2. MALLEABLE IRON THREADED FITTINGS 150 LB. ANSI B16.3, OR CAST IRON THREADED FITTINGS 250 LB. ANSI B16.4, IN ALL SIZES.
- B. LIGHT WALL PIPE SCHEDULE 10, ASTM A-135, VICTUALIC STYLE 005 COUPLINGS AND FULL FLOW FITTINGS, ASTM A-47 AND A-536, IN SIZES 2-1/2" AND LARGER, WITH ROLLED GROOVES. NO CUT GROOVES OR THREADING WILL BE ALLOWED ON

V. <u>SPRINKLER HEADS:</u>

SPRINKLER HEADS SHALL BE VIKING, RELIABLE, VICTAULIC OR TYCO. EQUAL TO THE FOLLOWING MODEL NUMBER(S) AND TYPE(S):

A. RELIABLE MODEL F1FR RECESSED PENDENT SPRINKLER, 1/2" ORIFICE, 155°F, CHROME PLATED FINISH WITH MODEL F2 CHROME PLATED ESCUTCHEON.

- A. THE COMPLETE SYSTEM SHALL BE INSTALLED IN ACCORDANCE WITH RULES AND REGULATIONS PERTAINING TO LIGHT HAZARD (NOT TO EXCEED 168 SQ.FT. PER HEAD) OCCUPANCY AND COMPLY WITH FULL REQUIREMENTS OF THE REGULATORY AGENGIES. MINIMUM PIPE SIZE SHALL BE AS GIVEN ON THE PLANS OR PIPE SCHEDULE.
- B. THE FIRE PROTECTION CONTRACTOR SHALL PREPARE WORK INSTALLATION DRAWINGS (SHOP DRAWINGS) AND SHALL SUBMIT THEM TO THE ENGINEER AND RATING BUREAU
- C. BEFORE COMMENCING WORK, THE FIRE PROTECTION CONTRACTOR SHALL COORDINATE WITH OTHER TRADES, SO THAT NO POSSIBLE INTERFERENCE WILL OCCUR. IF, DUE TO INADEQUATE COORDINATION, EXTRA WORK IS ENTAILED, THE FIRE PROTECTION CONTRACTOR SHALL BE HELD FULLY RESPONSIBLE.
- 1. EXISTING SPRINKLER SUPPLY MAIN AND BRANCH SPRINKLER PIPING SHALL BE ADJUSTED AS REQUIRED TO CLEAR OTHER WORK AND MAINTAIN NEW CEILING HEIGHTS, AS INDICATED ON THE LATEST ARCHITECTURAL DRAWINGS.

- AND DRAINED THROUGH ACCESSABLE LOW POINTS. PROVIDE AUXILIARY DRAINS
- FOR WATER TRAPPED IN SECTIONS OF PIPE. DRAIN PIPE SHALL BE GALVANIZED. C. RUN PIPING CONCEALED TROUGHOUT FINISHED SPACES, EITHER IN FURRED SPACES, SHAFTS, OR ABOVE FALSE CEILINGS; SUPPORT PIPING PER REQUIREMENTS OF NFPA #13.
- D. VICTAULIC FITTINGS AND COUPLINGS SHALL BE INSTALLED IN ACCORDANCE WITH THE MANUFACTURERS RECOMMENDATIONS.
- E. THE ENDS OF PIPES SHALL BE REAMED FREE FROM BURRS AND KEPT FREE OF SCALE, DIRT AND OIL.
- F. THREADED JOINTS SHALL BE MADE WITH TEFLON LIQUID JOINT COMPOUND APPLIED TO MALE THREADS ONLY.


VIII. <u>INSTALLATION:</u>

- A. SPRINKLER HEADS OF THE PROPER CONFIGURATION AND NUMBERS ARE TO BE INSTALLED AS REQUIRED IN ACCORDANCE WITH REGULATIONS PERTAINING TO LIGHT AND ORDINARY HAZARD AND THE FULL REQUIREMENTS OF THE NFPA, LOCAL FIRE DEPARTMENT, STATE FIRE MARSHAL, FIRE INSURANCE COMPANY, RATING BUREAU AND OTHER AGENCIES HAVING JURISDICTION.
- B. SPRINKLERS WHICH ARE SO LOCATED AS TO BE SUBJECT TO MECHANICAL INJURY (IN EITHER UPRIGHT OR THE PENDANT POSITION) SHALL BE PROTECTED WITH APPROVED GUARDS.
- C. INSTALL HEADS WITH TEFLON LIQUID JOINT COMPOUND APPLIED TO MALE THREADS ONLY.
- D. SPRINKLER HEADS SHALL BE LOCATED IN CENTER OF CEILING TILES EXCEPT WHERE INDICATED OTHERWISE.

IX. <u>TESTING:</u>

- A. TEST ENTIRE SYSTEM AT 200 PSI FOR TWO (2) HOURS AFTER COMPLETION, IN ACCORDANCE WITH NFPA #13.
- B. FURNISH TO THE RATING BUREAU, THE CERTIFICATE COVERING MATERIALS AND
- TESTS AS OUTLINED IN NFPA #13. C. DURING AND AFTER COMPLETION, THE ENTIRE INSTALLATION SHALL BE SUBJECT TO INSPECTION AND TEST BY THE RATING BUREAU.



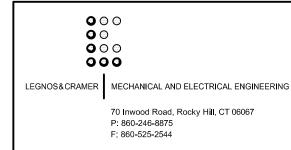

				DESIGNER/DRAFTER:	ONNECT/CO	SIGNATURE/	PROJECT TITLE:	TOWN:	PROJECT NO.
			THE INFORMATION, INCLUDING ESTIMATED QUANTITIES OF WORK, SHOWN ON THESE	GFL		OFFICE OF ENGINEERING	NGINEERING IMPROVEMENTS TO 424 CHAPEL STREET PHASE ONE	NEW HAVEN	09040
			SHEETS IS BASED ON LIMITED INVESTIGATIONS BY THE STATE AND IS IN NO WAY WARRANTED TO INDICATE THE CONDITIONS OF ACTUAL QUANTITIES OF	CHECKED BY: KAH	STATE OF CONNECTICUT				DRAWING NO.
					DEPARTMENT OF TRANSPORTATION	APPROVED BY: DATE: DRAWING PREPARED BY:		DRAWING TITLE:	
			WORK WHICH WILL BE REQUIRED.	SCALE: 1/8"=1'-0"	DEI ARTIMENT OF TRANSFORM	A M E N T A / E M M A	I HAGE ONE	FIRE PROTECTION 2ND FLOOR PLAN	SHEET NO.
REV. DATE	REVISION DESCRIPTION	SHEET NO.	Plotted Date: 12/10/2009	1	Filename:	ARCHITECTS, P. C.		ZNDTEOORTEAN	FP1.0