

# 01.11 - ILLUMINATION INDEX OF SUBSETS

SUBSET NUMBER	SUBSET TITLE	SUBSET NUMBER	SUBSET TITLE
01.11.01	ILLUMINATION SUBSET INDEX		
01.11.02	ILLUMINATION PLANS SUBSET		

THE DESIGN APPEARS TO CONFORM TO APPLICABLE CRITERIA. APPROVAL IS NOT TO BE CONSTRUED TO MEAN THAT ALL ASPECTS OF THE DESIGN HAVE BEEN PERSONALLY CHECKED BY THE UNDERSIGNED.

TRANSPORTATION PRINCIPAL ENGINEER

REV.	DATE	REVISION DESCRIPTION	SHEET NO.

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Plotted Date: 7/10/2018

DESIGNER/DRAFTER: **DR**  
CHECKED BY: **MSB**

**STATE OF CONNECTICUT**  
**DEPARTMENT OF TRANSPORTATION**

Filename: ...\\CT\_FDP\_0063-0703.dgn

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

PROJECT TITLE:  
**RELOCATION OF I-91 NB  
INTERCHANGE 29 AND WIDENING  
OF I-91 NB AND ROUTE 15 NB  
TO I-84 EB**

CITY/TOWN: **HARTFORD  
EAST HARTFORD**  
DRAWING TITLE: **ILLUMINATION  
SUBSET INDEX**

PROJECT NO. **63-703**  
DRAWING NO. **INX-01**  
SHEET NO. **01.11.01.01**

# 01.11.02 - ELECTRICAL- ILLUMINATION INDEX OF DRAWINGS

DRAWING NUMBER	DRAWING TITLE	DRAWING NUMBER	DRAWING TITLE
ILL-01	INDEX OF DRAWINGS		
ILL-02	LEGEND AND GENERAL NOTES		
ILL-03 TO ILL-05	INDEX PLANS		
ILL-06 TO ILL-24	ILLUMINATION PLANS		
ILL-25	CONCRETE HANDHOLES		
ILL-26	ELECTRICAL CONNECTIONS		
ILL-27	LIGHT STANDARD AND FOUNDATION		
ILL-28	UNDERBRIDGE LUMINAIRES		
ILL-29	BRIDGE INSPECTION RECEPTACLES		
ILL-30	MEDIAN ELECTRICAL DETAILS		

<small>REV.</small>	<small>DATE</small>	<small>REVISION DESCRIPTION</small>	<small>SHEET NO.</small>	<small>Plotted Date:</small> 7/10/2018	<small>DESIGNER/DRAFTER:</small> DDR	<small>CHECKED BY:</small> MSB	 <b>STATE OF CONNECTICUT DEPARTMENT OF TRANSPORTATION</b>	<small>SIGNATURE/BLOCK:</small> 	<small>PROJECT TITLE:</small> <b>RELOCATION OF I-91 NB INTERCHANGE 29 AND WIDENING OF I-91 NB AND ROUTE 5/15 NB TO I-84 EB</b>	<small>CITY/TOWN:</small> HARTFORD EAST HARTFORD	<small>PROJECT NO.</small> 63-703	<small>DRAWING NO.</small> ILL-01	<small>SHEET NO.</small> 01.11.02.01
				<small>THE INFORMATION, INCLUDING ESTIMATED QUANTITIES OF WORK SHOWN ON THESE SHEETS IS BASED ON LIMITED INVESTIGATIONS BY THE STATE AND IS IN NO WAY WARRANTED TO INDICATE THE CONDITIONS OF ACTUAL QUANTITIES OF WORK WHICH WILL BE REQUIRED.</small>			<small>Filename:</small> ...VHW_MSH_0063_0703_04_07_ILL-01.dgn			<small>DRAWING TITLE:</small> <b>ELECTRICAL-ILLUMINATION INDEX OF DRAWINGS</b>			

## ILLUMINATION LEGEND

	ALUMINUM LIGHT STANDARD (TRANSFORMER BASE) AND FOUNDATION (SEE NOTE 22)
	EXISTING LIGHT STANDARD TO REMAIN - REMOVE HPS LUMINAIRE AND INSTALL LED LUMINAIRE AS INDICATED
	EXISTING LIGHT STANDARD, FOUNDATION, AND LUMINAIRE TO BE REMOVED
	EXISTING STRUCTURE MOUNTED LIGHT STANDARD TO BE REMOVED
	ALUMINUM LIGHT STANDARD (STRUCTURE MOUNTED)
	EXISTING LIGHT STANDARD ON STRUCTURE TO REMAIN - REMOVE HPS LUMINAIRE AND INSTALL LED LUMINAIRE AS INDICATED
	LED LUMINAIRE (3,750 - 4,750 LUMEN, TYPE II DIST., FULL-CUTOFF)
	LED ROADWAY LUMINAIRE - TYPE 1 (12,000* LUMEN, TYPE II DIST., FULL-CUTOFF, 30' MOUNTING HEIGHT)
	LED ROADWAY LUMINAIRE - TYPE 1 (12,000* LUMEN, TYPE III DIST., FULL-CUTOFF, 40' MOUNTING HEIGHT)
	LED ROADWAY LUMINAIRE - TYPE 2 (16,000* LUMEN, TYPE II DIST., FULL-CUTOFF, 40' MOUNTING HEIGHT)
	LED ROADWAY LUMINAIRE - TYPE 3 (20,000* LUMEN, TYPE II DIST., FULL-CUTOFF, 40' MOUNTING HEIGHT)
	ROADWAY LUMINAIRE (200 WATT HPS, 22,000 LUMEN, TYPE 11 DIST., FULL-CUTOFF, 30' MOUNTING HEIGHT)
	EXISTING LIGHT STANDARD AND POLE TO BE RELOCATED TO NEW FOUNDATION
	EXISTING FOUNDATION MOUNTED ALUMINUM LIGHT STANDARD TO REMAIN
	UNDERBRIDGE LUMINAIRE - LED (WALL MOUNTED)
	UNDERBRIDGE LUMINAIRE - LED (PENDENT MOUNTED)
	REMOVE UNDERBRIDGE LUMINAIRE
	CONCRETE HANDHOLE (TYPE I)
	EXISTING CONCRETE HANDHOLE TO REMAIN
	EXISTING CONCRETE HANDHOLE TO BE REMOVED
	18" X 12" X 8" CAST IRON JUNCTION BOX
	EXISTING CAST IRON JUNCTION BOX TO REMAIN (U.O.N)
	16" X 14" X 6" NON-METALLIC JUNCTION BOX
	EXISTING LIGHTING CONTROL CABINET TO REMAIN
	FIBERGLASS RISER CONDUIT
	CABLE IN DUCT (3 #2 CONDUCTORS, 1 #8 BARE GND.)
	2" RIGID METAL CONDUIT IN STRUCTURE (3 #2, 1 #8 BARE GND., (U.O.N.))
	2 1/2" FIBERGLASS CONDUIT UNDER ROADWAY (3#2 & 1#8 BARE GND., (U.O.N.))
	2 1/2" FIBERGLASS CONDUIT IN MEDIAN (3 #2, 1 #8 BARE GND., (U.O.N.))
	2 1/2" FIBERGLASS CONDUIT IN TRENCH (3 #2, 1 #8 BARE GND., (U.O.N.))
	FIBERGLASS CONDUIT - SURFACE, (CONDUIT SIZE AND QUANTITY OF CONDUCTORS AS INDICATED ON PLANS)
	3" POLYVINYL CHLORIDE CONDUIT (PVC) IN TRENCH
	EXISTING RIGID METAL CONDUIT - SURFACE MOUNTED
	EXISTING RIGID METAL CONDUIT AND CONDUCTORS IN STRUCTURE TO REMAIN (U.O.N.)
	EXISTING UNDERGROUND CIRCUITRY TO REMAIN

## ABBREVIATIONS


RMC	RIGID METAL CONDUIT
FGC	FIBERGLASS CONDUIT
LTFCM	LIQUID TIGHT FLEXIBLE METAL CONDUIT
LFNC	LIQUID TIGHT FLEXIBLE NON-METALLIC CONDUIT
C1JB	CAST IRON JUNCTION BOX
U.O.N.	UNLESS OTHERWISE NOTED
CCHH	CONCRETE HANDHOLE
E.O.R.	EDGE OF ROADWAY

\* APPROXIMATE LUMEN VALUE

## GENERAL NOTES


- THE CONTRACTOR SHALL ORGANIZE HIS WORK SO THAT ANY PORTION OF THE ROADWAY WHICH HAS EXISTING ILLUMINATION AND IS OPEN FOR USE REMAINS LIGHTED. THE LIGHTING MAY CONSIST OF: 1) EXISTING LIGHTING, 2) NEW LIGHTING, 3) TEMPORARY LIGHTING, OR ANY COMBINATION OF THE ABOVE. IT IS THE CONTRACTOR'S RESPONSIBILITY TO STAGE THE INSTALLATION OF NEW LIGHTING AND SERVICE CABINETS SO THAT ALL ROADWAYS WITH EXISTING ILLUMINATION ARE CONTINUOUSLY LIGHTED. IF IT IS NECESSARY TO INSTALL TEMPORARY POLES, LIGHTS OR CIRCUITRY, THAT WORK SHALL BE SUBMITTED FOR APPROVAL TO THE ENGINEER PRIOR TO INSTALLATION, AND WILL BE PAID FOR AT THE BID UNIT PRICE FOR THESE ITEMS. WHERE INSTALLED, TEMPORARY LIGHTING SHALL BE SPACED SO AS TO MAINTAIN EXISTING ROADWAY LIGHTING AND UNIFORMITY LEVELS. THE CONTRACTOR SHALL MAINTAIN ALL LIGHTING THROUGHOUT THE DURATION OF THE PROJECT. SEE SECTION 10.00.14 FOR SPECIFIC REQUIREMENTS.
- ALL ELECTRICAL WORK SHALL CONFORM TO THE NATIONAL ELECTRIC CODE, CONNECTICUT STANDARD SPECIFICATIONS, AND WHERE APPLICABLE, UTILITY COMPANY REGULATIONS.
- ALL "COBRA HEAD" TYPE ROADWAY LUMINAIRES SHALL BE RATED I.E.S. FULL-CUTOFF (BUG UPLIGHT RATED U0).
- CONDUCTORS SHALL BE COPPER, INSULATION TYPE XHHW AND RATED FOR 600 VOLTS. INSULATION SHALL BE COLORED CROSS LINKED POLYETHYLENE (XLP). THREE PHASE CIRCUIT COLORS SHALL BE AS FOLLOWS: BLUE, BLACK, RED. SINGLE PHASE COLORS SHALL BE BLACK, RED AND WHITE.
- INSTALL ONE NUMBER 8 BARE COPPER GROUNDING CONDUCTOR THROUGHOUT ALL LIGHTING CIRCUITS.
- LOCATION OF EXISTING ILLUMINATION ON PLANS IS APPROXIMATE.
- TAPE ALL UNUSED CONDUCTORS.
- FOR EXISTING ILLUMINATION SEE THE FOLLOWING STATE PROJECTS: 63-458, 63-433, 63-434, 159-173, 42-246, AND 42-311.
- THE CONTRACTOR SHALL ABIDE BY THE CONNDOT LOCKOUT/TAGOUT PROCEDURES WHEN ACCESS TO A CIRCUIT IS REQUIRED. THE CONTRACTOR SHALL CONTACT THE DISTRICT ELECTRICAL SUPERVISOR AT TELEPHONE (860) 566-3156, WHEN ACCESS TO A CIRCUIT IS REQUIRED.
- IN AREAS WHERE EXISTING LIGHT STANDARDS ARE TO BE REMOVED, EXISTING UNDERGROUND CABLE IN DUCT OR NON-METALLIC SHEATHED CABLE WHICH WILL NO LONGER BE USED, SHALL BE DISCONNECTED AND ABANDONED IN PLACE.
- WHERE EXISTING R.M.C. IS TO BE RE-USED, THE CONTRACTOR SHALL REMOVE AND DISPOSE OF ALL EXISTING CONDUCTORS WITHIN THE CONDUIT.
- PRIOR TO TRENCHING THE CONTRACTOR SHALL CONTACT "CALL BEFORE YOU DIG" AND CONNDOT DISTRICT 1 ELECTRICAL MAINTENANCE (860-566-3156) TO HAVE ALL EXISTING UNDERGROUND ELECTRICAL FACILITIES PROPERLY MARKED OUT INCLUDING BUT NOT LIMITED TO: TRAFFIC SIGNAL AND INTERCONNECT CABLES, INCIDENT MANAGEMENT SYSTEM AND FIBER OPTIC CABLES, AND EXISTING ILLUMINATION CIRCUITS. THE CONTRACTOR SHALL BE RESPONSIBLE FOR REPAIR OR REPLACEMENT OF ALL EXISTING FACILITIES DAMAGED BY HIS TRENCHING OPERATION.
- LIGHT STANDARD FOUNDATIONS SHALL BE INSTALLED AS FOLLOWS (DISTANCE TO CENTERLINE OF POLE) OR AS INDICATED ON THE PLANS.
  - A - TYPE I FOUNDATION INSTALLED 7' FROM EDGE OF PAVEMENT, TO CENTERLINE OF FOUNDATION
  - B - TYPE I FOUNDATION INSTALLED 2' BEHIND GUIDE RAIL, OR 4' FROM EDGE OF PAVEMENT WHERE NO GUIDERAIL IS PRESENT, TO CENTERLINE OF FOUNDATION
  - C - ANCHOR BASE MOUNTED ON BRIDGE WALL
  - D - TYPE III FOUNDATION CENTERED BETWEEN MEDIAN BARRIERS
  - E - TYPE I FOUNDATION INSTALLED WITH SPECIAL OFFSET AS INDICATED ON PLANS
- ALL CONDUCTOR SPLICES IN CONCRETE HANDHOLES SHALL BE MADE WITH INSULATED SUBMERSIBLE CONNECTORS.
- QUANTITY OF "EXISTING HANDHOLES TO BE REMOVED" AS INDICATED ON PLANS IS APPROXIMATE. ADDITIONAL "NON-DOCUMENTED" HANDHOLES MAY BE ENCOUNTERED IN THE FIELD. THE CONTRACTOR SHALL REMOVE ALL EXISTING HIGHWAY LIGHTING HANDHOLES WHICH ARE NOT TO BE RE-USED AS INDICATED ON THE PLANS.
- EXISTING LIGHT STANDARD FOUNDATIONS WHICH ARE TO BE REMOVED IN AREAS WHERE ACTIVE 4" I.M.S. INNERDUCT IS PRESENT, MAY BE DEMOLISHED TO A POINT 4" BELOW FINISHED GRADE AND LEFT IN PLACE SO AS NOT TO DISTURB THE BURIED I.M.S. CONDUIT. THE CONTRACTOR SHALL IDENTIFY THESE FOUNDATIONS TO THE ENGINEER AND APPLY FOR APPROVAL TO PERFORM THIS DEMOLITION IN LIEU OF REMOVAL.
- WHEN TRENCHING AND INSTALLING CONDUIT ACROSS ESTABLISHED ENTRANCE/EXIT RAMP, THE CONTRACTOR SHALL RECONSTRUCT THE ROADWAY TO MATCH EXISTING PAVEMENT STRUCTURE. ALL TRENCHES IN PAVED AREAS SHALL HAVE A MINIMUM OF 12" OF PROCESSED AGGREGATE AS A SUB-BASE LAYER. THE COST OF THIS WORK SHALL BE INCLUDED IN THE CONTRACT ITEM FOR "TRENCHING AND BACKFILLING" (ITEM NO. 1001001).
- ALL PVC CONDUIT SHALL BE SCHEDULE 80. 2 1/2" FIBERGLASS CONDUIT IN MEDIAN SHALL BE STANDARD WALL (0.070" WALL THICKNESS). 2 1/2" FIBERGLASS CONDUIT IN TRENCH, UNDER ROADWAY AND SURFACE MOUNTED SHALL BE EXTRA-HEAVY WALL (0.250" WALL THICKNESS). ALL 3/4" FIBERGLASS CONDUIT SHALL BE STANDARD WALL (0.070" WALL THICKNESS).
- THE CONTRACTOR SHALL CONTACT XU LIN AT EVERSOURCE (TEL: 860-280-2256 EMAIL: XU.LIN@EVERSOURCE.COM) TO COORDINATE THE RELOCATION OF THE MAIN STREET SERVICE CABINET FEED.
- THE CONTRACT ESTIMATE CALLS FOR THE FOLLOWING NUMBER OF SPARE LUMINAIRES OF EACH LUMINAIRE TYPE:
  - A) LED LUMINAIRE - 2
  - B) LED LUMINAIRE TYPE 1 - 10
  - C) LED LUMINIARE TYPE 2 - 10
  - D) LED LUMINIARE TYPE 3 - 10

SPARE LED LUMINAIRES SHALL BE DELIVERED TO CONNDOT DISTRICT 1 ELECTRICAL MAINTENANCE LOCATED ON JENNINGS ROAD IN HARTFORD. THE CONTRACTOR SHALL CONTACT MR. AUGUSTO GRAZUNA (860-566-3156) TO ARRANGE A DELIVERY DATE AND TIME. THE CONTRACTOR SHALL PROVIDE ALL LABOR REQUIRED TO TRANSPORT AND DELIVER THE LUMINAIRES. UPON TRANSFER, THE ENGINEER SHALL PROVIDE THE CONTRACTOR WITH A SIGNED RECIEPT FOR THE MATERIALS. THE COST FOR DELIVERY AND TRANSPORT SHALL BE INCLUDED IN THE "EACH" ITEM COST FOR THE LUMINAIRES IN LIEU OF INSTALLATION.
- EXISTING LIGHTING CONTROL CABINET LOCATION/TYPES ARE AS FOLLOWS:
  - I-91 - AIRPORT ROAD, HARTFORD - 480V, 3 PHASE, 3 WIRE.
  - RTE. 15 - MAIN STREET, EAST HARTFORD - 480V, 3 PHASE, 3 WIRE.
  - RTE. 15 & I-84 - CLEMENT ROAD, EAST HARTFORD - 480V, 3 PHASE, 3 WIRE.
  - RTE. 15 - FOLLY BROOK BOULEVARD, WETHERSFIELD - 480V, 3 PHASE, 3 WIRE.
- LIGHT STANDARD FOUNDATIONS INSTALLED BETWEEN MEDIAN BARRIERS SHALL BE TYPE III. ALL OTHERS TO BE TYPE I.

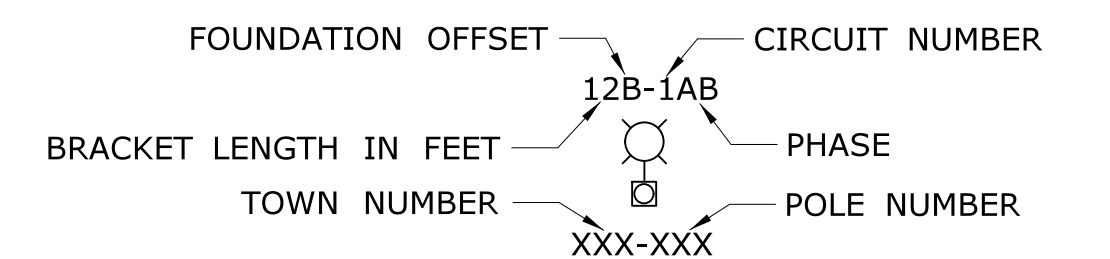

## TYPICAL ILLUMINATION UNIT

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REV.	DATE	REVISION DESCRIPTION	SHEET NO.	Plotted Date: 5/14/2018	Filename: ...JHW_MSH_0063_0703_04-07_ILL-02.dgn					01.11.02.02

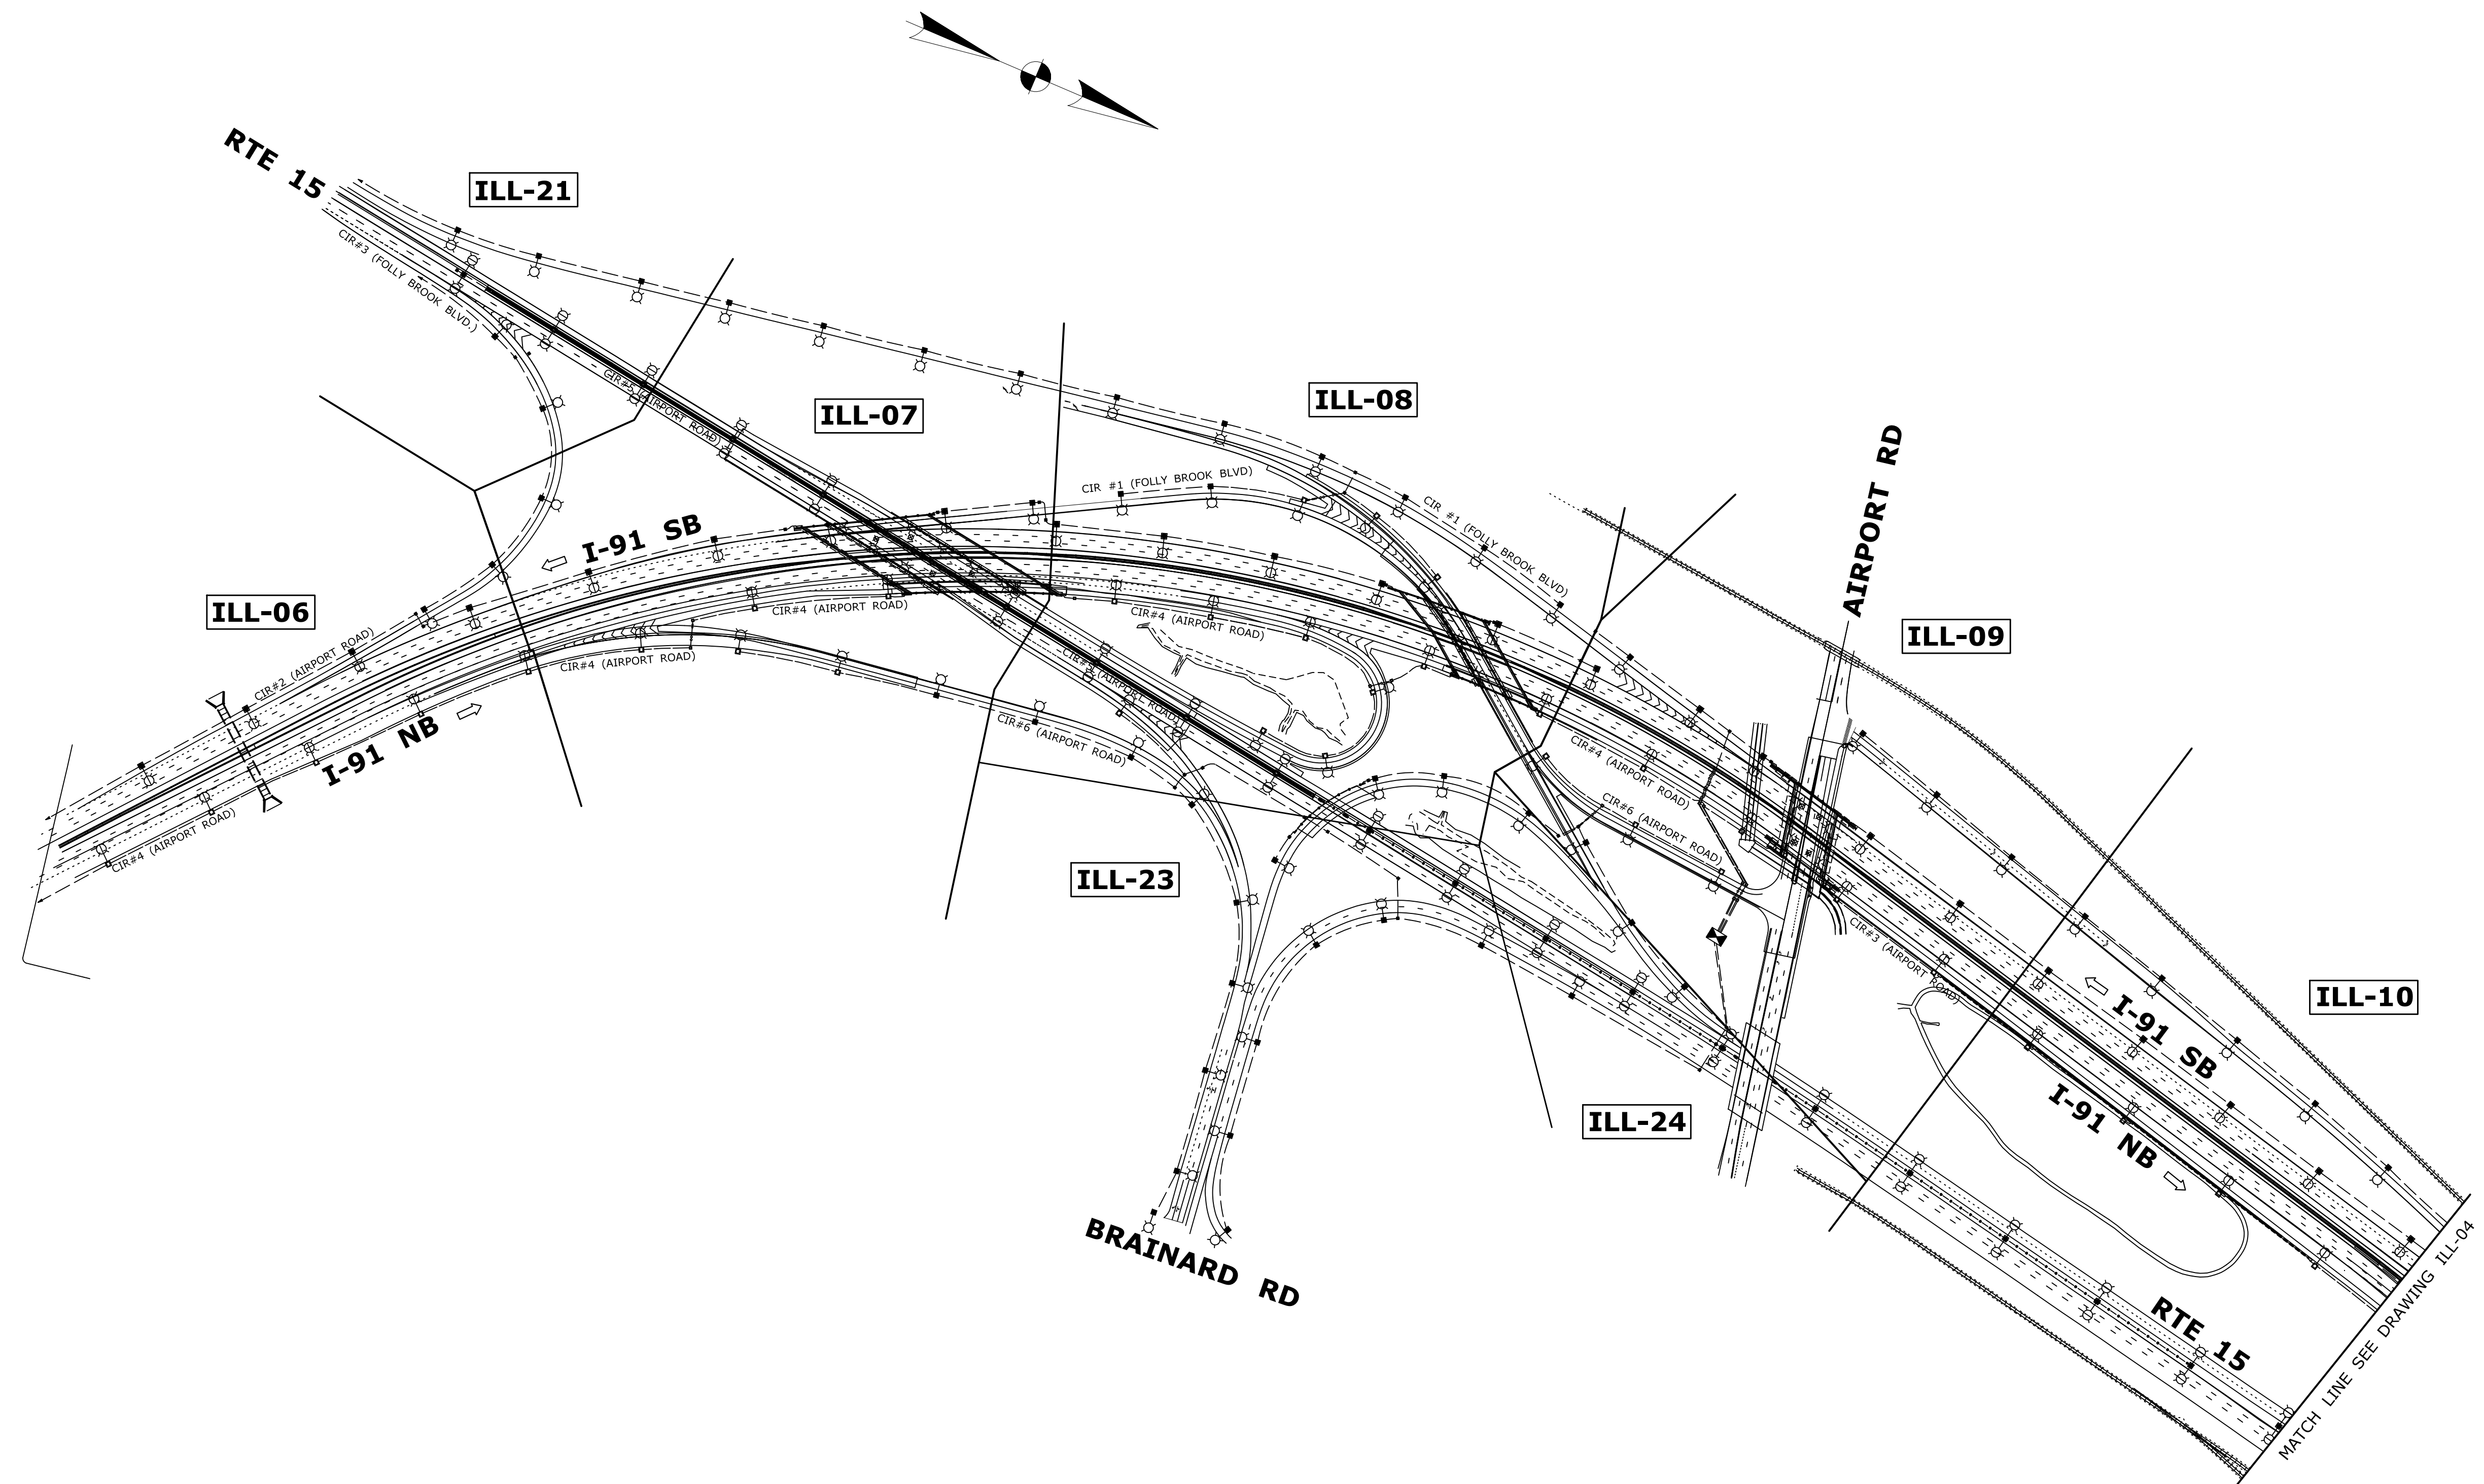

REV.	DATE	REVISION DESCRIPTION	SHEET NO.


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Plotted Date: 3/9/2018

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BLOCK:  
OFFICE OF ENGINEERING

APPROVED BY:  
*Chapman*

PROJECT TITLE:  
**RELOCATION OF I-91 NB  
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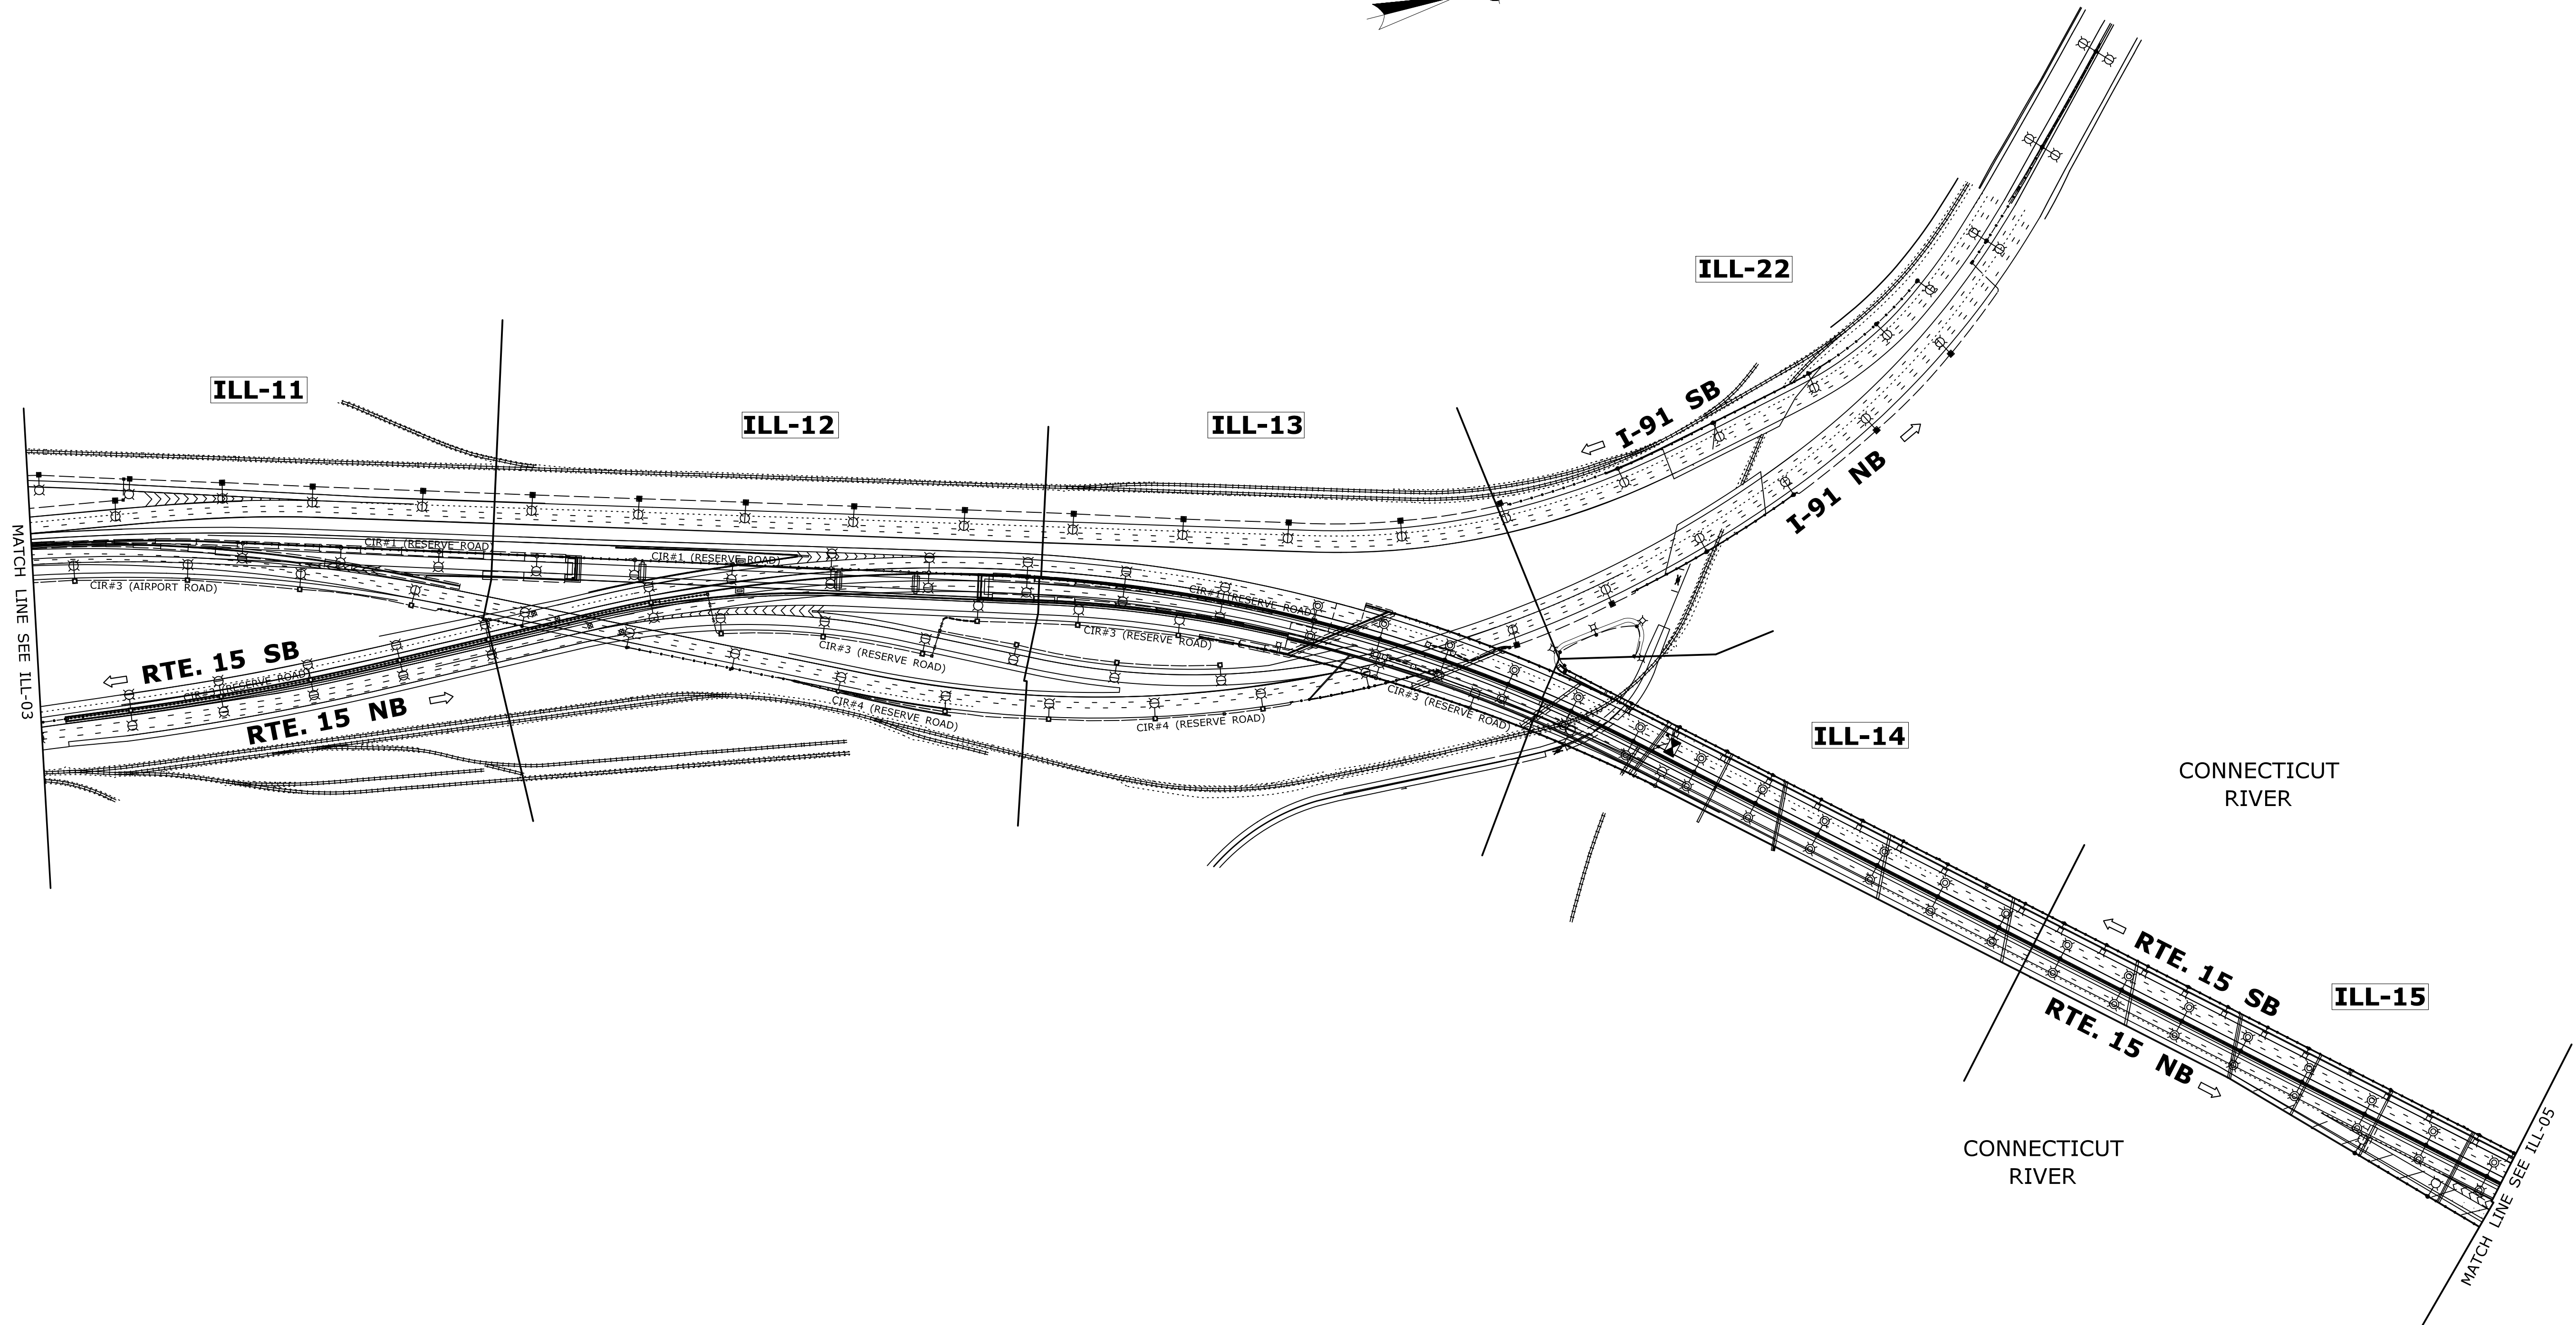
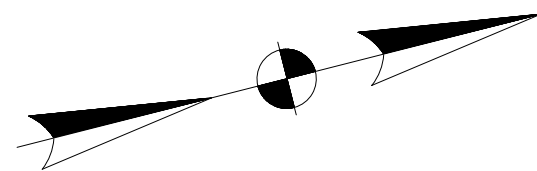
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**HARTFORD &  
EAST HARTFORD**

DRAWING TITLE:  
**INDEX PLAN**

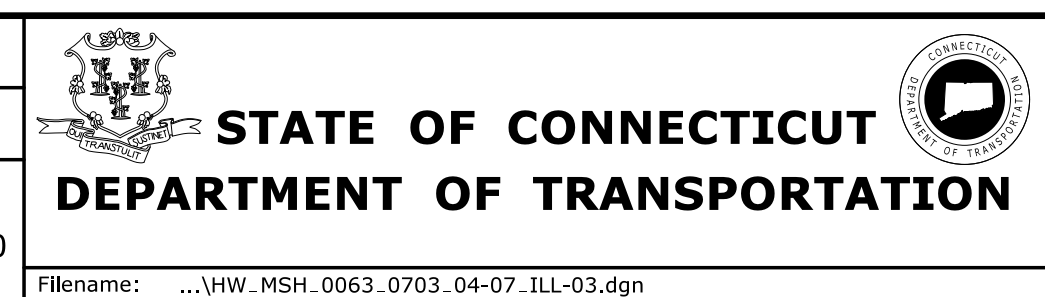
PROJECT NO.  
**63-703**

DRAWING NO.  
**ILL-03**

SHEET NO.  
01.11.02.03



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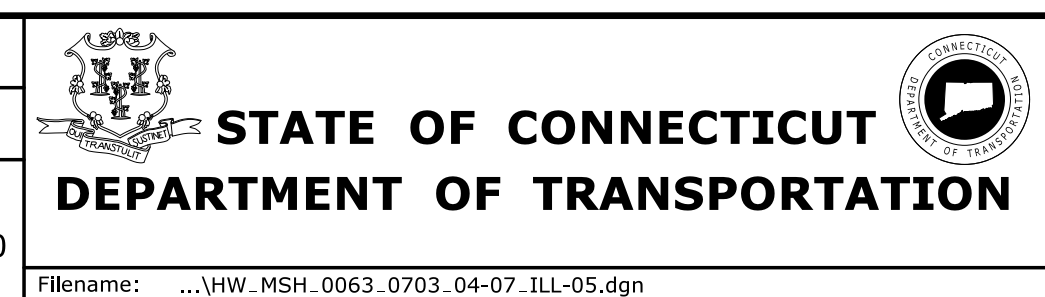
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APPROVED BY:

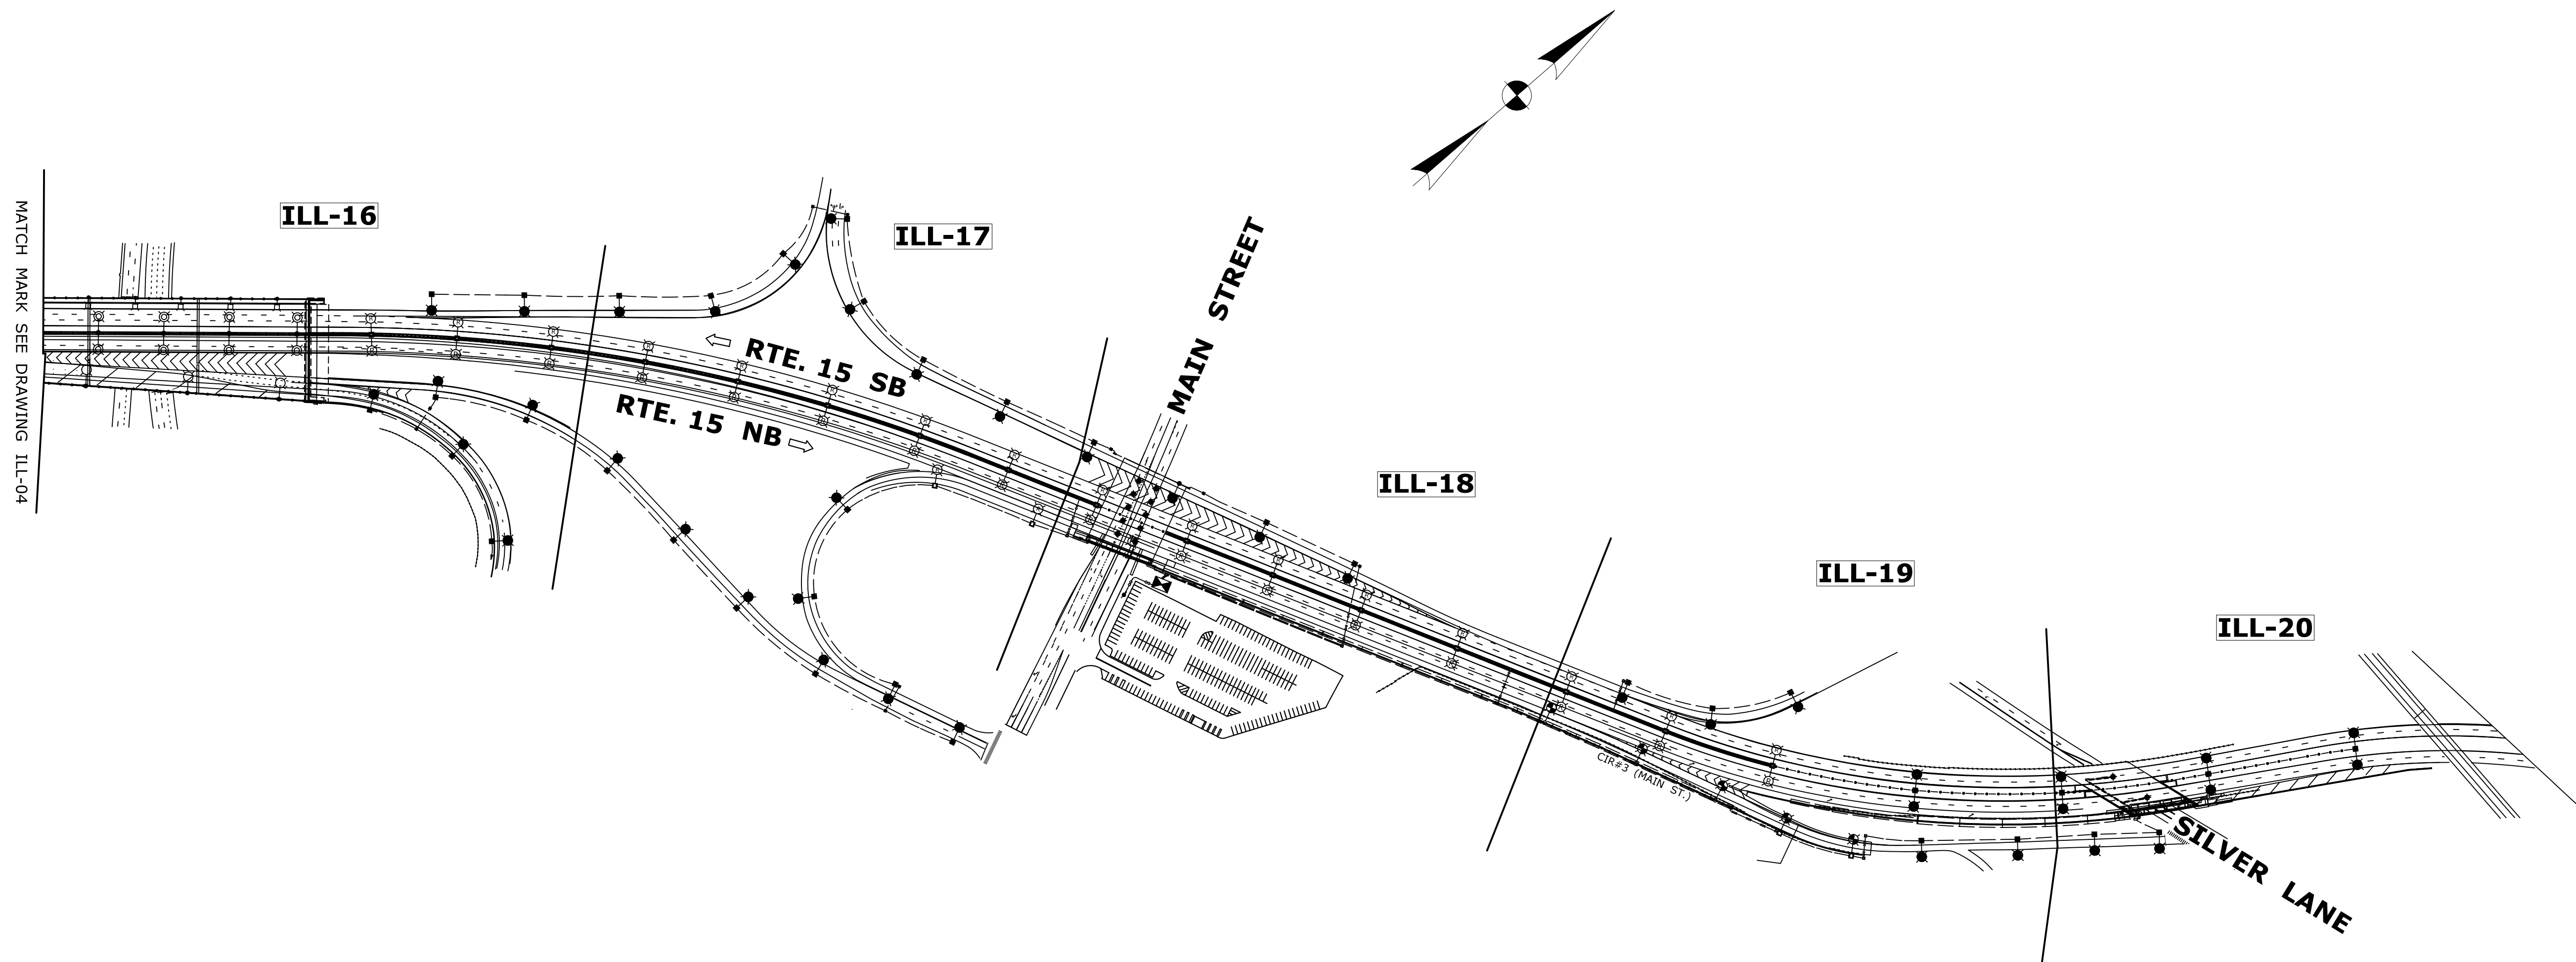*Chapman*

PROJECT TITLE:

**RELOCATION OF I-91 NB  
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TOWN:

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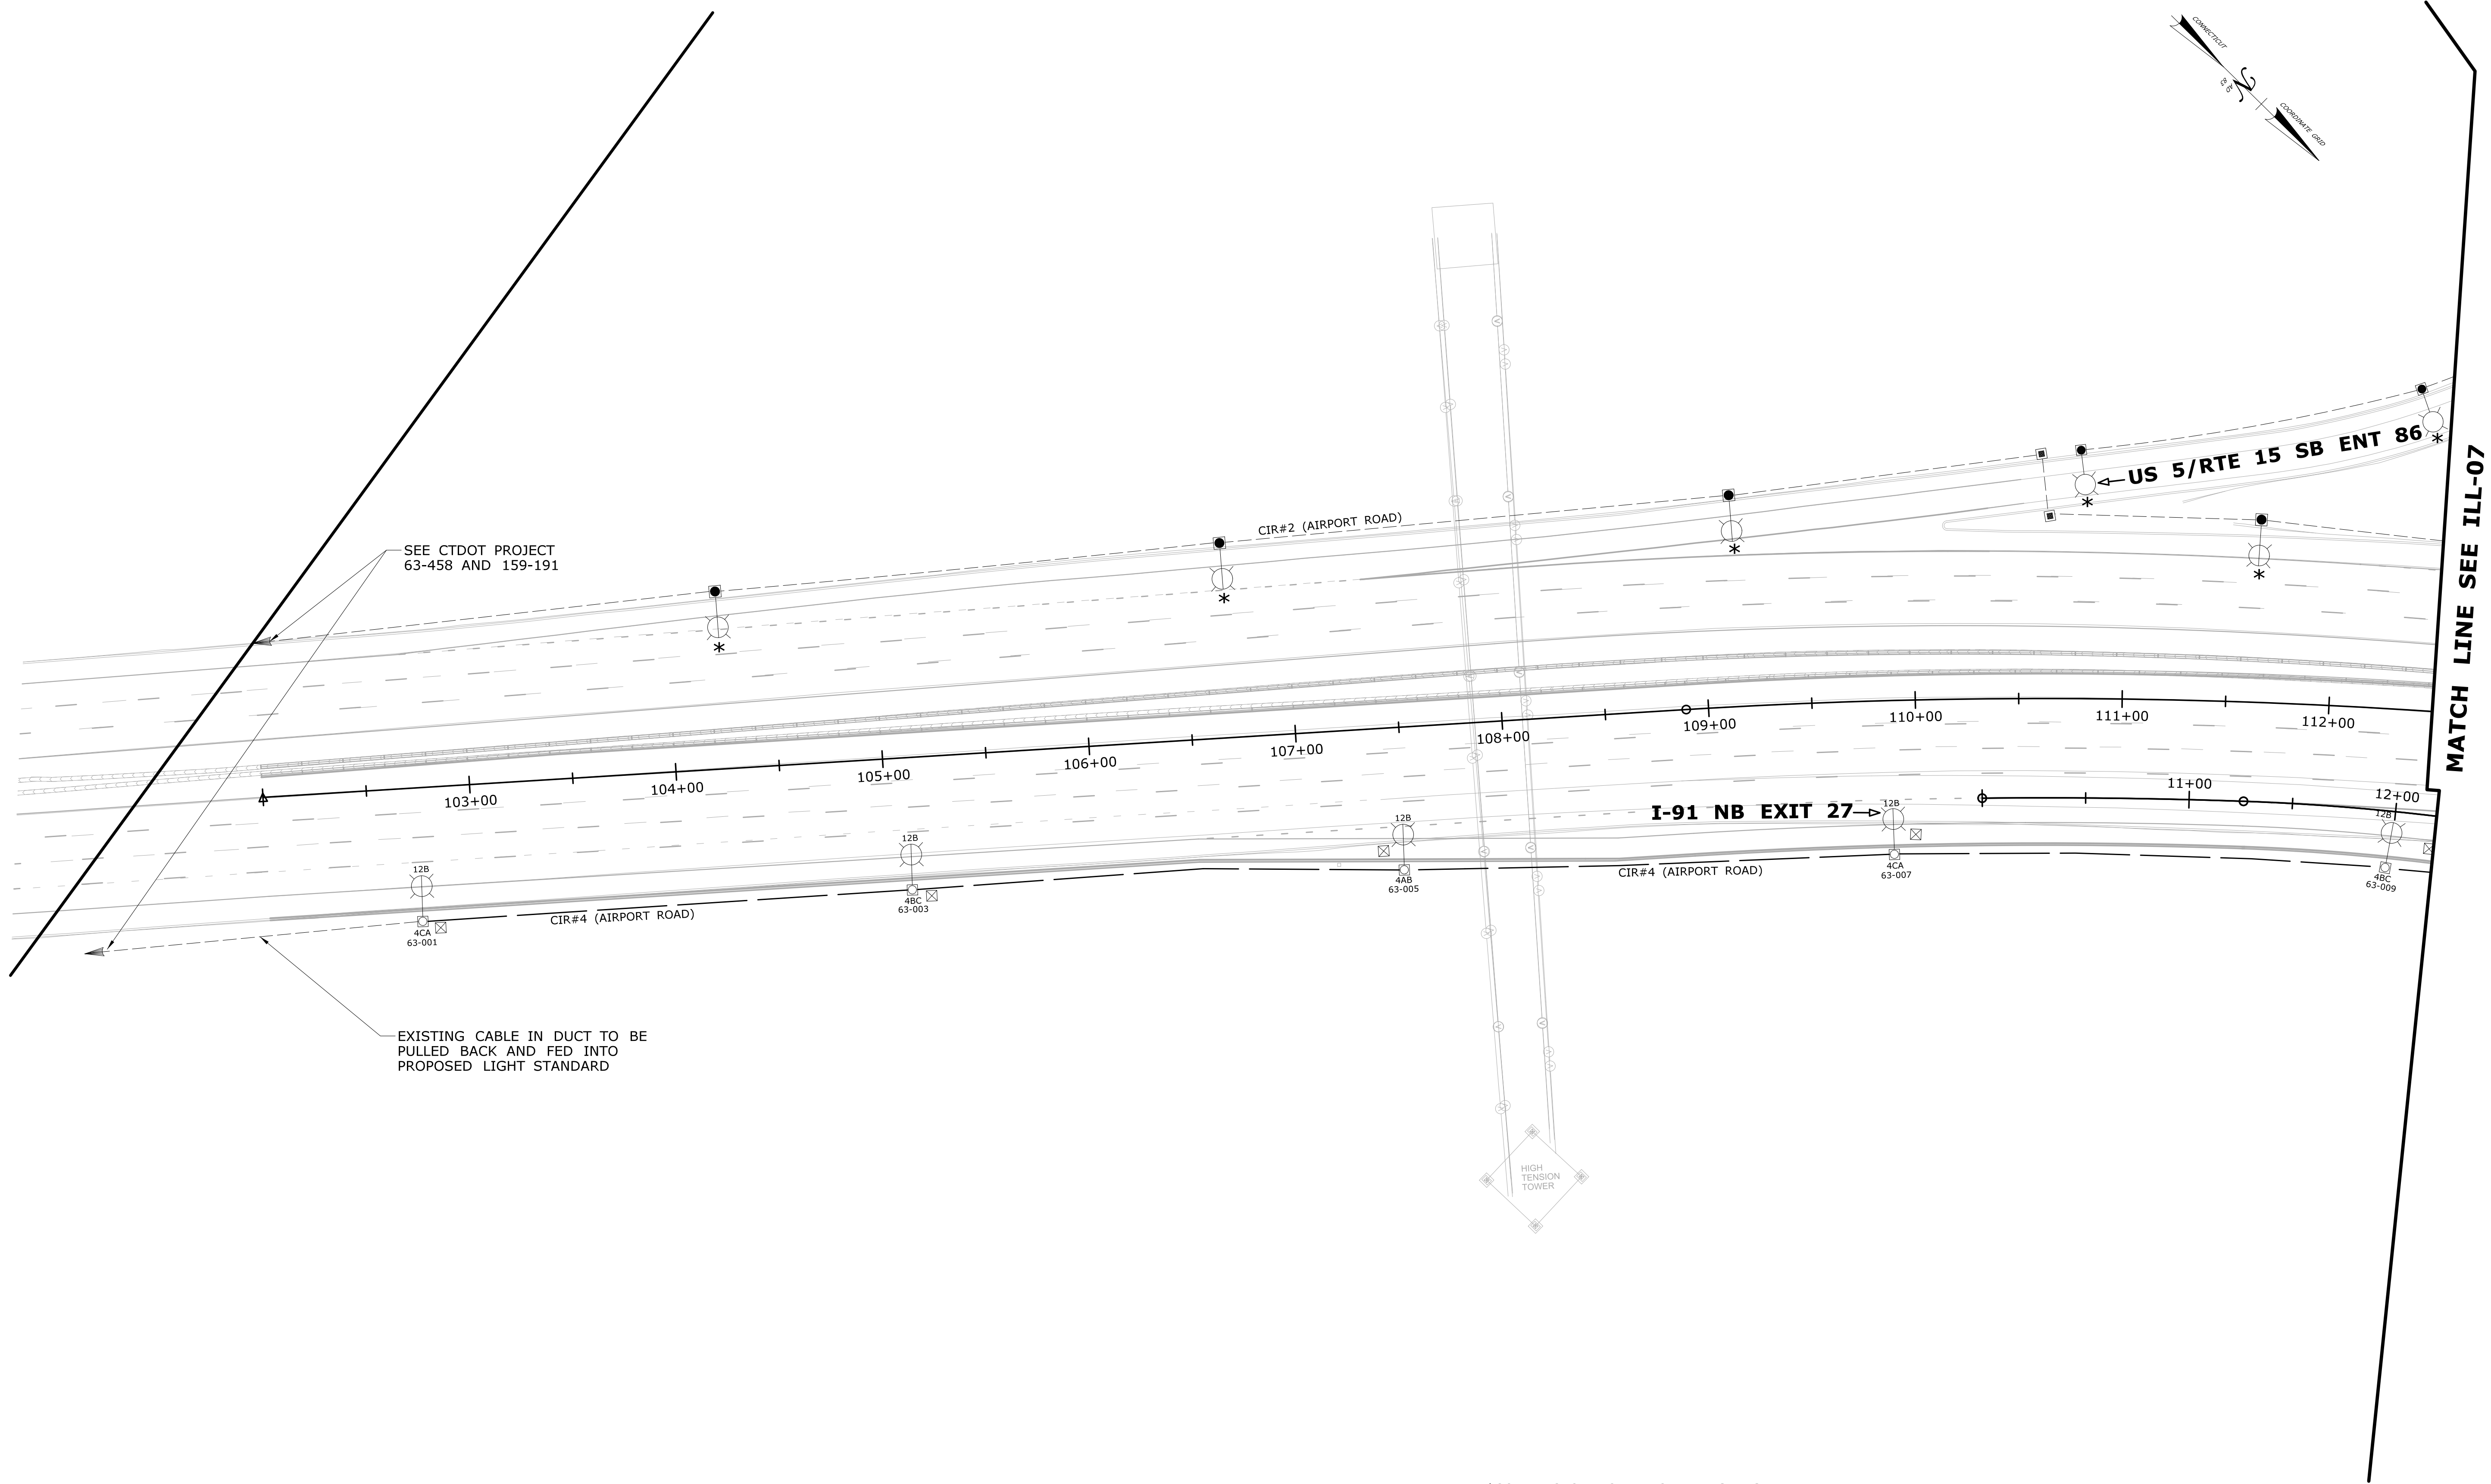
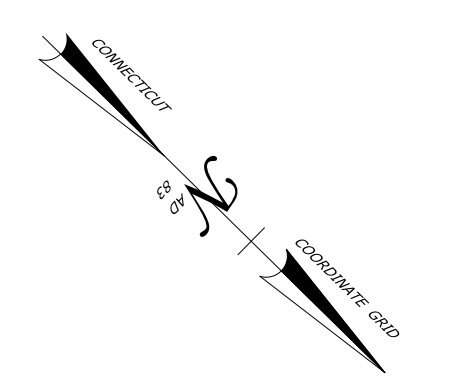
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PROJECT NO.  
**63-703**

DRAWING NO.  
**ILL-05**

SHEET NO.  
01.11.02.05



SEE CTDOT PROJECT  
63-458 AND 159-191

EXISTING CABLE IN DUCT TO BE  
PULLED BACK AND FED INTO  
PROPOSED LIGHT STANDARD

\*CONTRACTOR TO REMOVE EXISTING LUMINAIRE AND  
INSTALL LED LUMINAIRE ONLY. ALL ELSE TO REMAIN

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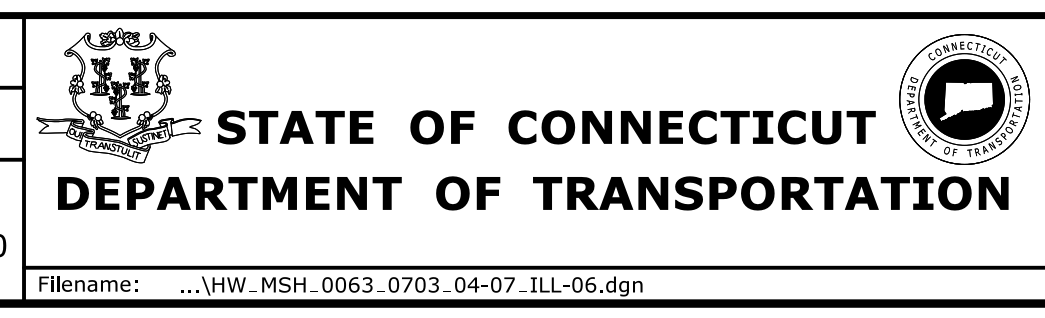
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CITY/TOWN:  
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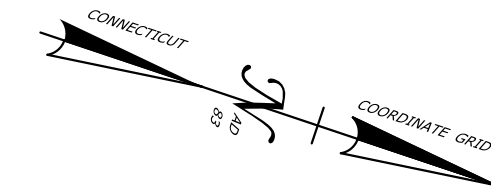
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PLAN**

PROJECT NO.  
**63-703**

DRAWING NO.  
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01.11.02.06


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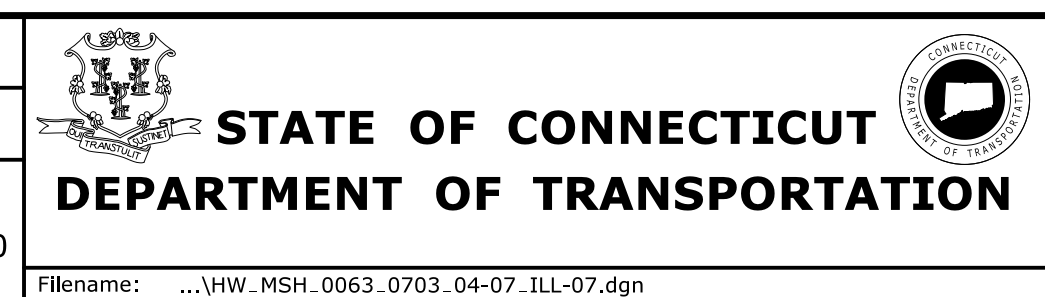


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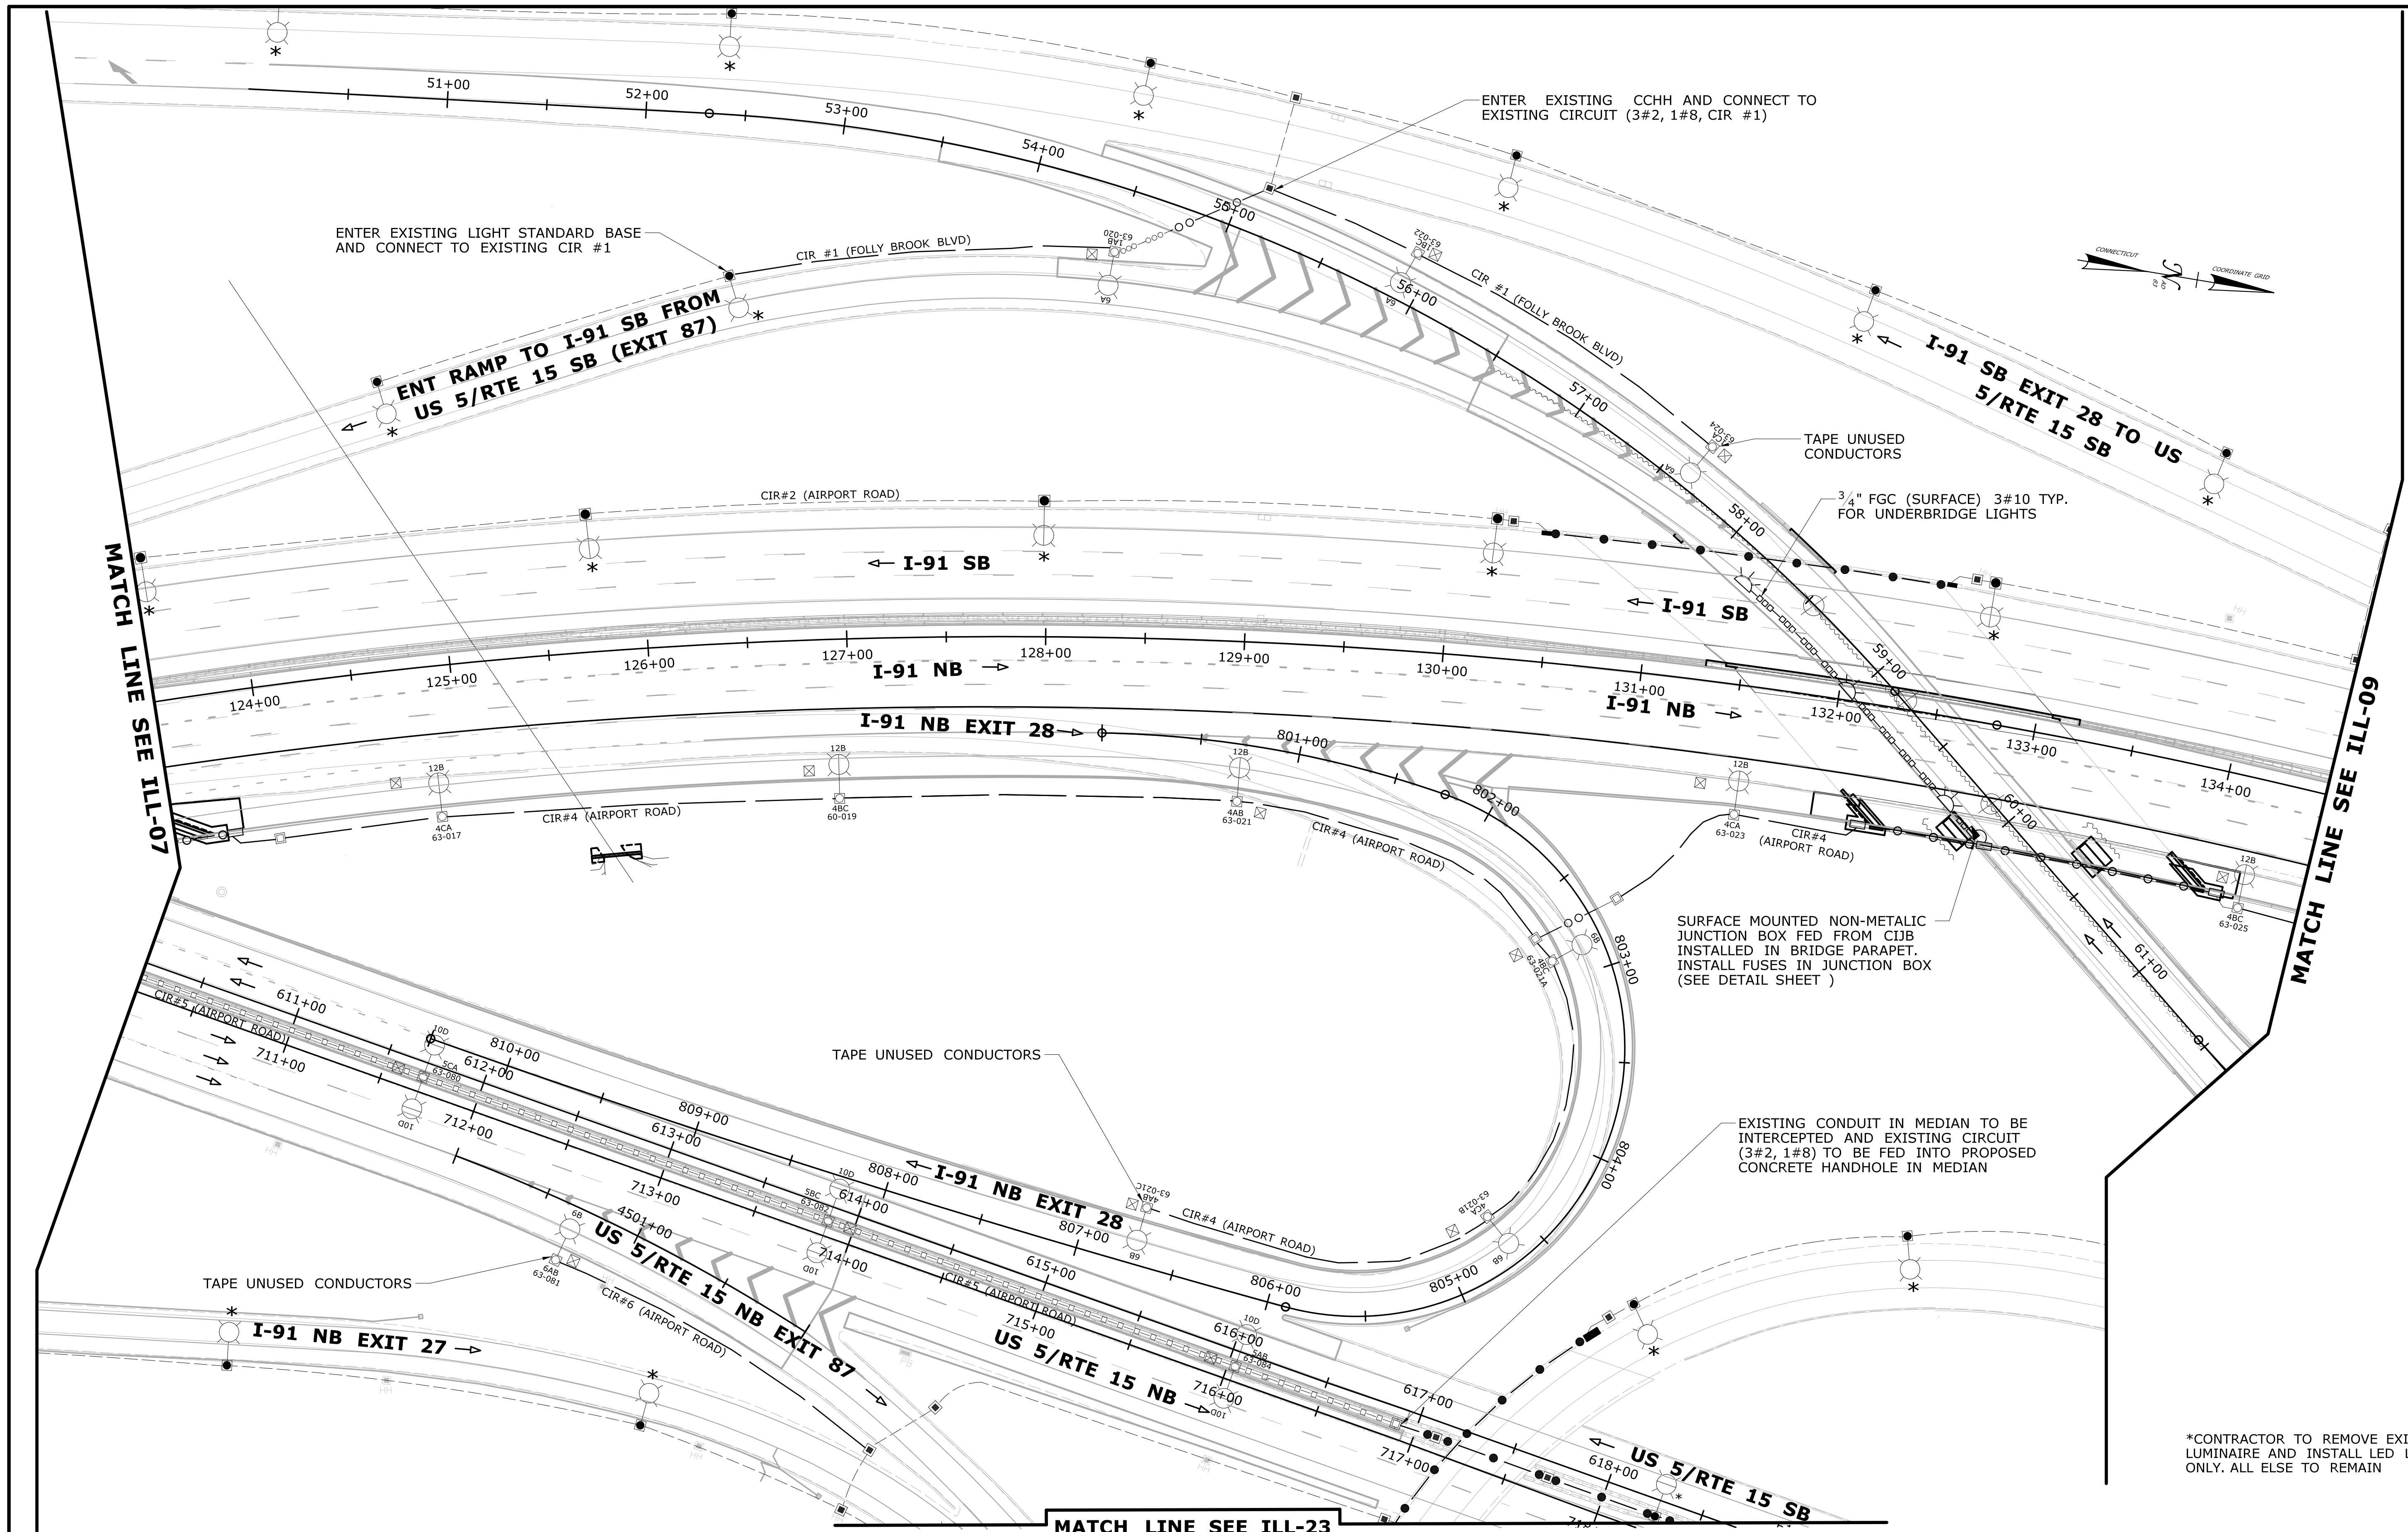


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**RELOCATION OF I-91 NB INTERCHANGE 29 AND WIDENING OF I-91 NB AND ROUTE 15 NB TO I-84 EB**

CITY/TOWN: **HARTFORD EAST HARTFORD**  
 DRAWING TITLE: **ILLUMINATION PLAN**

PROJECT NO. **63-703**  
 DRAWING NO. **ILL-07**  
 SHEET NO. **01.11.02.07**

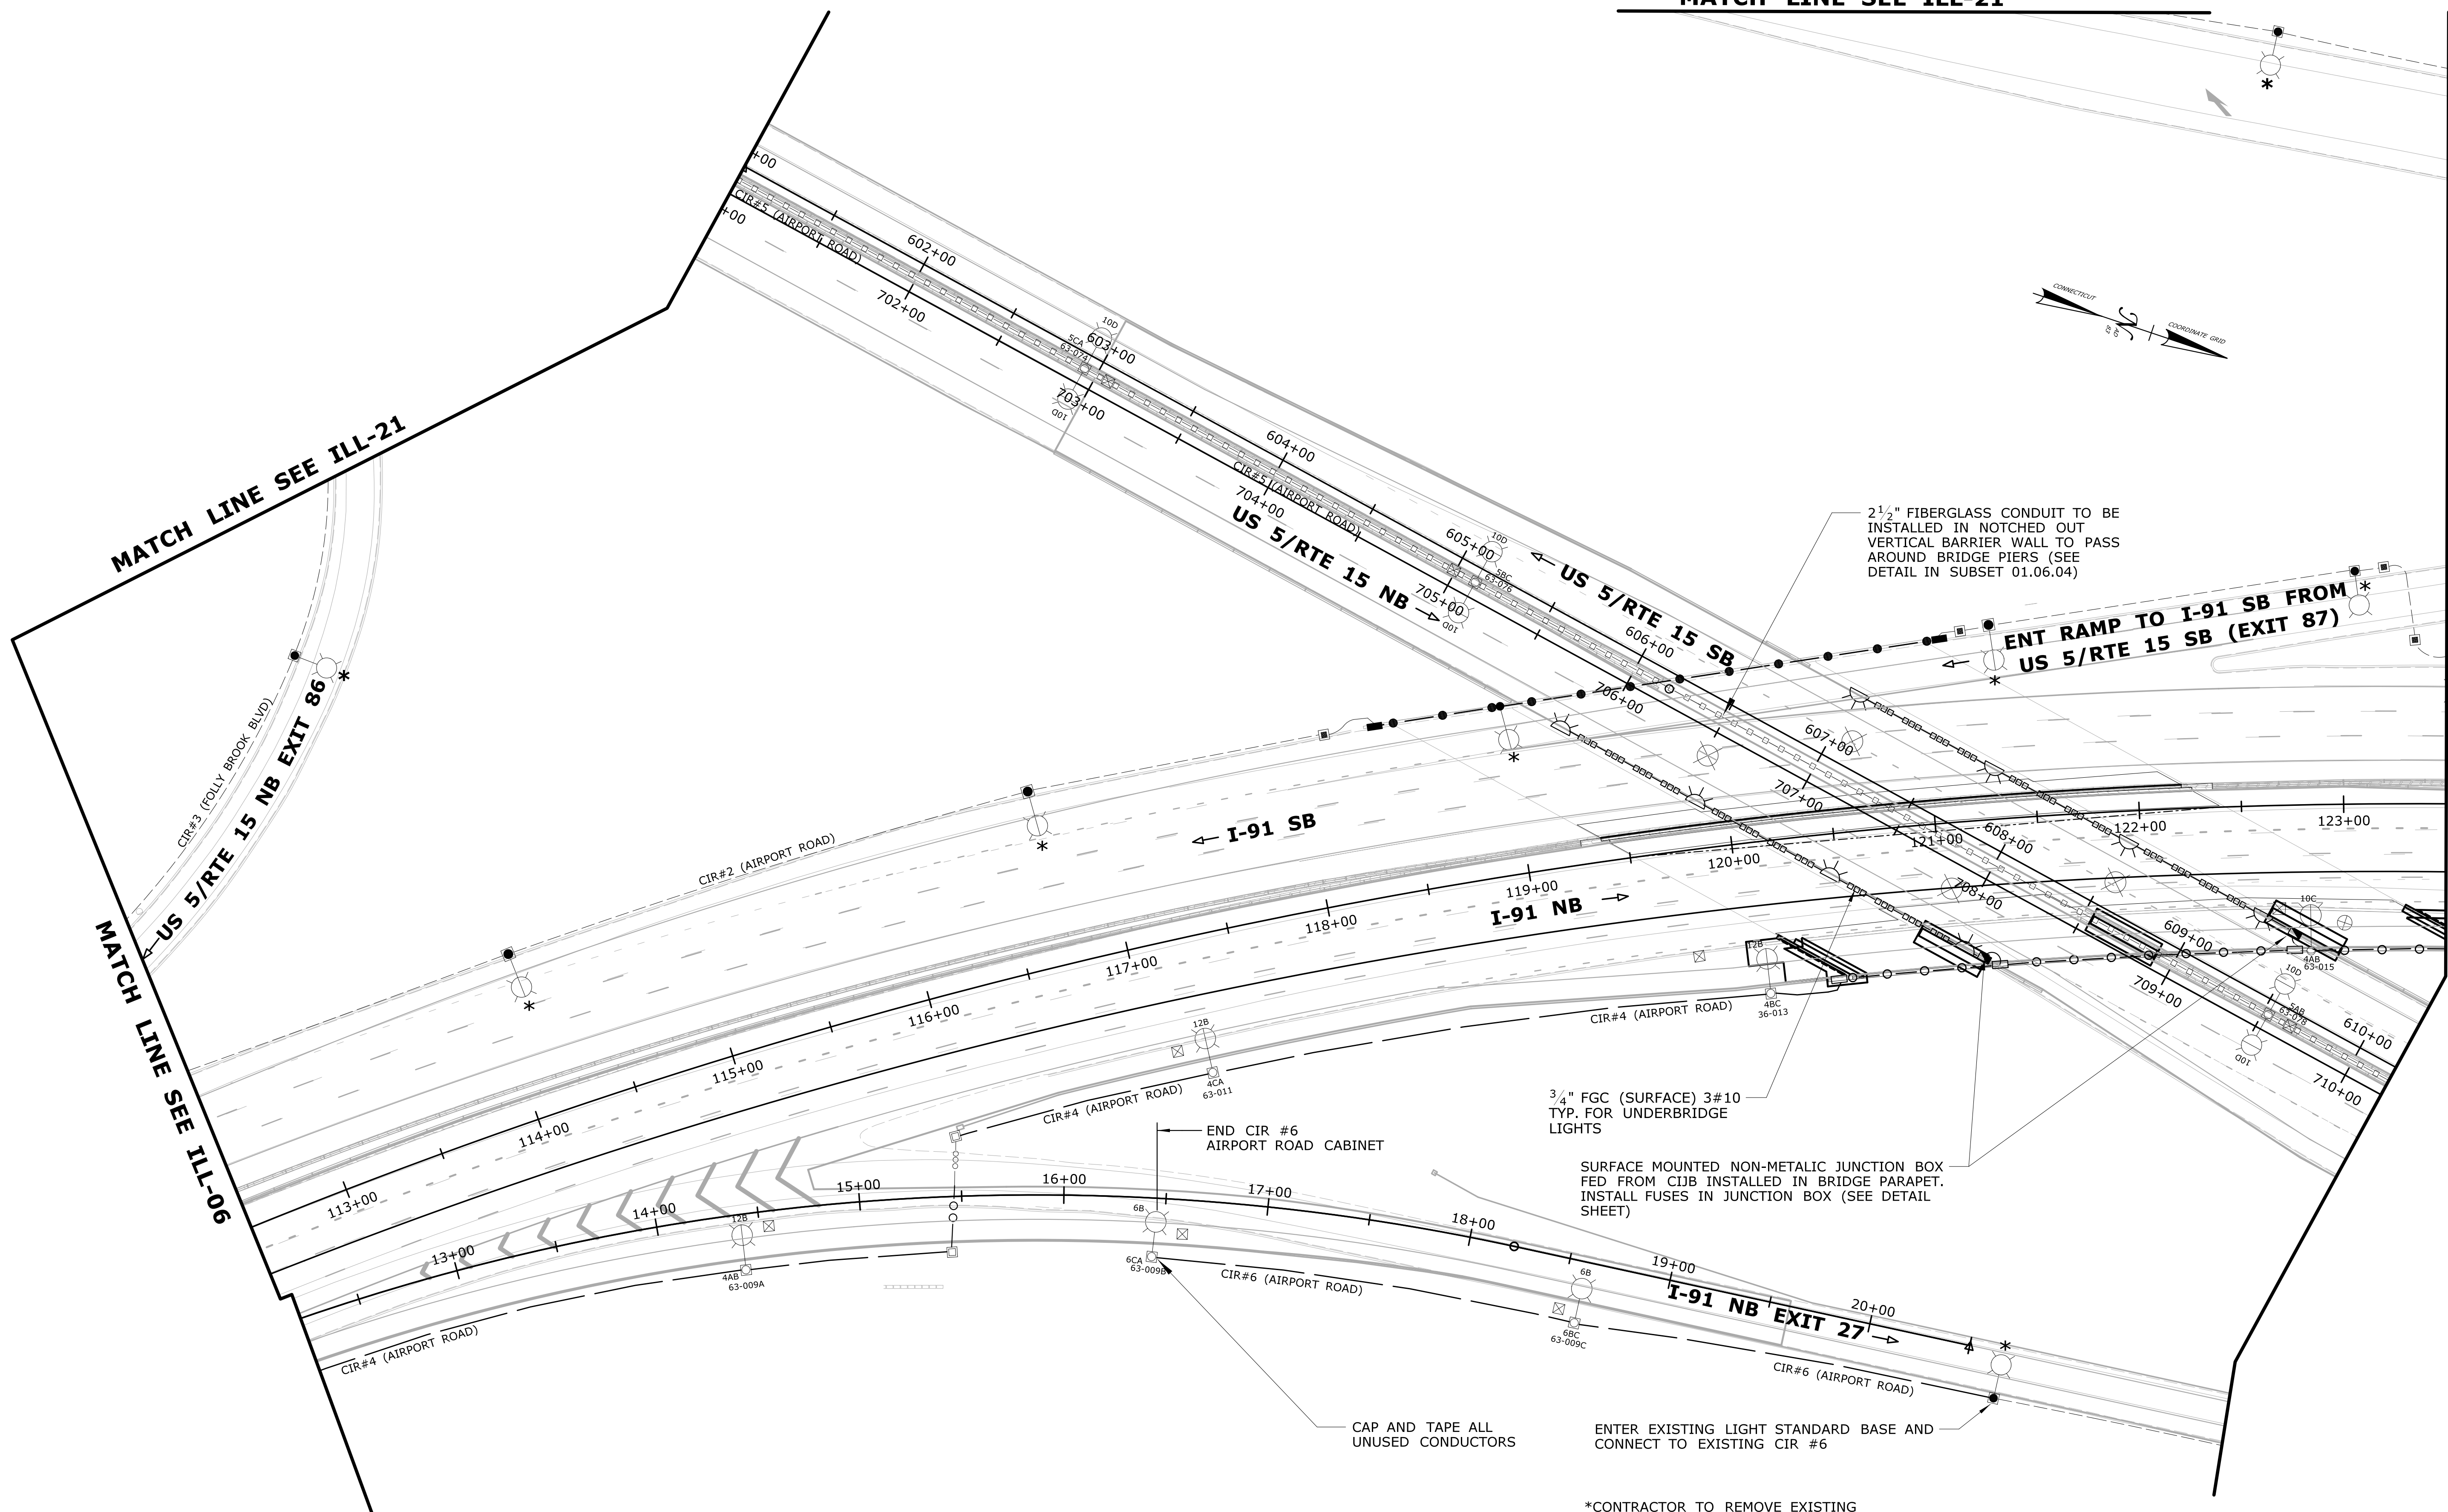



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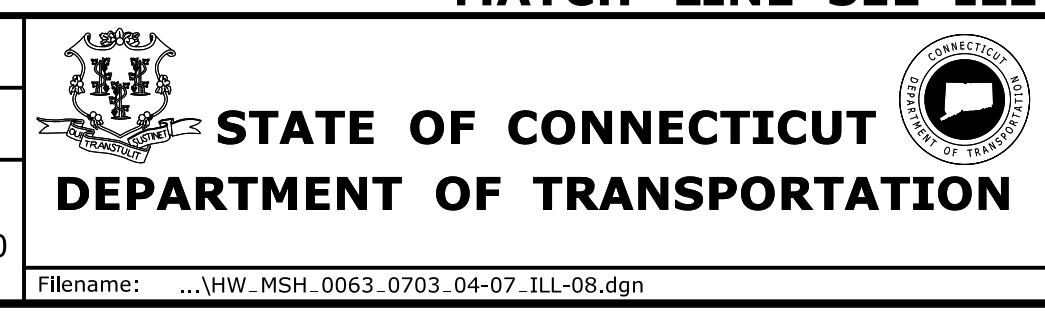
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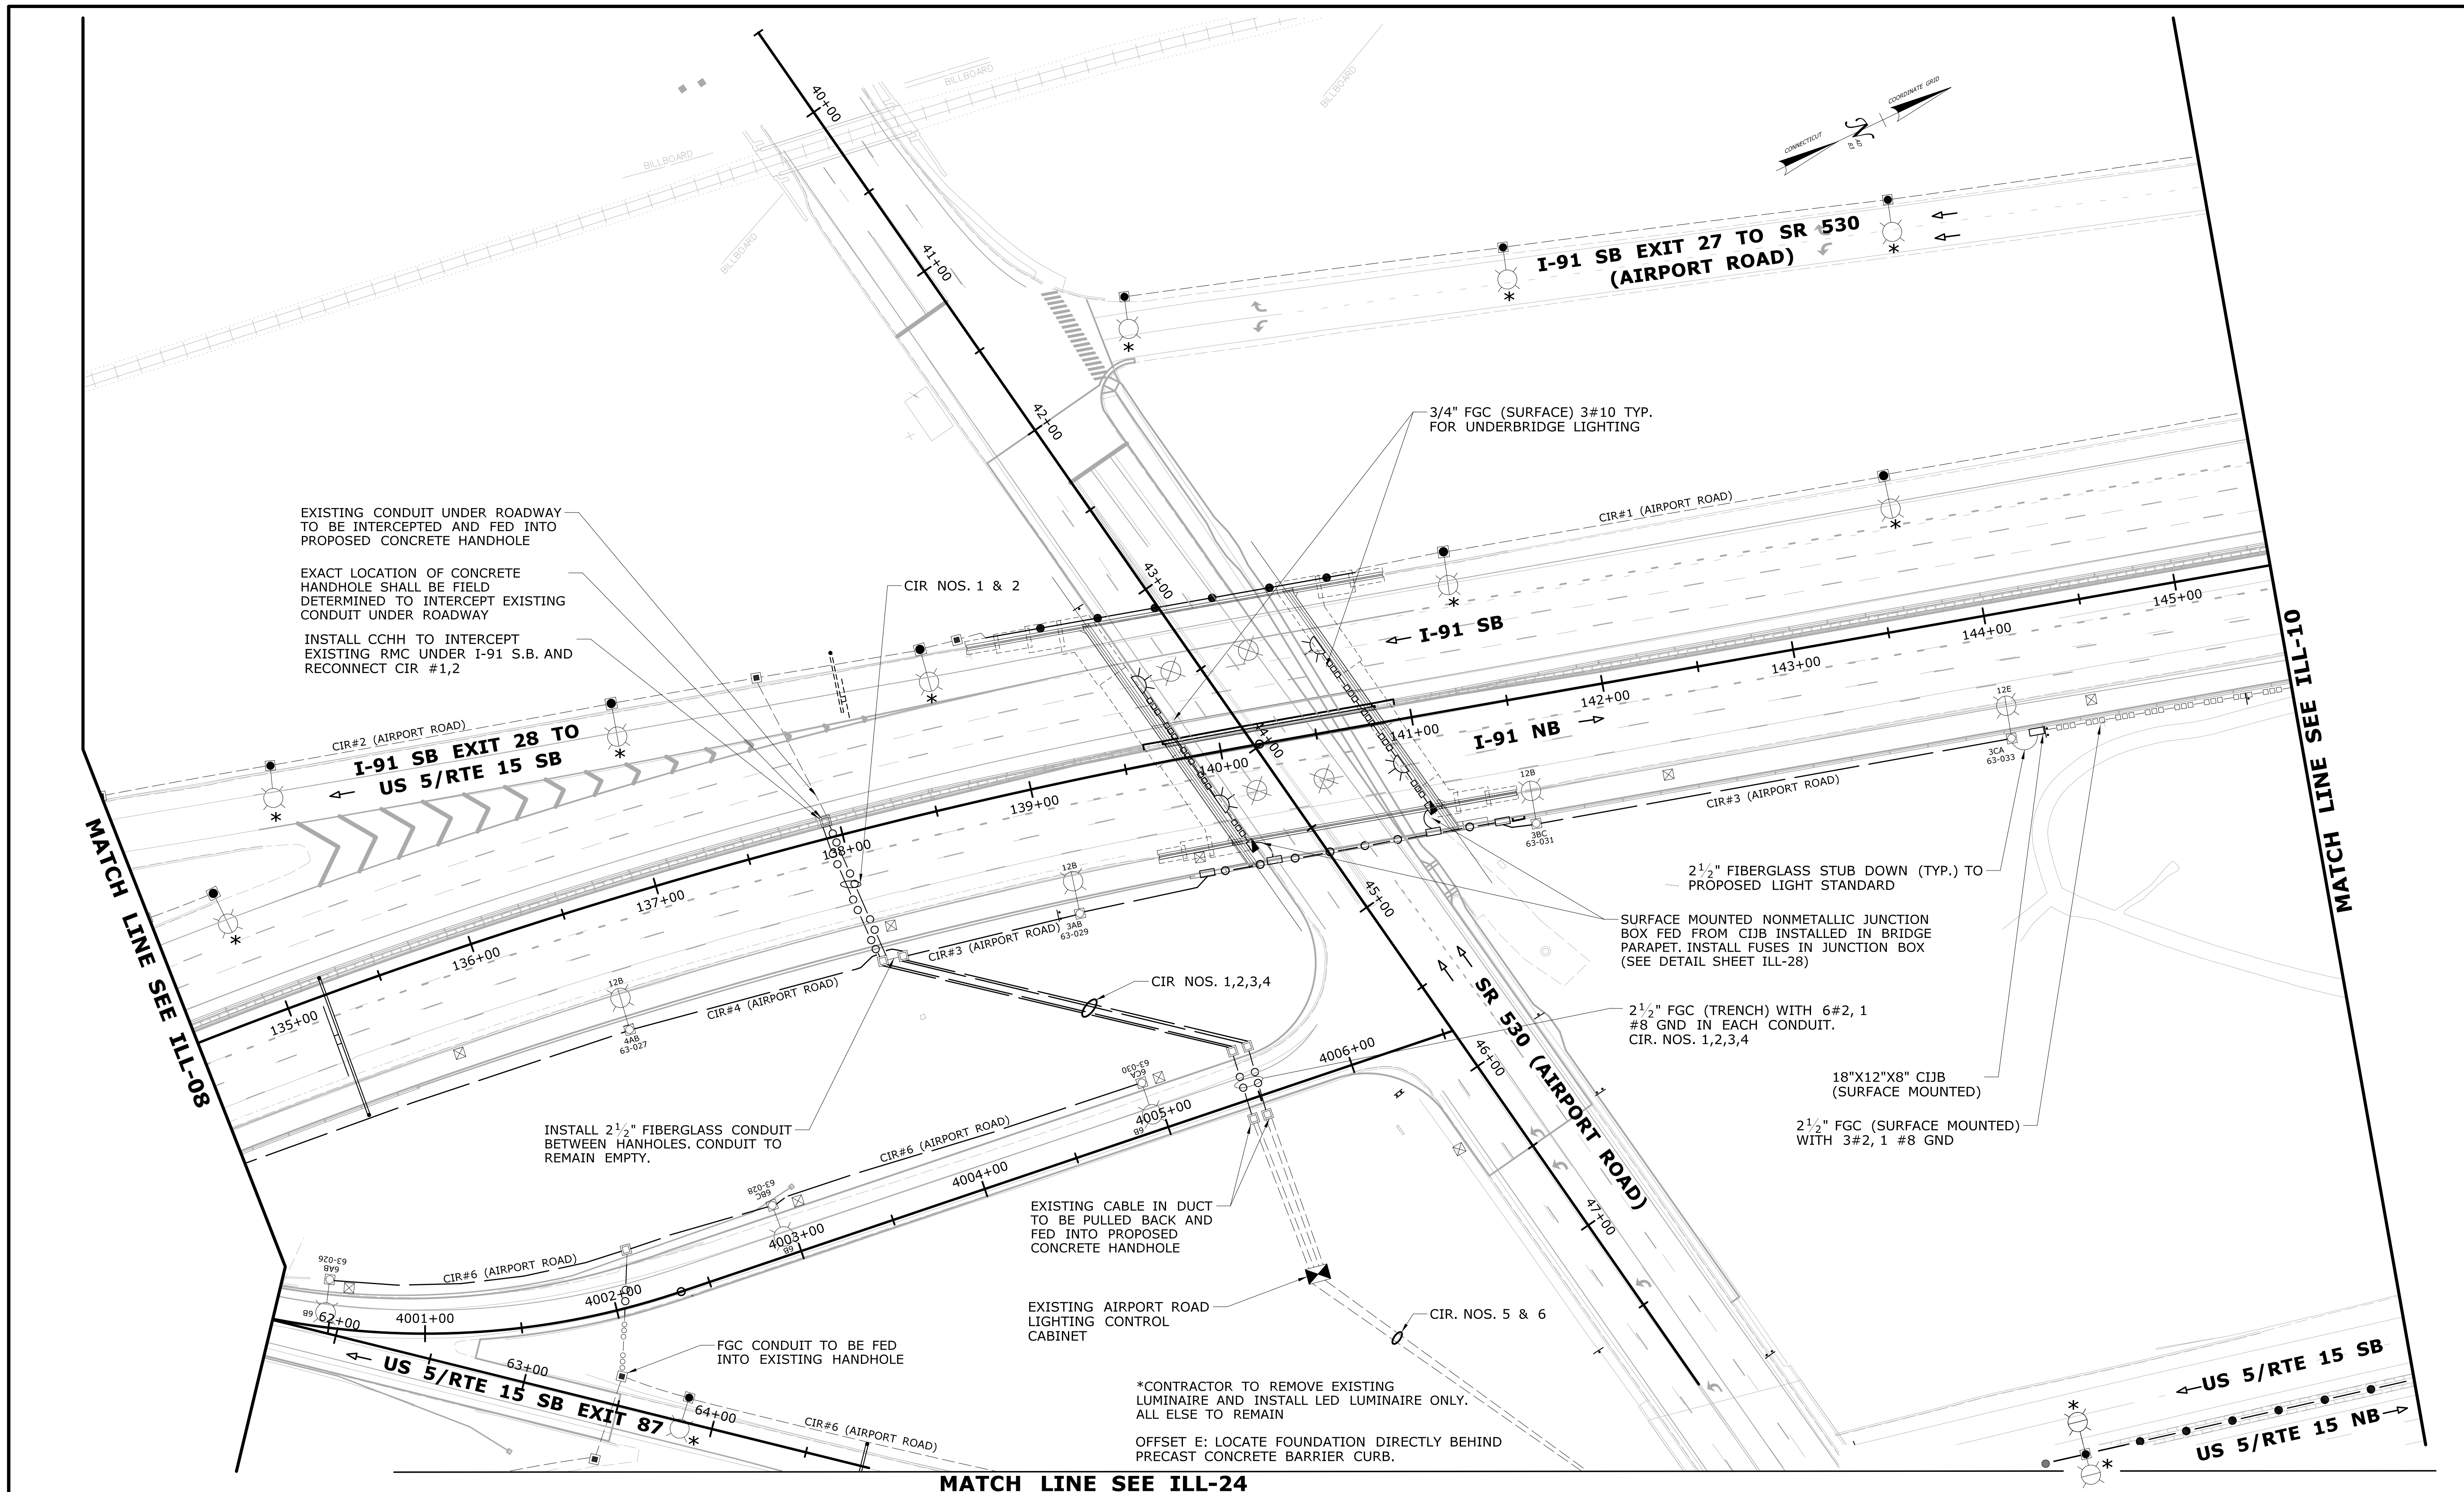
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PLAN**

PROJECT NO.  
**63-703**

DRAWING NO.  
**ILL-08**

SHEET NO.  
01.11.02.08



EXISTING CONDUIT UNDER ROADWAY TO BE INTERCEPTED AND FED INTO PROPOSED CONCRETE HANDHOLE

EXACT LOCATION OF CONCRETE HANDHOLE SHALL BE FIELD DETERMINED TO INTERCEPT EXISTING CONDUIT UNDER ROADWAY

INSTALL CCHH TO INTERCEPT EXISTING RMC UNDER I-91 S.B. AND RECONNECT CIR #1,2

**I-91 SB EXIT 28 TO US 5/RTE 15 SB**

**I-91 SB EXIT 27 TO SR 530 (AIRPORT ROAD)**

2 1/2" FIBERGLASS STUB DOWN (TYP.) TO PROPOSED LIGHT STANDARD

SURFACE MOUNTED NONMETALLIC JUNCTION BOX FED FROM CIJB INSTALLED IN BRIDGE PARAPET. INSTALL FUSES IN JUNCTION BOX (SEE DETAIL SHEET ILL-28)

2 1/2" FGC (TRENCH) WITH 6#2, 1 #8 GND IN EACH CONDUIT. CIR. NOS. 1,2,3,4

18"X12"X8" CIJB (SURFACE MOUNTED)

2 1/2" FGC (SURFACE MOUNTED) WITH 3#2, 1 #8 GND

INSTALL 2 1/2" FIBERGLASS CONDUIT BETWEEN HANHOLES. CONDUIT TO REMAIN EMPTY.

EXISTING CABLE IN DUCT TO BE PULLED BACK AND FED INTO PROPOSED CONCRETE HANDHOLE

EXISTING AIRPORT ROAD LIGHTING CONTROL CABINET

\*CONTRACTOR TO REMOVE EXISTING LUMINAIRE AND INSTALL LED LUMINAIRE ONLY. ALL ELSE TO REMAIN

OFFSET E: LOCATE FOUNDATION DIRECTLY BEHIND PRECAST CONCRETE BARRIER CURB.

MATCH LINE SEE ILL-08


MATCH LINE SEE ILL-10

MATCH LINE SEE ILL-24

THE INFORMATION, INCLUDING ESTIMATED QUANTITIES OF WORK, SHOWN ON THESE SHEETS IS BASED ON LIMITED INVESTIGATIONS BY THE STATE AND IS IN NO WAY WARRANTED TO INDICATE THE CONDITIONS OF ACTUAL QUANTITIES OF WORK WHICH WILL BE REQUIRED.		DESIGNER/DRAFTER: <b>DDR</b> CHECKED BY: <b>MSB</b> SCALE IN FEET 0 40 80 SCALE 1"=40'	<b>STATE OF CONNECTICUT</b> <b>DEPARTMENT OF TRANSPORTATION</b> File name: ...VHW_MSH_0063_0703_04-07_ILL-09.dgn	SIGNATURE/BLOCK:  <b>OFFICE OF ENGINEERING</b> APPROVED BY:	PROJECT TITLE: <b>RELOCATION OF I-91 NB INTERCHANGE 29 AND WIDENING OF I-91 NB AND ROUTE 15 NB TO I-84 EB</b>	DRAWN BY: <b>HARTFORD EAST HARTFORD</b> DRAWING TITLE: <b>ILLUMINATION PLAN</b>	PROJECT NO.: <b>63-703</b> DRAWING NO.: <b>ILL-09</b> SHEET NO.: <b>01.11.02.09</b>
REV.	DATE	REVISION DESCRIPTION	SHEET NO.	Plotted Date: 5/14/2018			

MATCH LINE SEE ILL-09

MATCH LINE SEE ILL-11

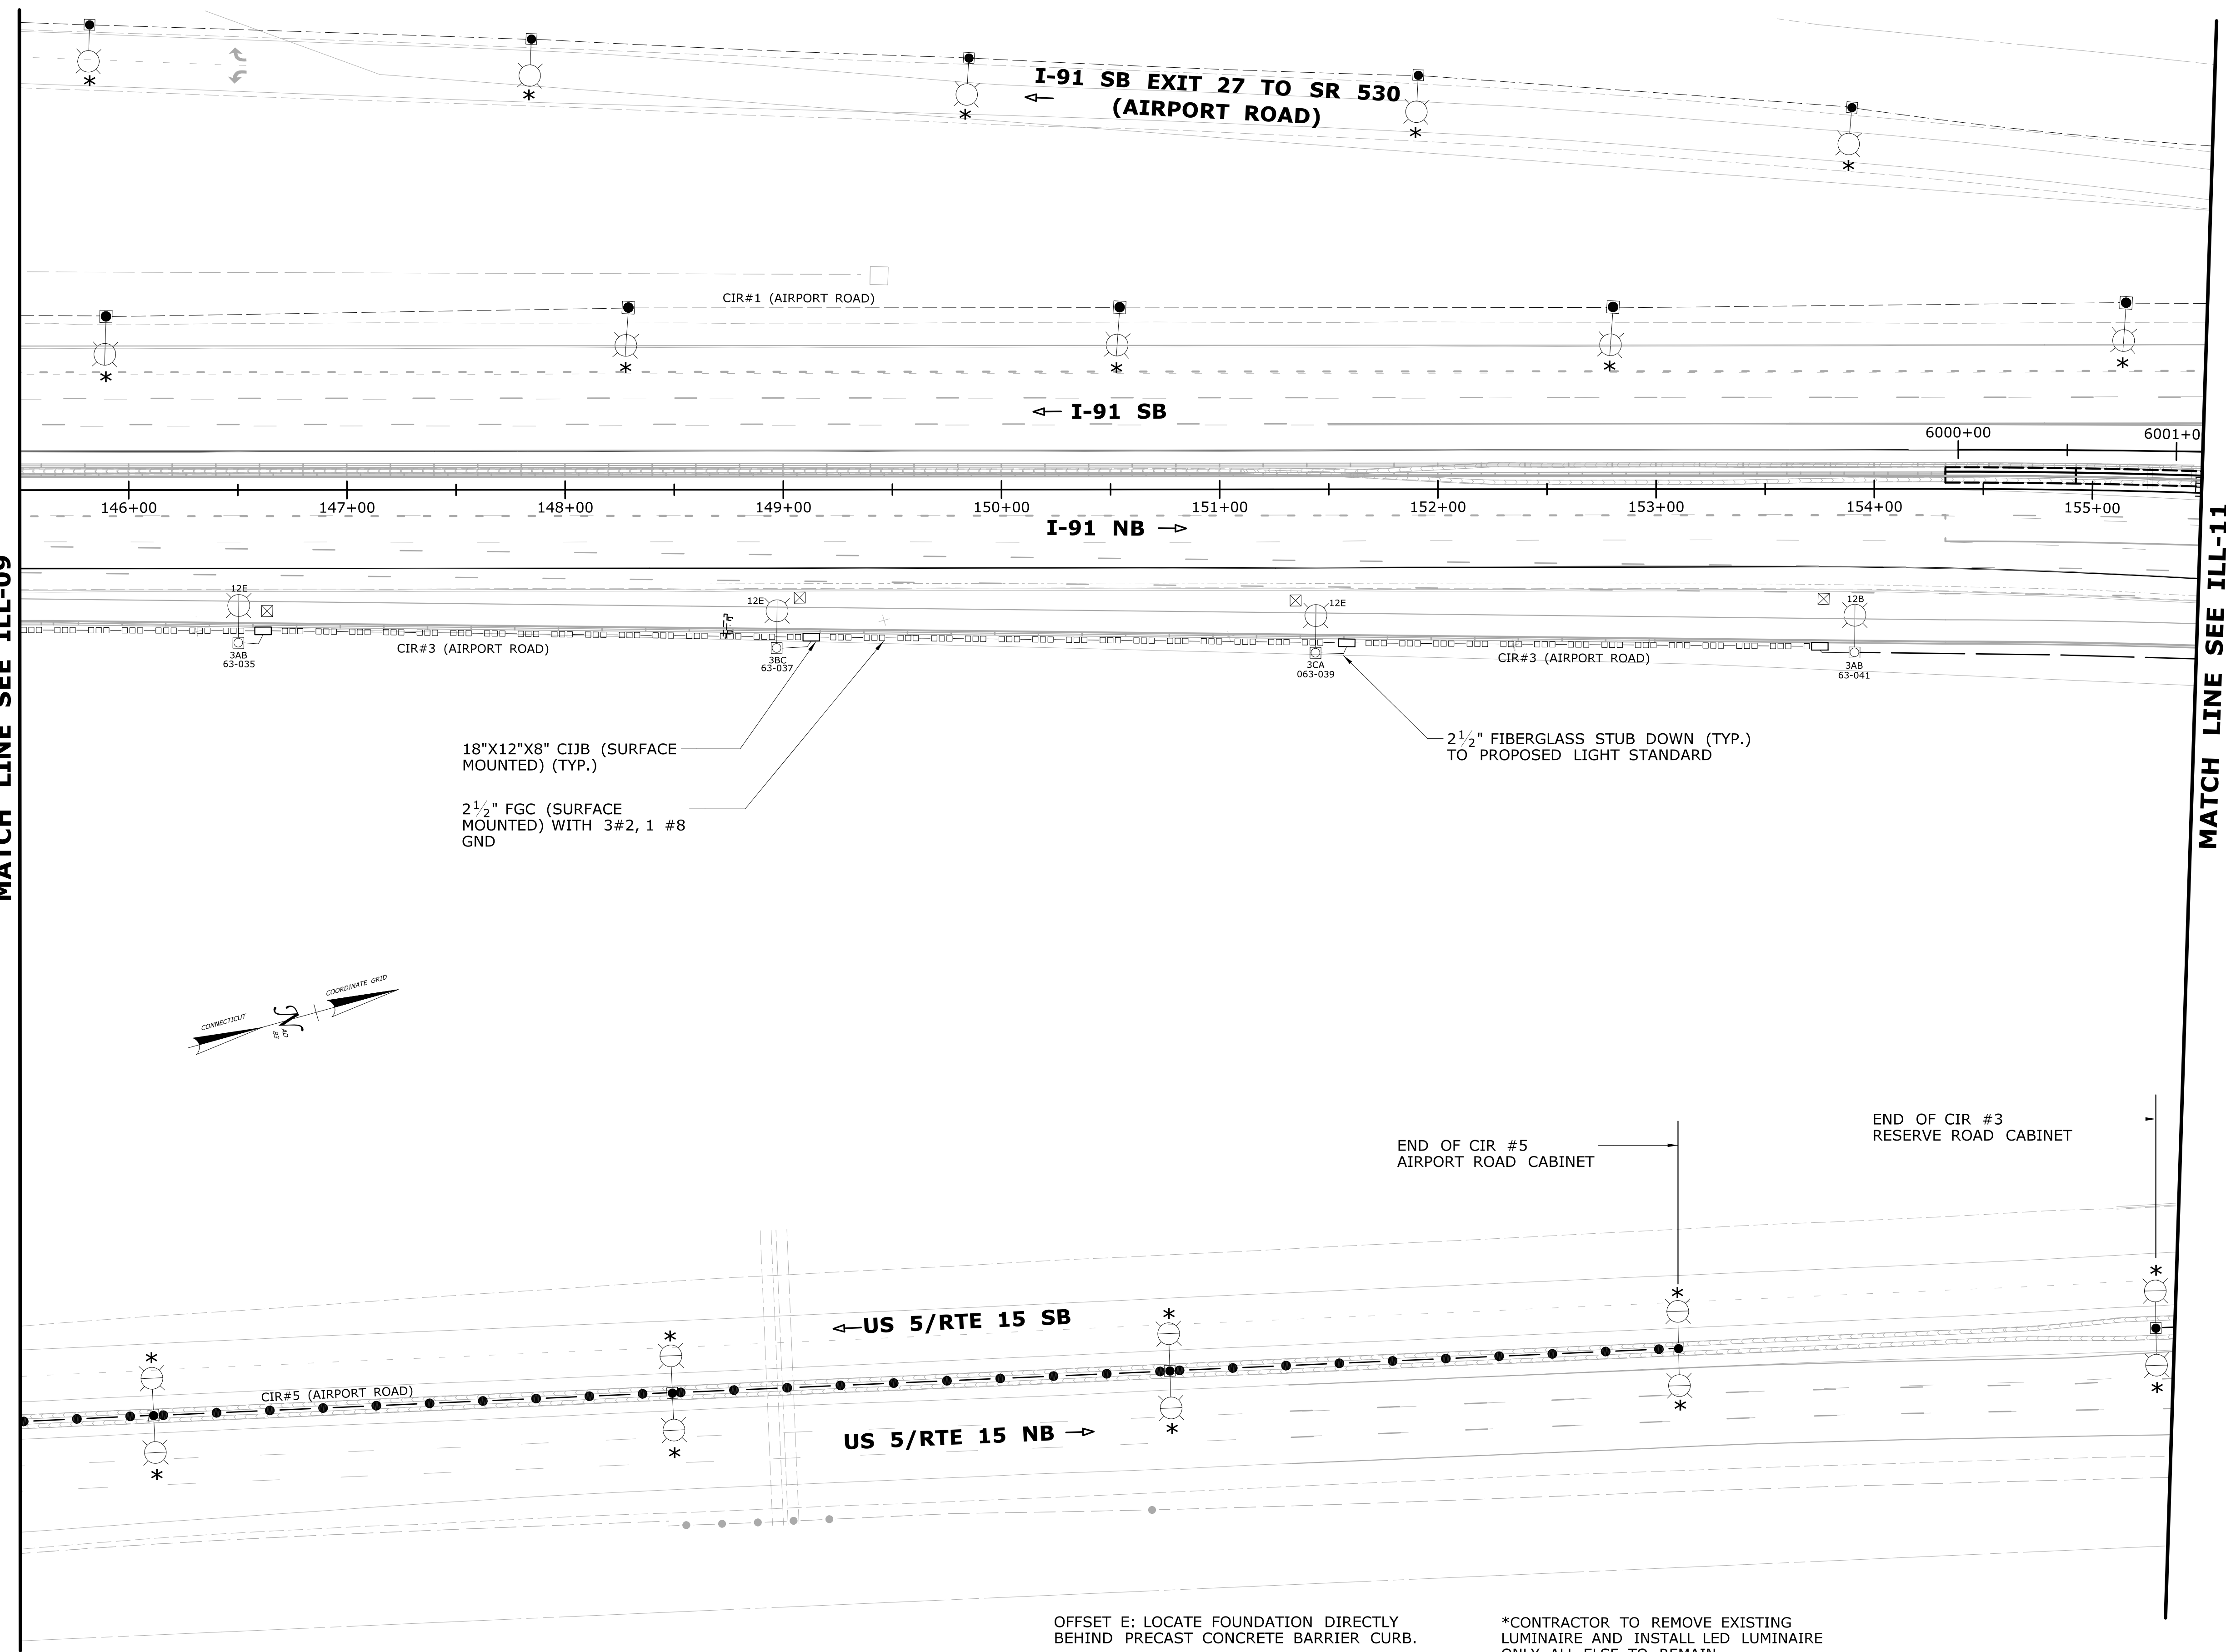

OFFSET E: LOCATE FOUNDATION DIRECTLY BEHIND PRECAST CONCRETE BARRIER CURB.


\*CONTRACTOR TO REMOVE EXISTING LUMINAIRE AND INSTALL LED LUMINAIRE ONLY. ALL ELSE TO REMAIN

REV.	DATE	REVISION DESCRIPTION	SHEET NO.

THE INFORMATION, INCLUDING ESTIMATED QUANTITIES OF WORK SHOWN ON THESE SHEETS IS BASED ON LIMITED INVESTIGATIONS BY THE STATE AND IS IN NO WAY WARRANTED TO INDICATE THE CONDITIONS OF ACTUAL QUANTITIES OF WORK WHICH WILL BE REQUIRED.

Plotted Date: 3/9/2018

DESIGNER/DRAFTER: DDR  
 CHECKED BY: MSB  
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 0 40 80  
 SCALE 1"=40'

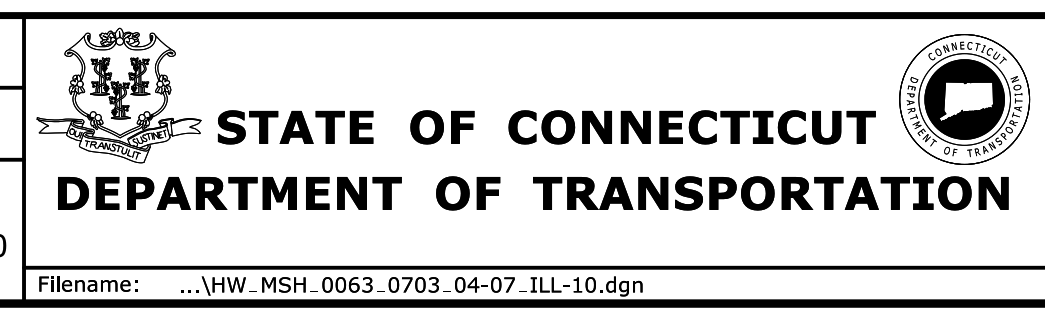

SIGNATURE/BLOCK:  
 OFFICE OF ENGINEERING  
 APPROVED BY: *Chapman*


PROJECT TITLE:  
**RELOCATION OF I-91 NB INTERCHANGE 29 AND WIDENING OF I-91 NB AND ROUTE 15 NB TO I-84 EB**

EDR/REOWN: **HARTFORD EAST HARTFORD**  
 DRAWING TITLE: **ILLUMINATION PLAN**

PROJECT NO. **63-703**  
 DRAWING NO. **ILL-10**  
 SHEET NO. 01.11.02.10

Filename: ...VHW\_MSH\_0063\_0703\_04-07\_ILL-10.dgn

MATCH LINE SEE ILL-10

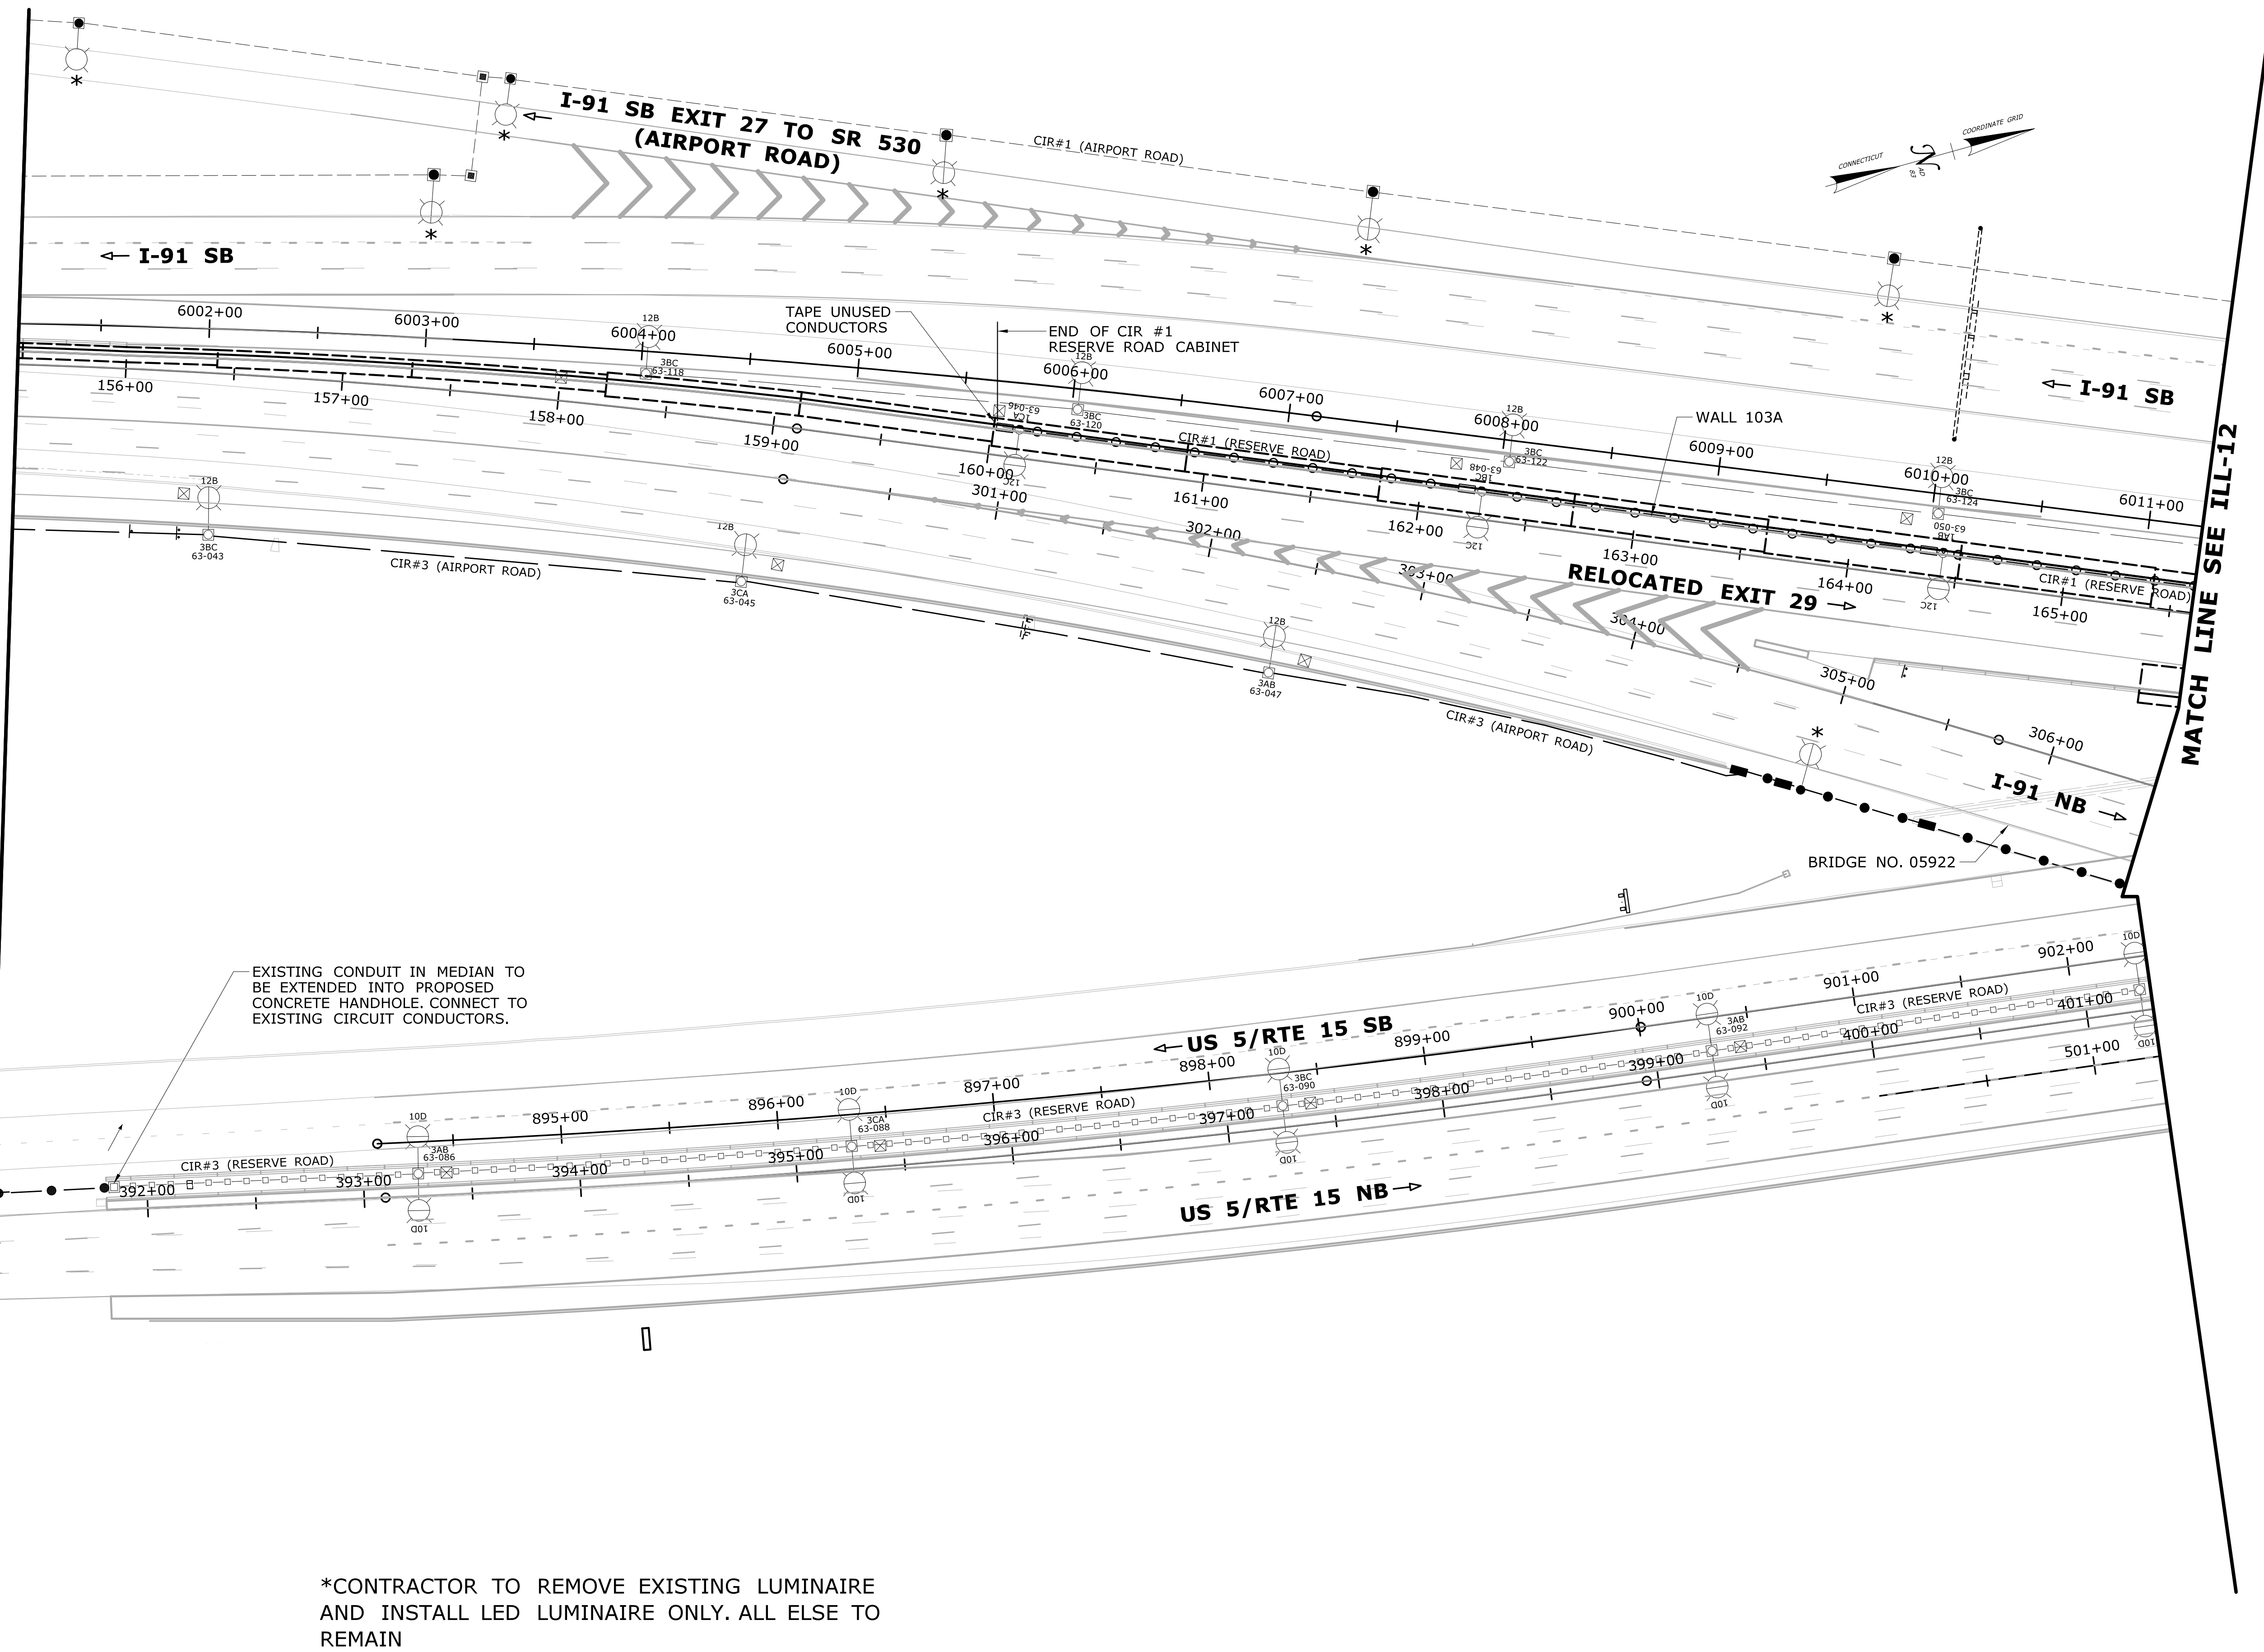

MATCH LINE SEE ILL-12


\*CONTRACTOR TO REMOVE EXISTING LUMINAIRE AND INSTALL LED LUMINAIRE ONLY. ALL ELSE TO REMAIN

REV.	DATE	REVISION DESCRIPTION	SHEET NO.

THE INFORMATION, INCLUDING ESTIMATED QUANTITIES OF WORK, SHOWN ON THESE SHEETS IS BASED ON LIMITED INVESTIGATIONS BY THE STATE AND IS IN NO WAY WARRANTED TO INDICATE THE CONDITIONS OF ACTUAL QUANTITIES OF WORK WHICH WILL BE REQUIRED.

Plotted Date: 5/1/2018

DESIGNER/DRAFTER: DDR  
 CHECKED BY: MSB  
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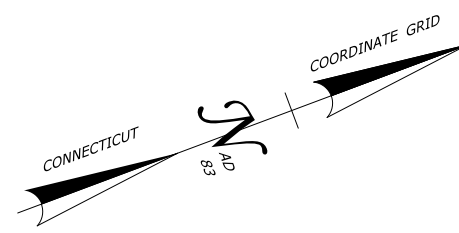
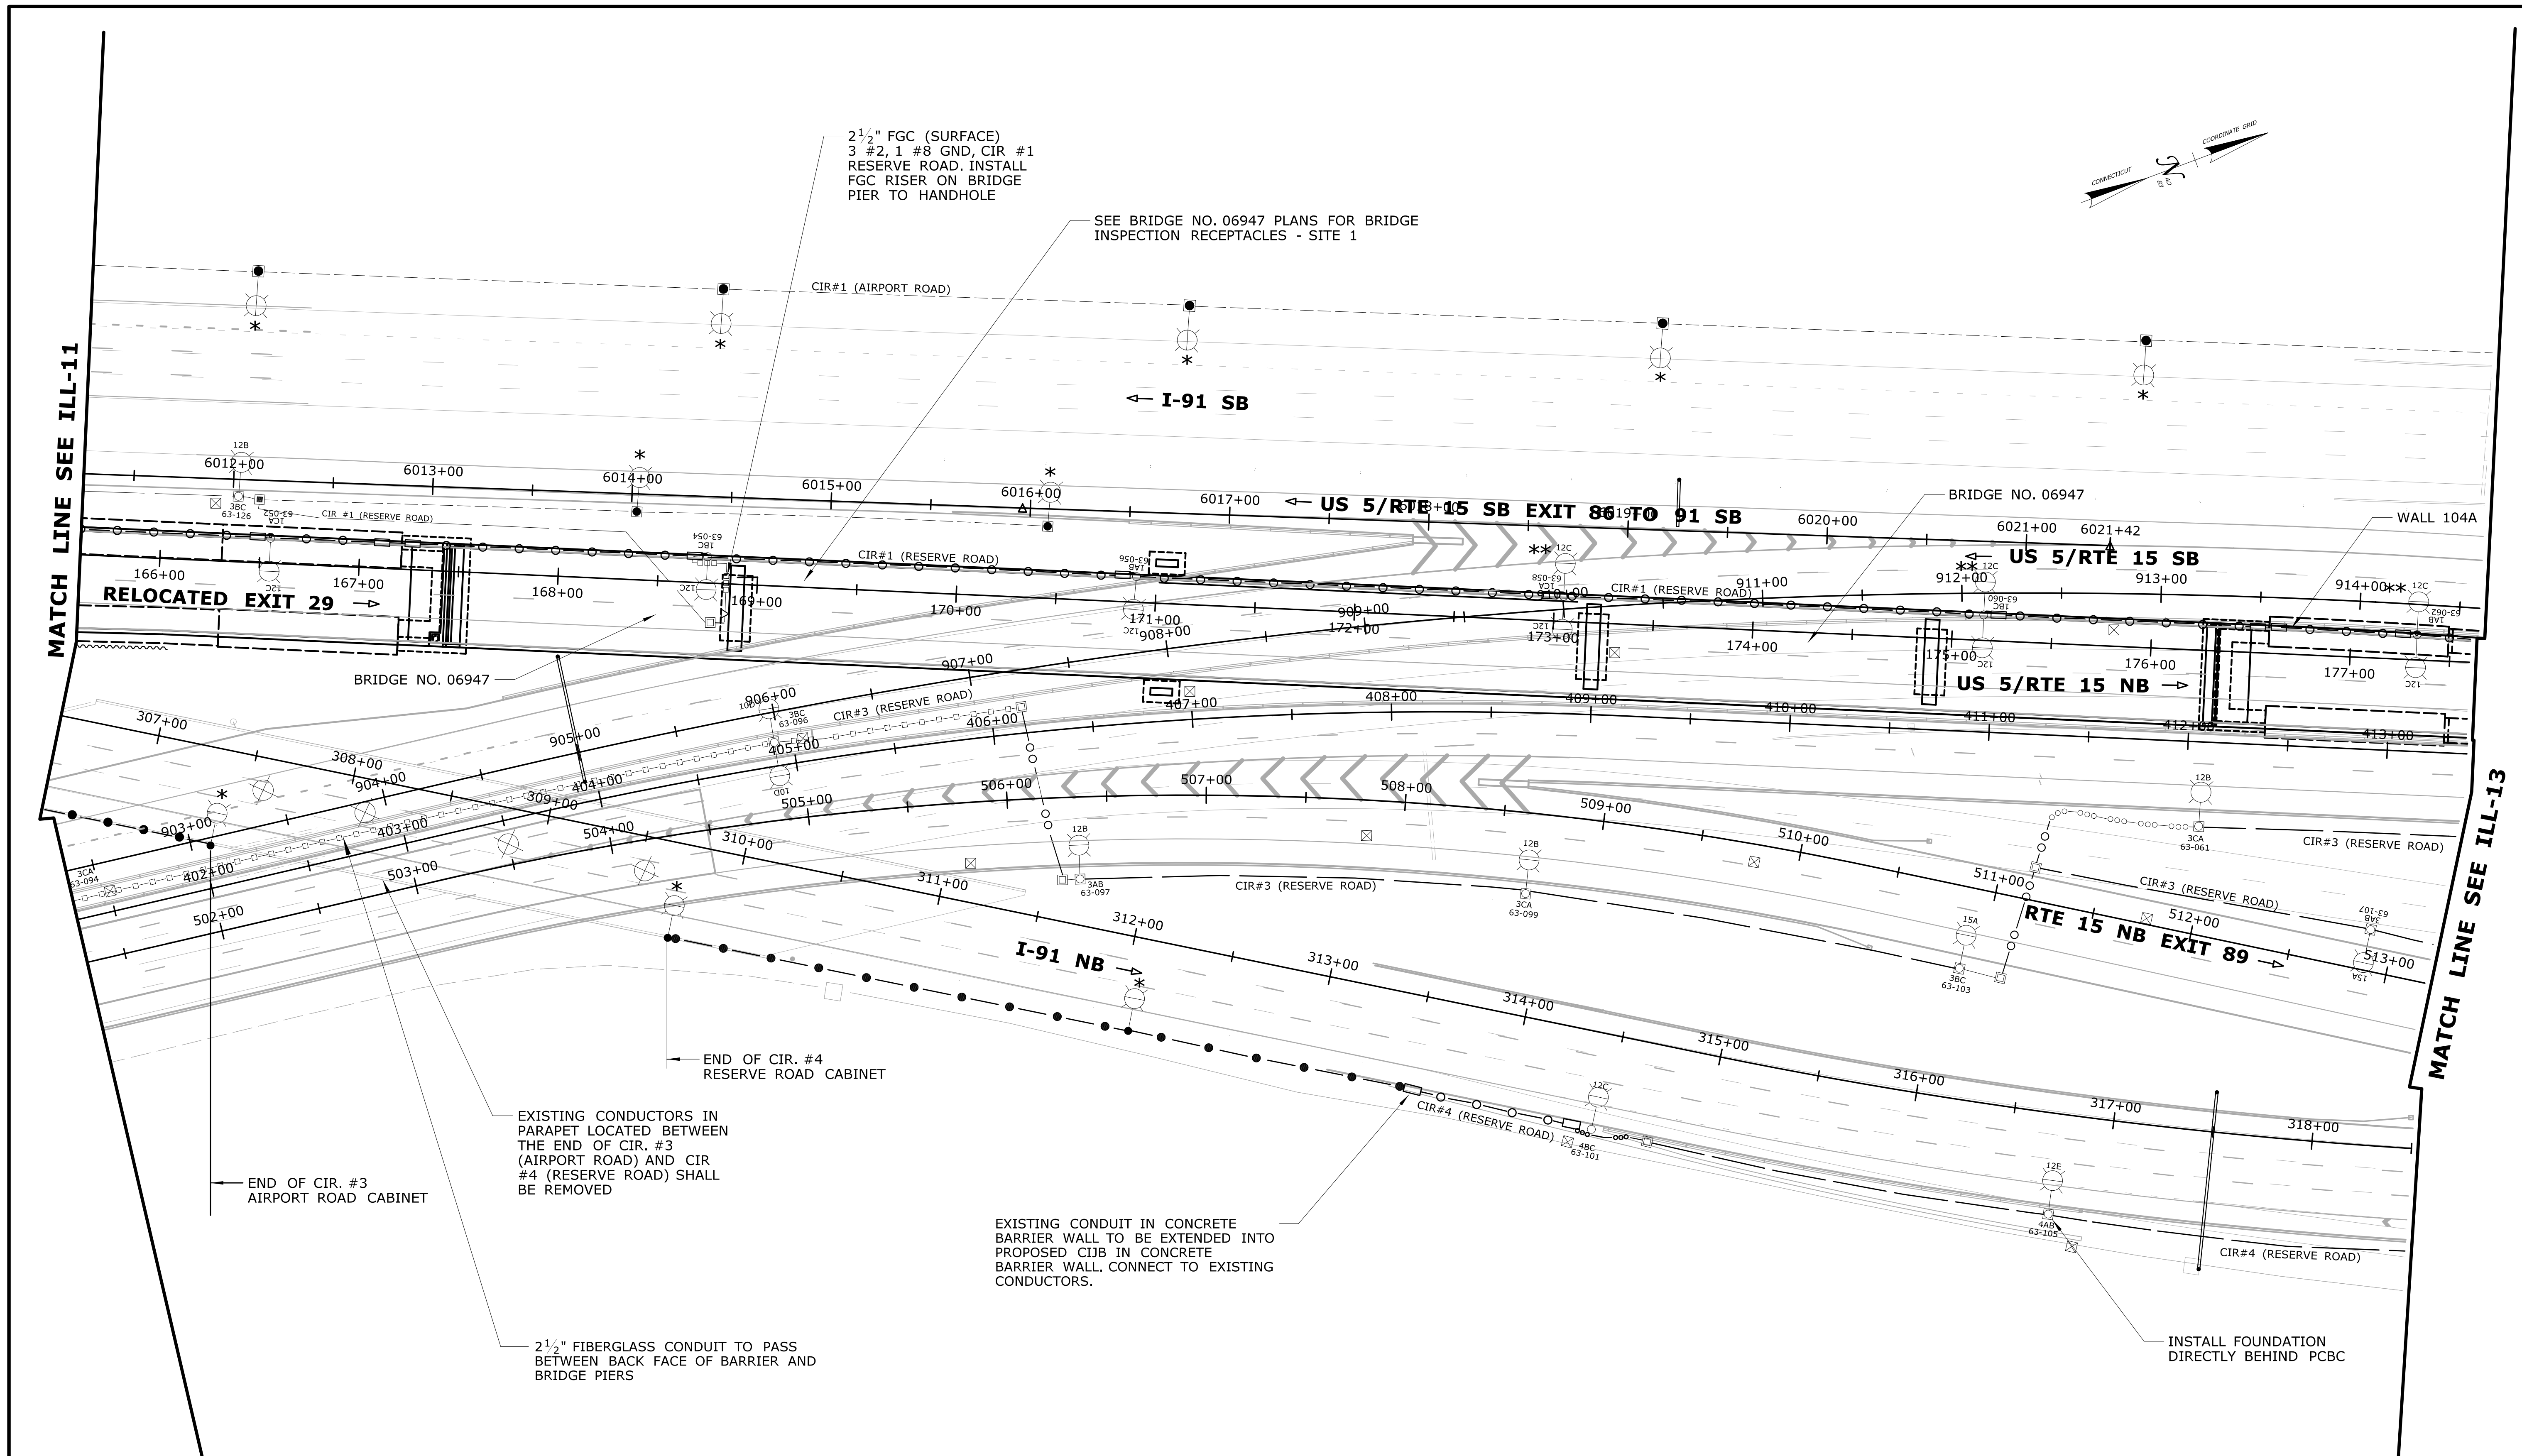
SIGNATURE/BLOCK:  
 OFFICE OF ENGINEERING  
 APPROVED BY: *Chapman*

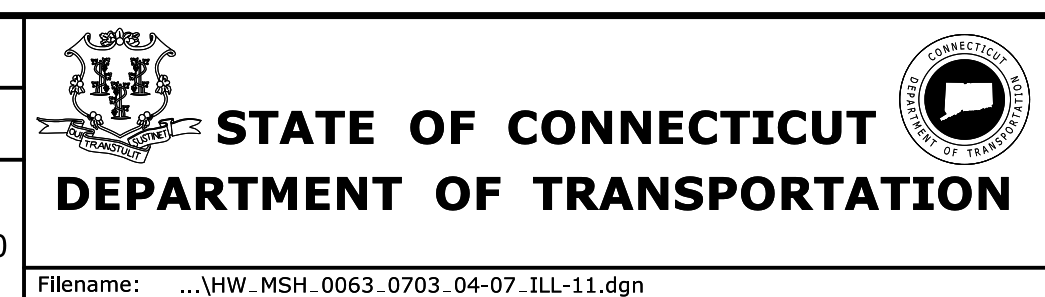PROJECT TITLE:  
**RELOCATION OF I-91 NB INTERCHANGE 29 AND WIDENING OF I-91 NB AND ROUTE 15 NB TO I-84 EB**

EDR/OWNER: **HARTFORD EAST HARTFORD**  
 DRAWING TITLE: **ILLUMINATION PLAN**

PROJECT NO. **63-703**  
 DRAWING NO. **ILL-11**  
 SHEET NO. **01.11.02.11**

Filename: ...VHW\_MSH\_0063\_0703\_04-07\_ILL-11.dgn



MATCH LINE SEE ILL-11

MATCH LINE SEE ILL-13

\*CONTRACTOR TO REMOVE EXISTING LUMINAIRE AND INSTALL LED LUMINAIRE ONLY. ALL ELSE TO REMAIN

\*\* CLAMP ON LUMINAIRE BRACKET TO BE INSTALLED SO THAT THE BACKSIDE LUMINAIRE IS 40' ABOVE THE LOWER ROADWAY.

REV.	DATE	REVISION DESCRIPTION	SHEET NO.


THE INFORMATION, INCLUDING ESTIMATED QUANTITIES OF WORK, SHOWN ON THESE SHEETS IS BASED ON LIMITED INVESTIGATIONS BY THE STATE AND IS IN NO WAY WARRANTED TO INDICATE THE CONDITIONS OF ACTUAL QUANTITIES OF WORK WHICH WILL BE REQUIRED.

Plotted Date: 5/14/2018

DESIGNER/DRAFTER:  
DDR

CHECKED BY:  
MSB

SCALE IN FEET  
0 40 80  
SCALE 1"=40'

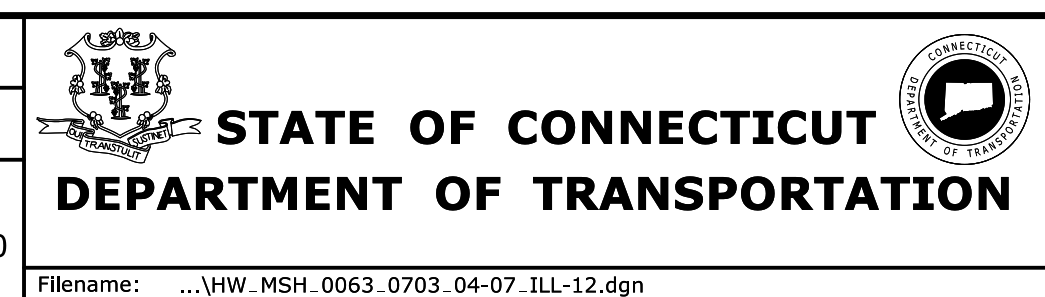

SIGNATURE/  
BLOCK:  
OFFICE OF ENGINEERING

APPROVED BY:  
*Chapman*


PROJECT TITLE:  
**RELOCATION OF I-91 NB  
INTERCHANGE 29 AND WIDENING  
OF I-91 NB AND ROUTE 15 NB  
TO I-84 EB**

EDR/REOWN:  
**HARTFORD  
EAST HARTFORD  
ILLUMINATION  
PLAN**

PROJECT NO.  
**63-703**

DRAWING NO.  
**ILL-12**

SHEET NO.  
01.11.02.12

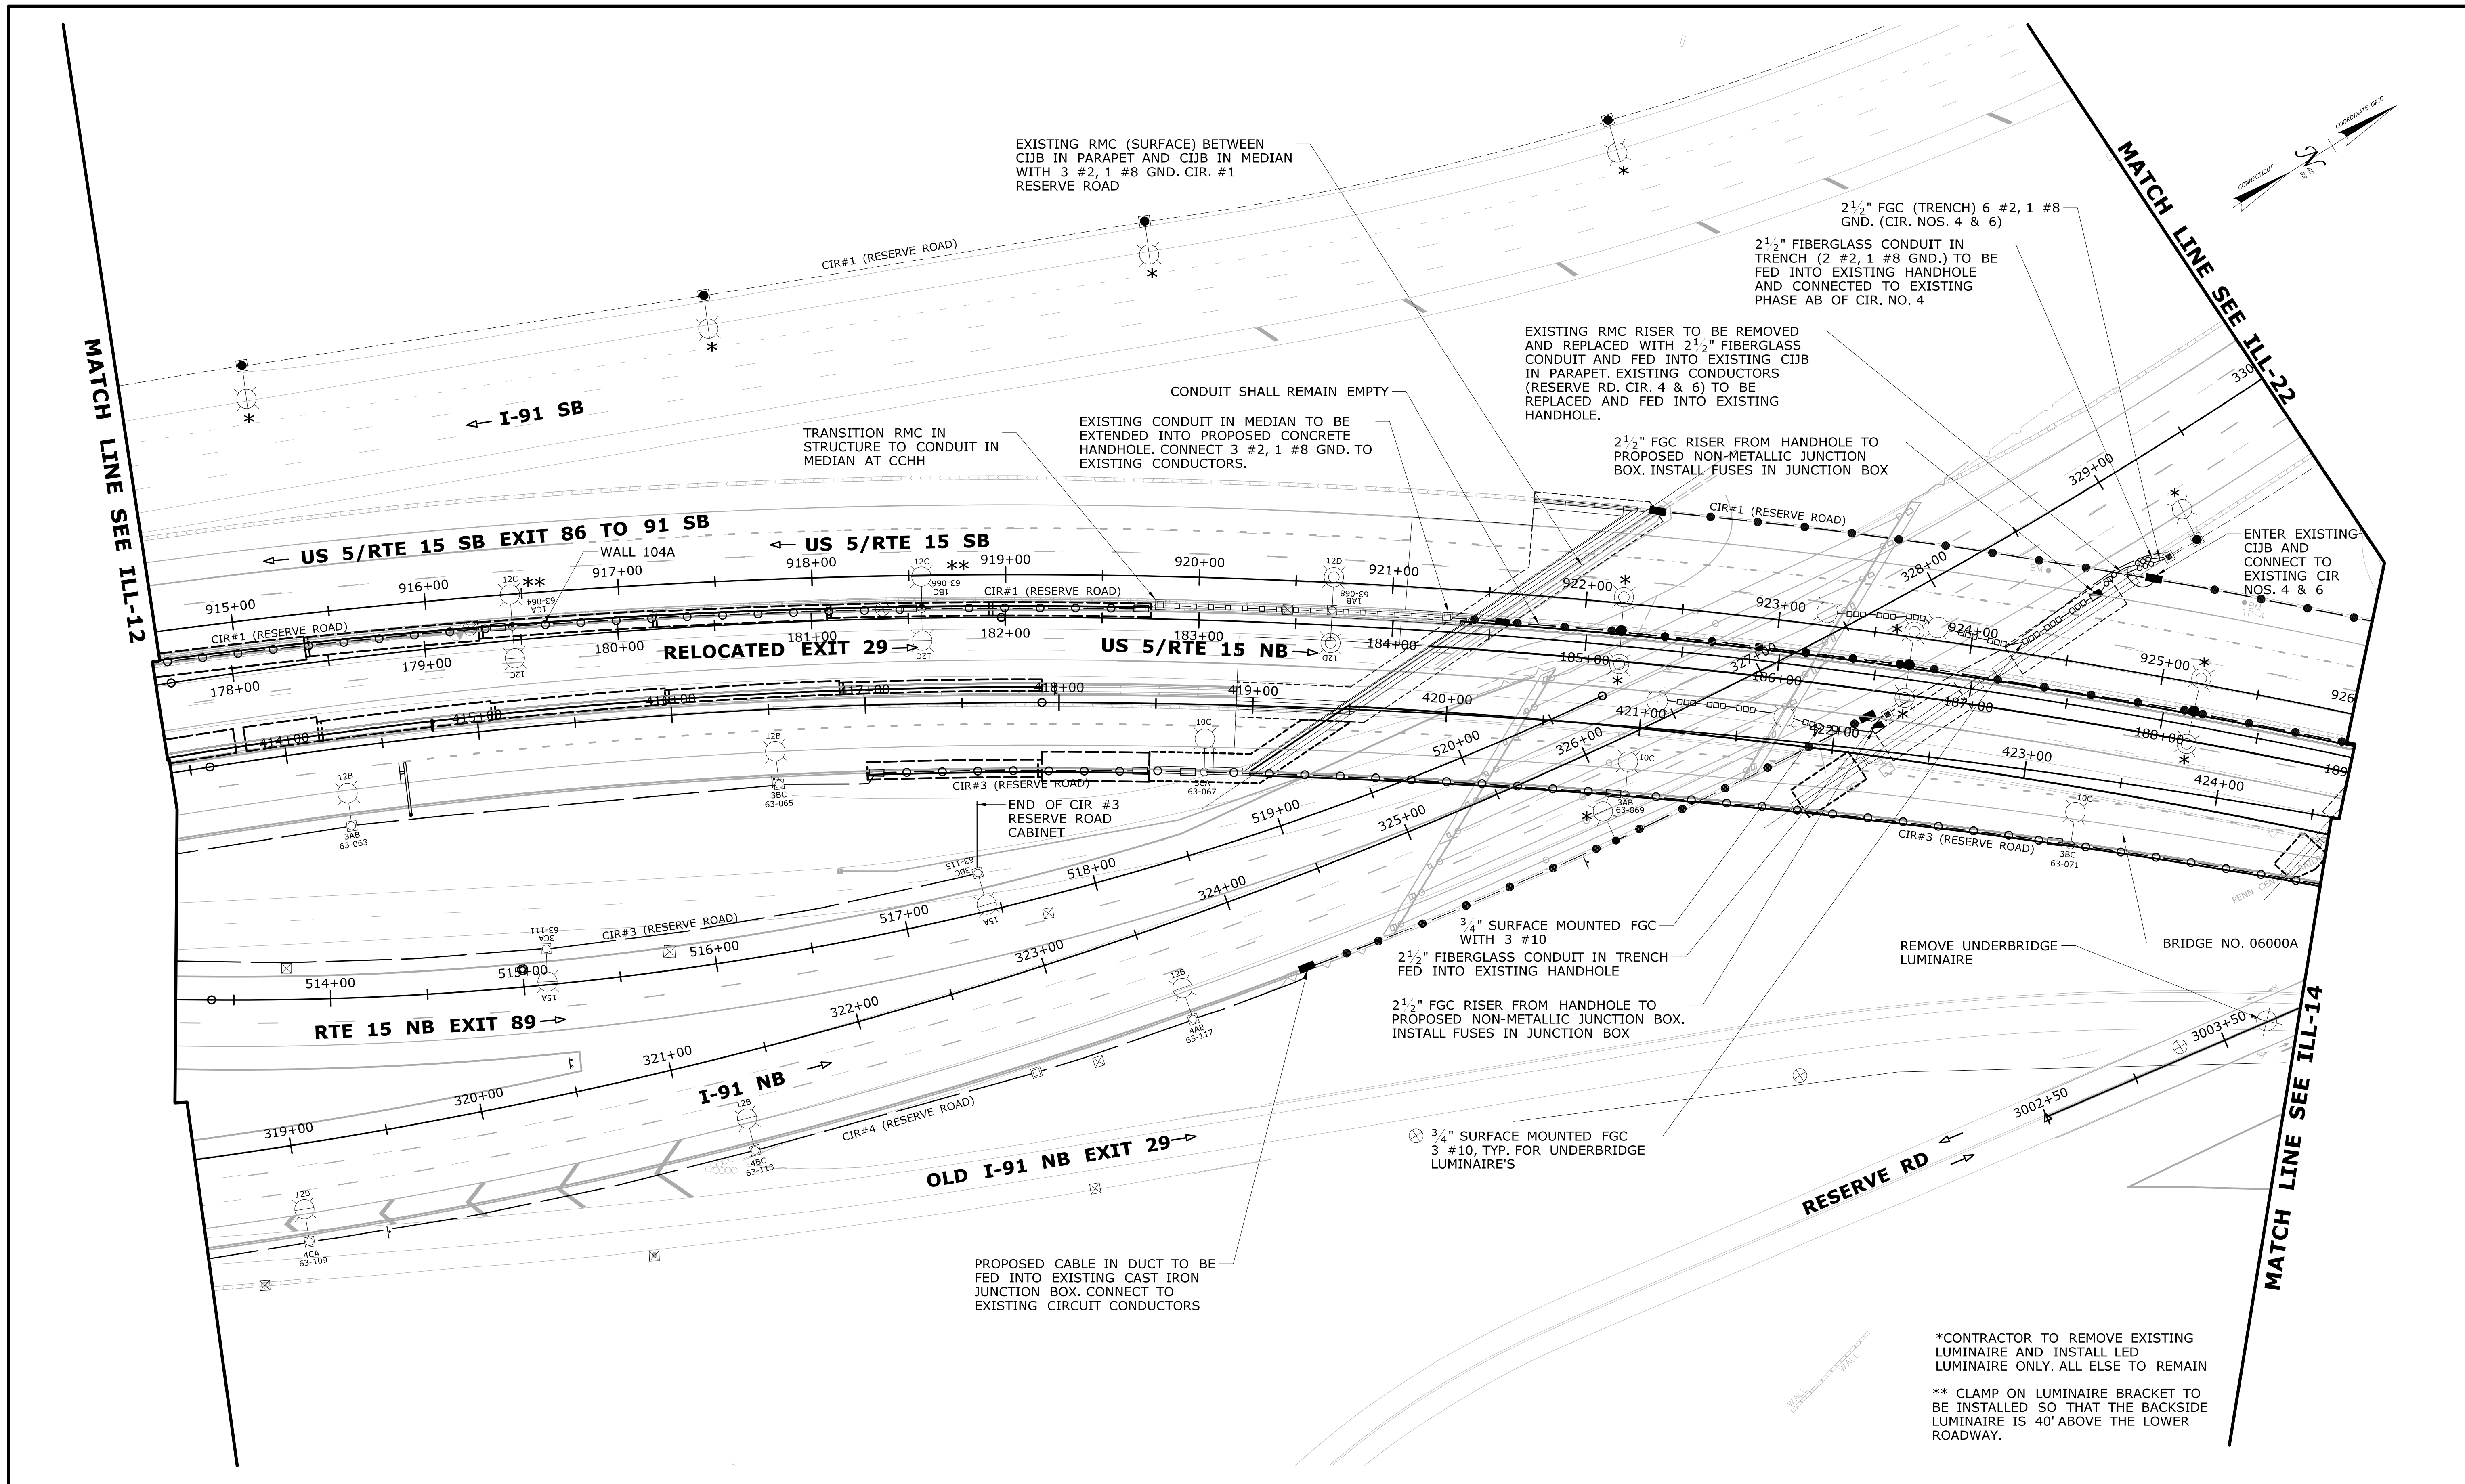


REV.	DATE	REVISION DESCRIPTION	SHEET NO.

THE INFORMATION, INCLUDING ESTIMATED QUANTITIES OF WORK, SHOWN ON THESE SHEETS IS BASED ON LIMITED INVESTIGATIONS BY THE STATE AND IS IN NO WAY WARRANTED TO INDICATE THE CONDITIONS OF ACTUAL QUANTITIES OF WORK WHICH WILL BE REQUIRED.

Plotted Date: 5/14/2018

DESIGNER/DRAFTER: DDR  
 CHECKED BY: MSB  
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 SCALE 1"=40'

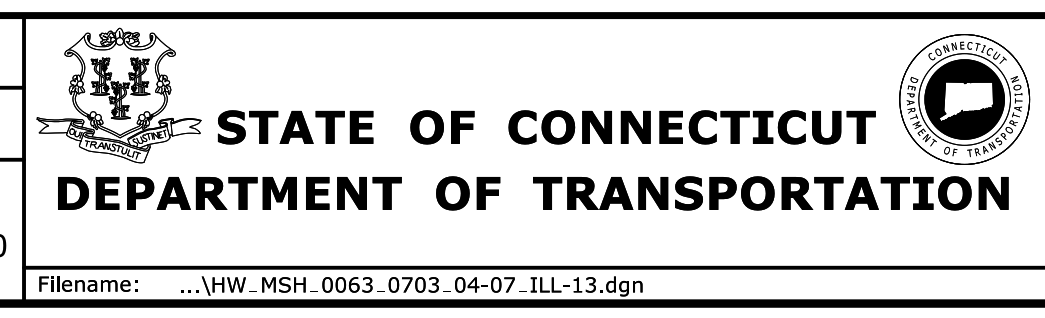


SIGNATURE/BLOCK:  
 OFFICE OF ENGINEERING  
 APPROVED BY:

PROJECT TITLE:  
**RELOCATION OF I-91 NB INTERCHANGE 29 AND WIDENING OF I-91 NB AND ROUTE 15 NB TO I-84 EB**

OWNER:  
**HARTFORD EAST HARTFORD**

DRAWING TITLE:  
**ILLUMINATION PLAN**

PROJECT NO.: **63-703**  
 DRAWING NO.: **ILL-13**  
 SHEET NO.: **01.11.02.13**

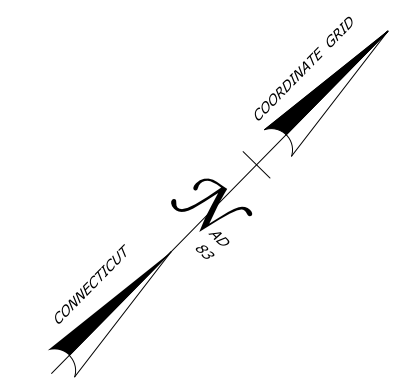

2 1/2" FGC IN TRENCH WITH 3 #2, 1 #8 GND. CIR. #3

MATCH LINE SEE ILL-19


RESERVE RD

BRIDGE NO. 06000A

EXISTING RESERVE ROAD LIGHTING CONTROL CABINET

BRIDGE PIER #3

ENTER EXISTING CCHH AND CONNECT TO EXISTING CIR. #3

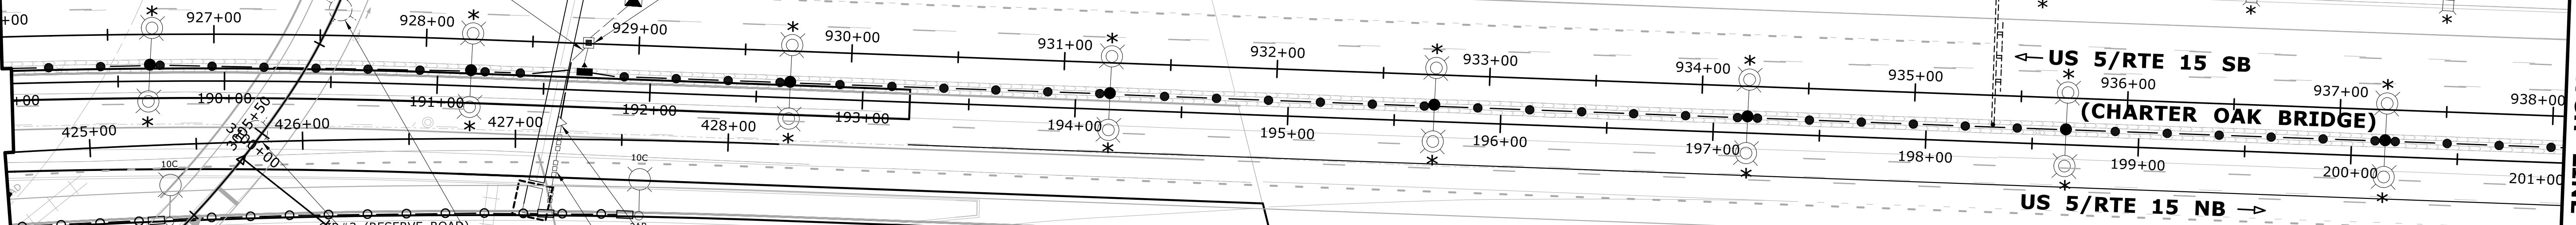

MATCH LINE SEE ILL-13

OLD I-91 NB EXIT 29

2 1/2" FGC RISER WITH 3 #2, 1 #8 GND. CIR #3


2 1/2" FGC (SURFACE) WITH 3 #2, 1 #8 GND. CIR #3

REMOVE EXISTING UNDERBRIDGE LUMINAIRE FROM EXISTING PENDANT BRACKET. INSTALL 1 1/4" TO 3/4" REDUCER ON EXISTING PENDANT BRACKET AND INSTALL NEW LED UNDERBRIDGE LUMINAIRE. CONNECT TO EXISTING CIRCUIT. EXISTING BRACKET, CONDUIT, AND CONDUCTORS TO REMAIN.

MATCH LINE SEE ILL-15


\*CONTRACTOR TO REMOVE EXISTING LUMINAIRE AND INSTALL LED LUMINAIRE ONLY. ALL ELSE TO REMAIN

THE INFORMATION, INCLUDING ESTIMATED QUANTITIES OF WORK, SHOWN ON THESE SHEETS IS BASED ON LIMITED INVESTIGATIONS BY THE STATE AND IS IN NO WAY WARRANTED TO INDICATE THE CONDITIONS OF ACTUAL QUANTITIES OF WORK WHICH WILL BE REQUIRED.		DESIGNER/DRAFTER: DDR	STATE OF CONNECTICUT DEPARTMENT OF TRANSPORTATION	SIGNATURE/ BLOCK:  	PROJECT TITLE: <b>RELOCATION OF I-91 NB INTERCHANGE 29 AND WIDENING OF I-91 NB AND ROUTE 15 NB TO I-84 EB</b>	EDR/REOWN: <b>HARTFORD EAST HARTFORD</b>	PROJECT NO. <b>63-703</b>
CHECKED BY: MSB	SCALE IN FEET 0 40 80 SCALE 1"=40'	APPROVED BY:  		DRAWING TITLE: <b>ILLUMINATION PLAN</b>	DRAWING NO. <b>ILL-14</b>	SHEET NO. 01.11.02.14	
REV. DATE REVISION DESCRIPTION SHEET NO. Plotted Date: 4/30/2018	Filename: ...VHW_MSH_0063_0703_04-07_ILL-14.dgn						

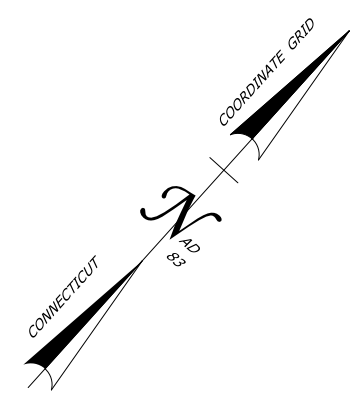

MATCH LINE SEE ILL-14


MATCH LINE SEE ILL-16

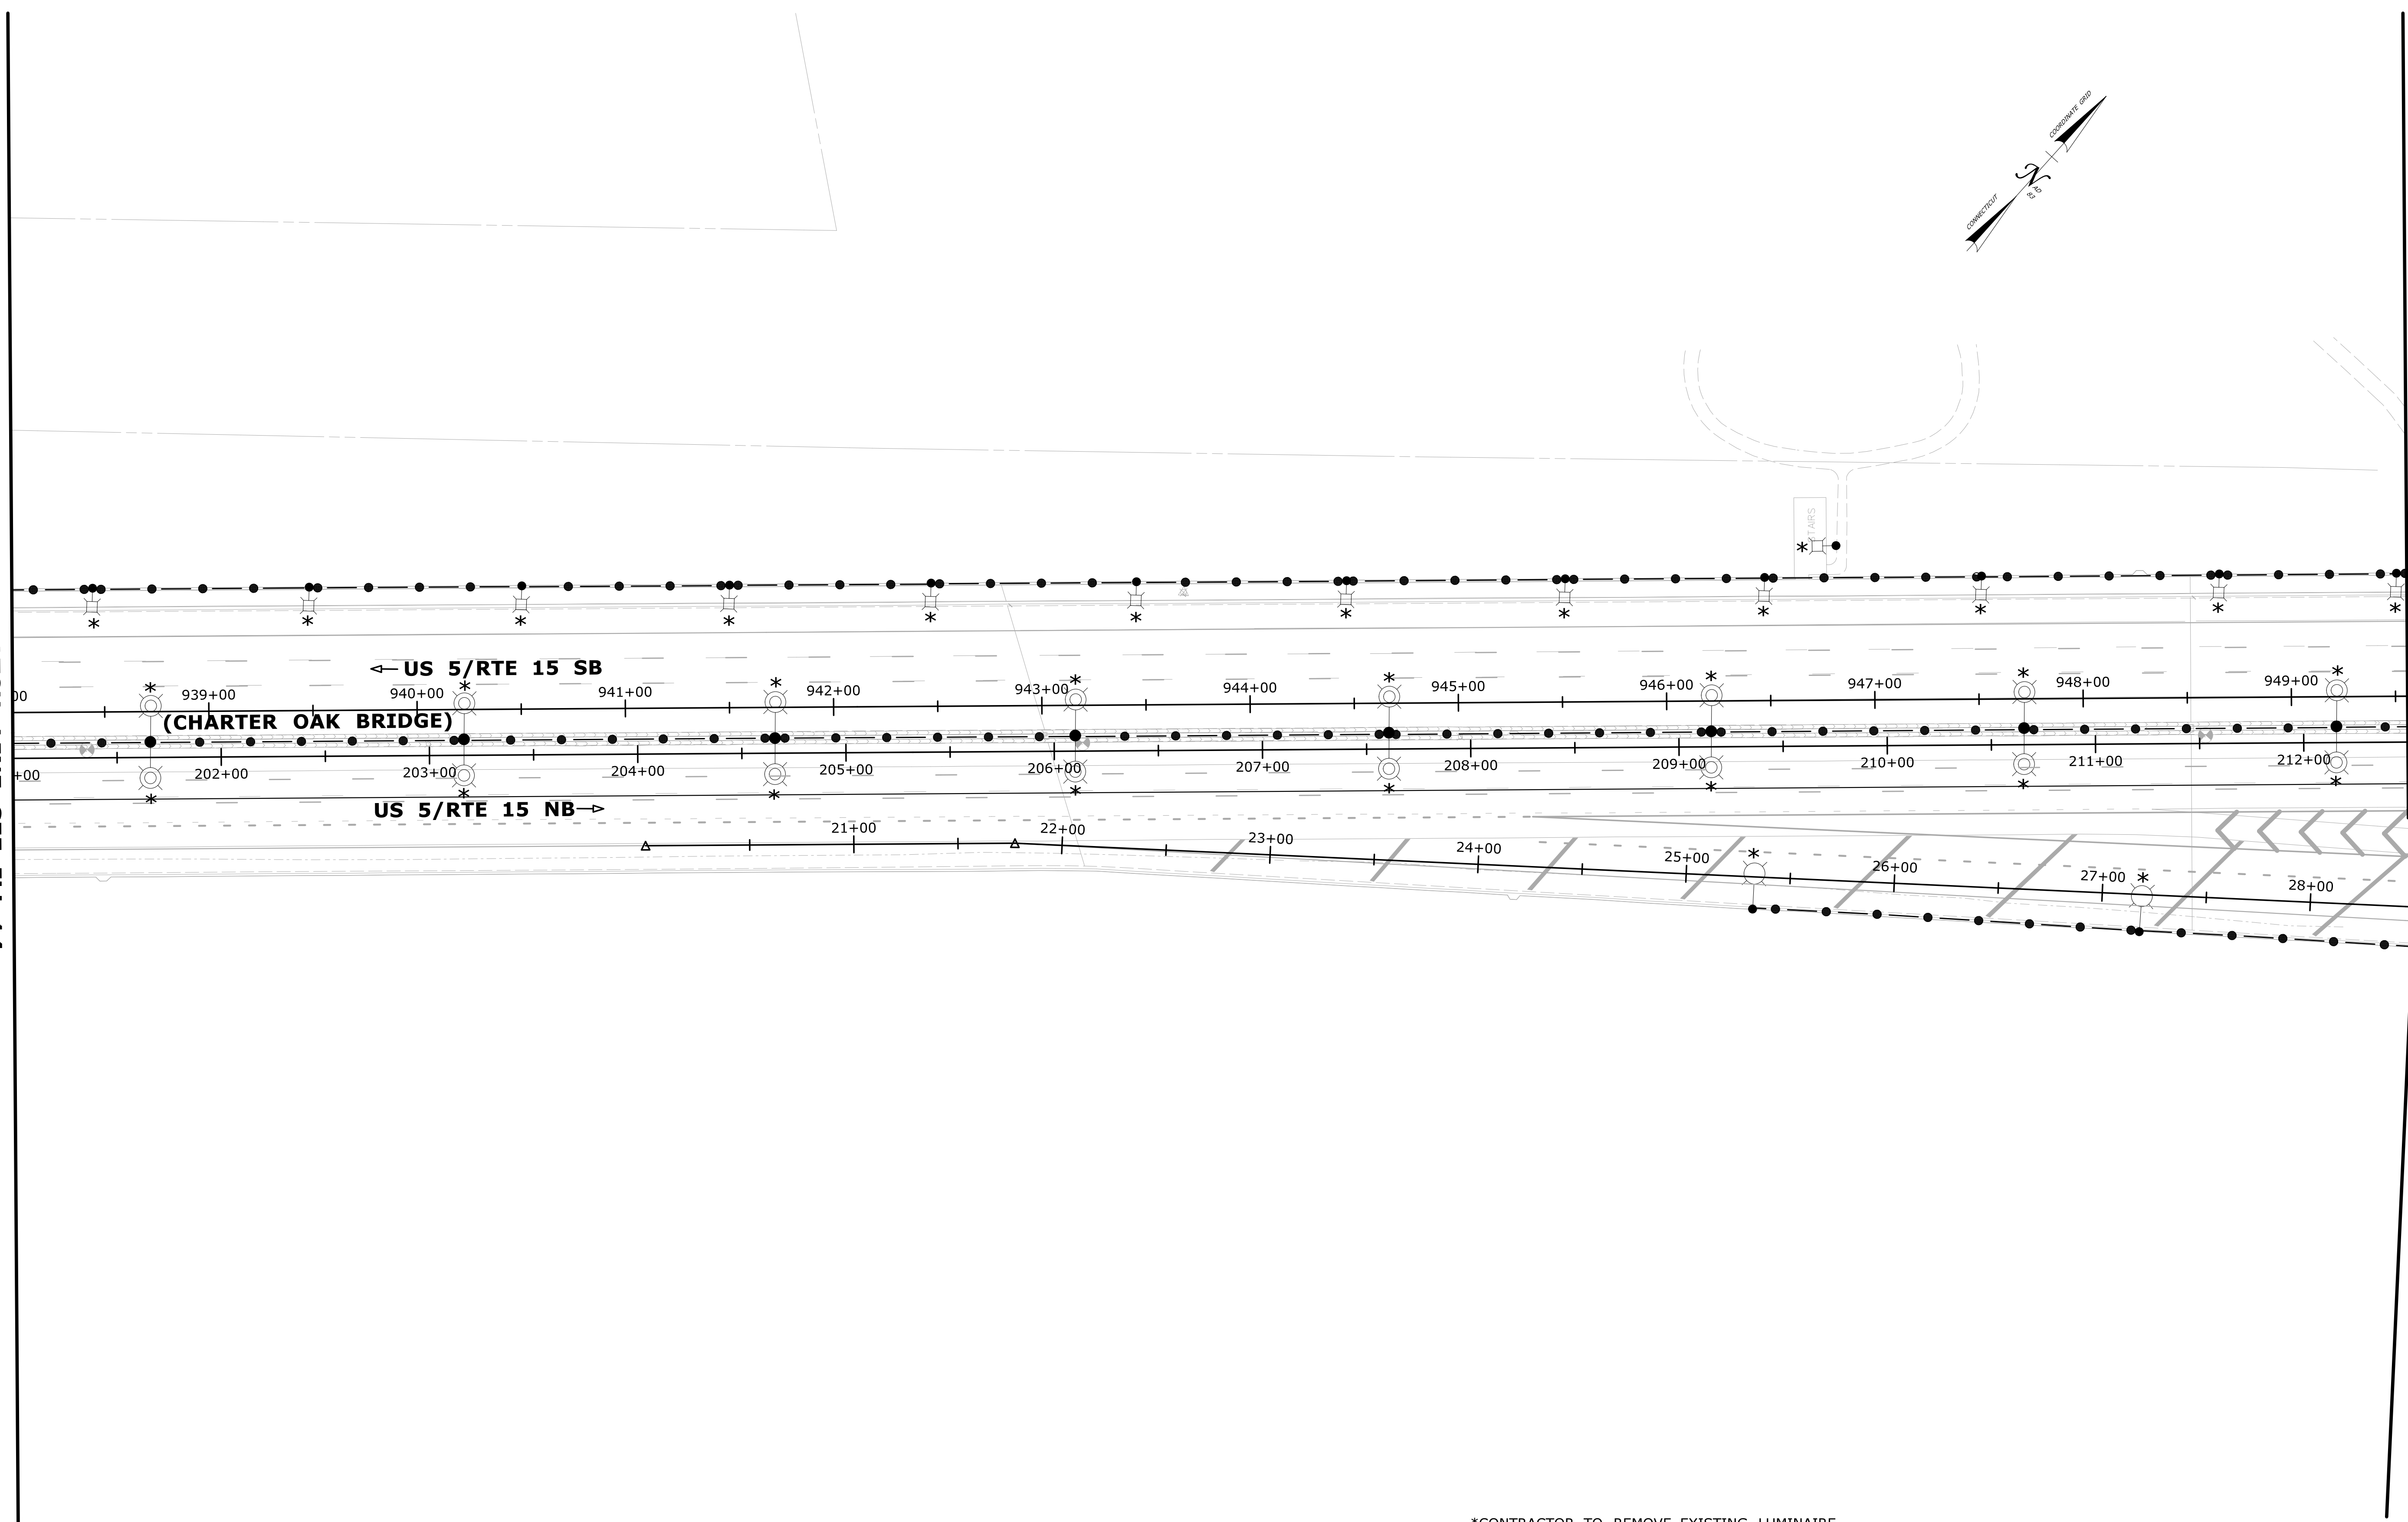

\*CONTRACTOR TO REMOVE EXISTING LUMINAIRE AND INSTALL LED LUMINAIRE ONLY. ALL ELSE TO REMAIN

			THE INFORMATION, INCLUDING ESTIMATED QUANTITIES OF WORK, SHOWN ON THESE SHEETS IS BASED ON LIMITED INVESTIGATIONS BY THE STATE AND IS IN NO WAY WARRANTED TO INDICATE THE CONDITIONS OF ACTUAL QUANTITIES OF WORK WHICH WILL BE REQUIRED.	DESIGNER/DRAFTER: DDR CHECKED BY: MSB SCALE IN FEET SCALE 1"=40' Plotted Date: 3/9/2018	<b>STATE OF CONNECTICUT</b> <b>DEPARTMENT OF TRANSPORTATION</b> <small>Filename: ...VHW_MSH_0063_0703_04-07_ILL-15.dgn</small>	SIGNATURE/ BLOCK: APPROVED BY:	PROJECT TITLE: <b>RELOCATION OF I-91 NB INTERCHANGE 29 AND WIDENING OF I-91 NB AND ROUTE 15 NB TO I-84 EB</b>	DRAWN BY: <b>HARTFORD EAST HARTFORD</b> DRAWING TITLE: <b>ILLUMINATION PLAN</b>	PROJECT NO. <b>63-703</b> DRAWING NO. <b>ILL-15</b> SHEET NO. 01.11.02.15
REV.	DATE	REVISION DESCRIPTION	SHEET NO.						



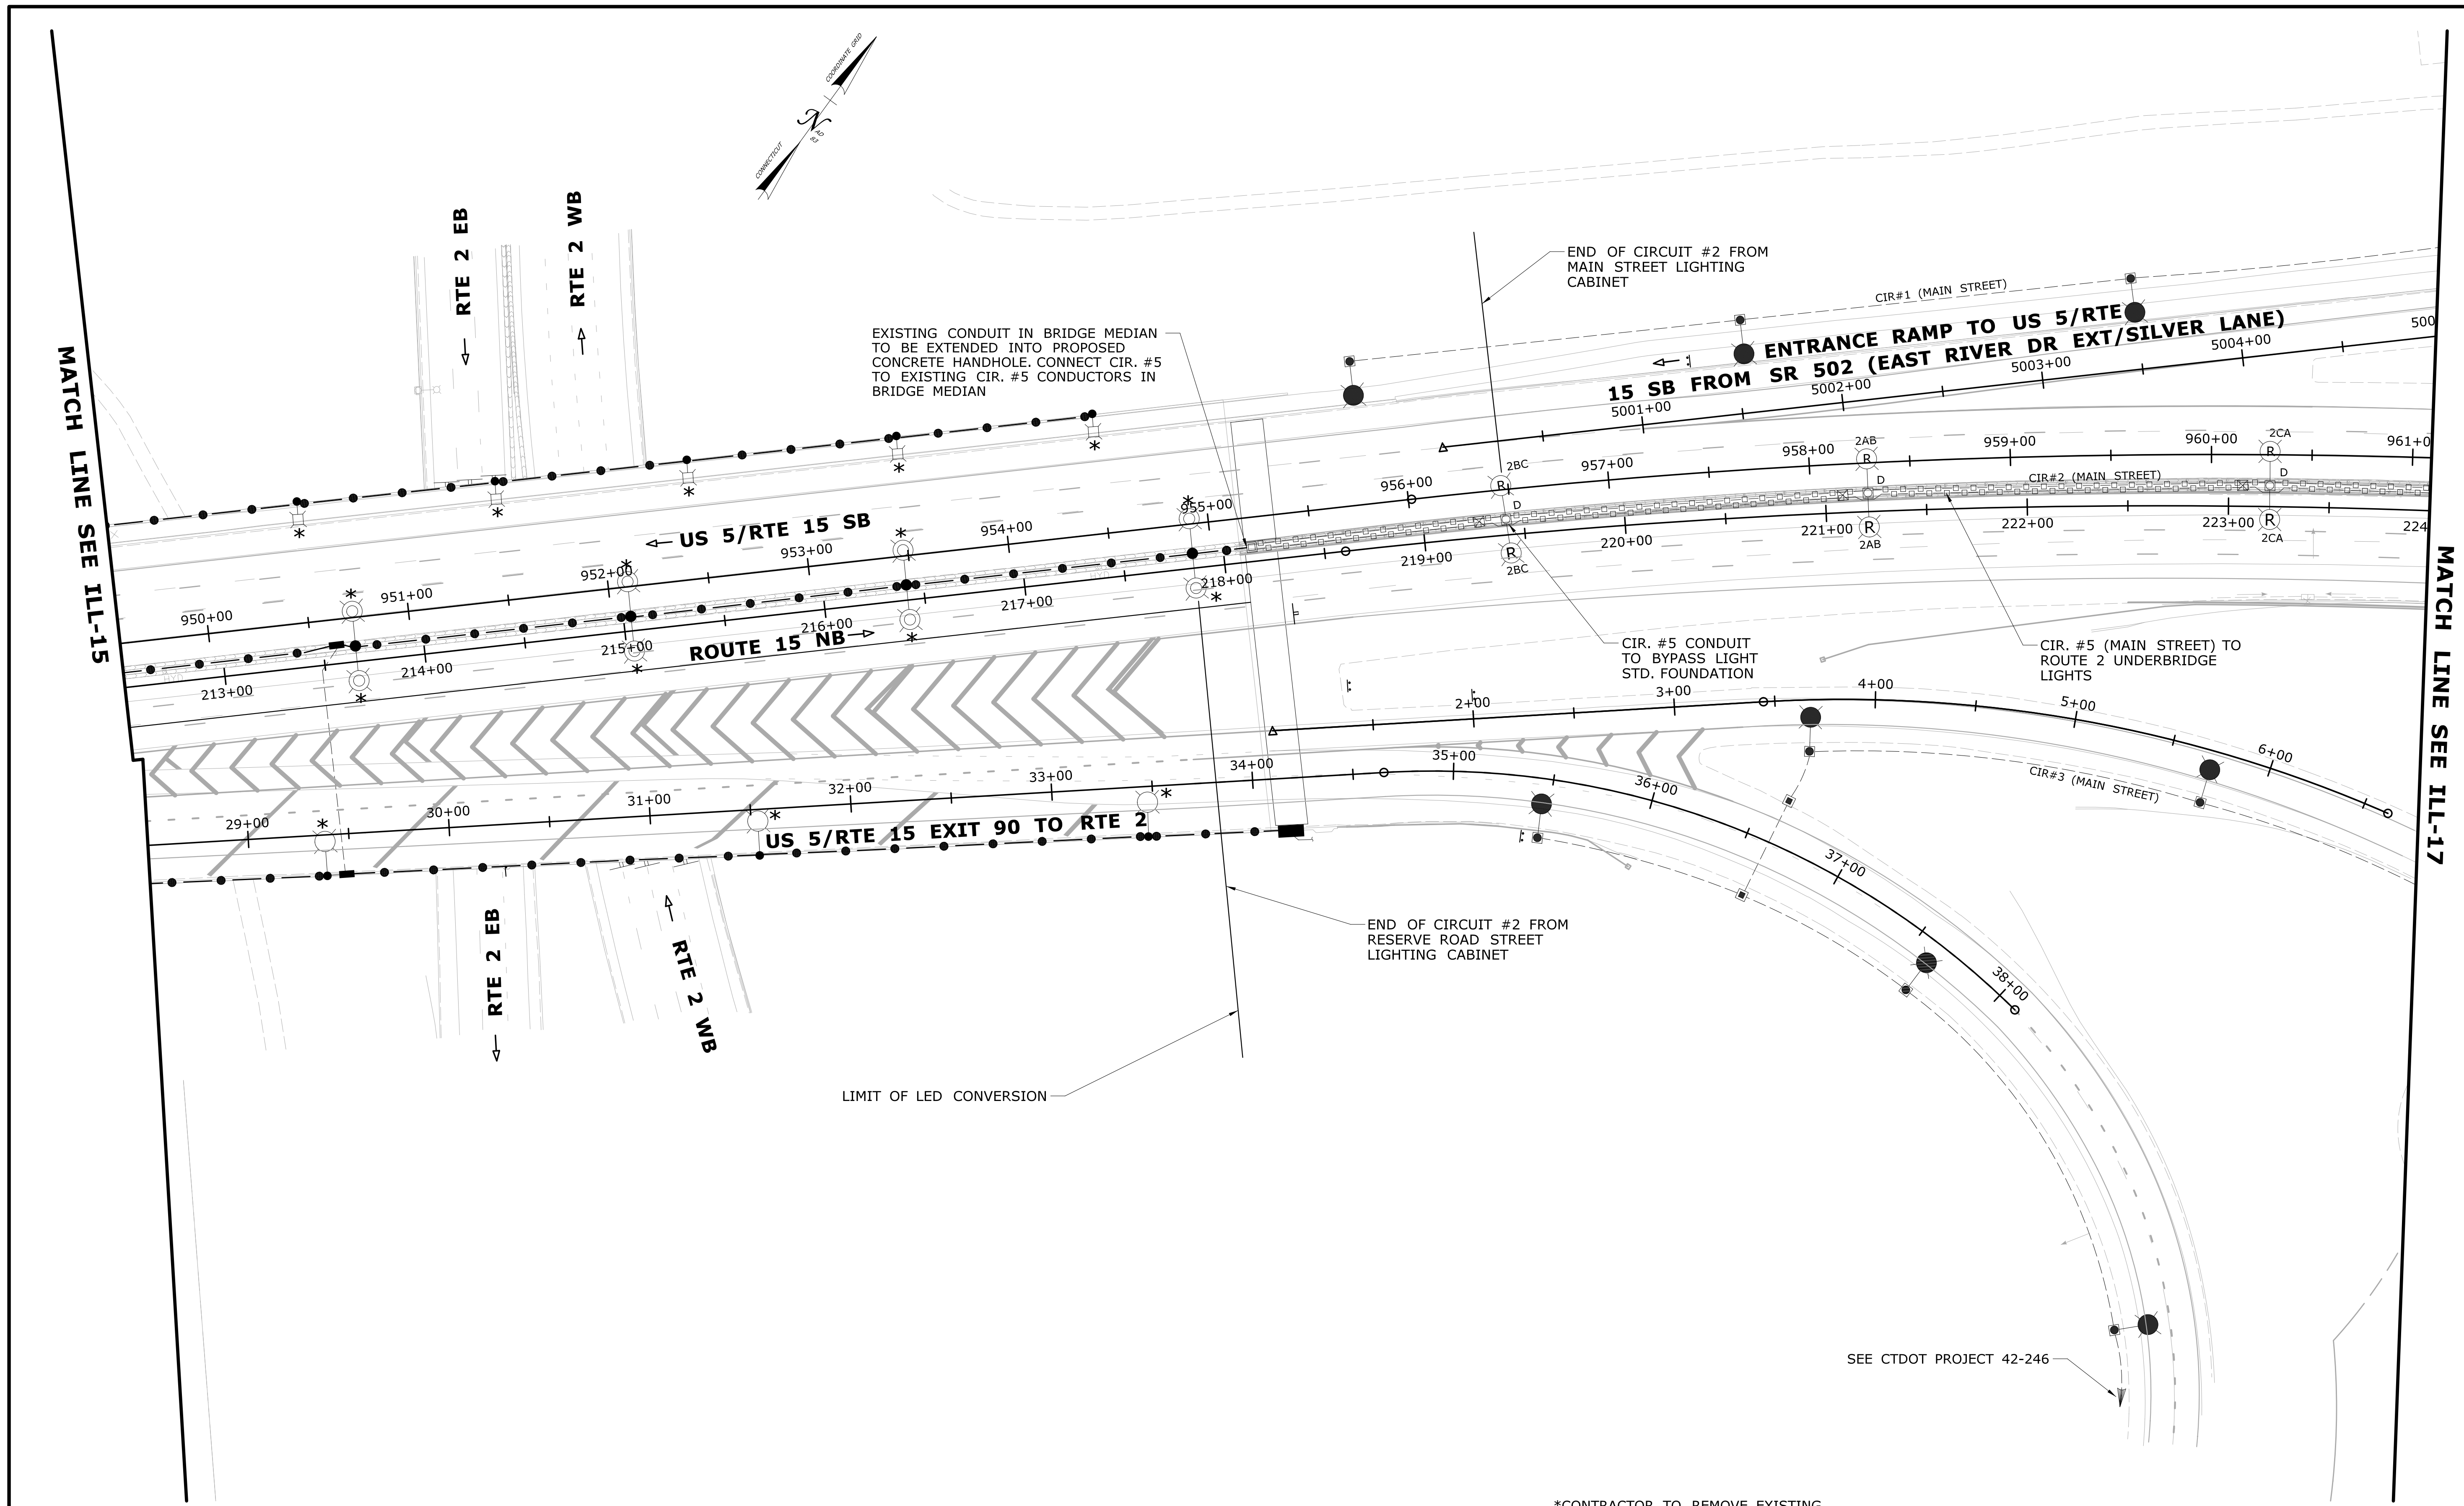


\*CONTRACTOR TO REMOVE EXISTING LUMINAIRE AND INSTALL LED LUMINAIRE ONLY. ALL ELSE TO REMAIN

REV.	DATE	REVISION DESCRIPTION	SHEET NO.

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Plotted Date: 3/9/2018

DESIGNER/DRAFTER: DDR  
 CHECKED BY: MSB  
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 SCALE 1"=40'


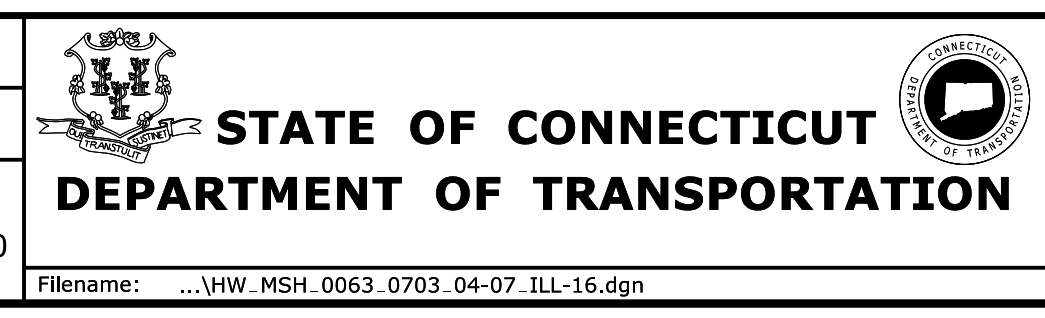


SIGNATURE/BLOCK:  
 OFFICE OF ENGINEERING  
 APPROVED BY: *Chapman*

PROJECT TITLE:  
**RELOCATION OF I-91 NB INTERCHANGE 29 AND WIDENING OF I-91 NB AND ROUTE 15 NB TO I-84 EB**

EDR/OWNER: **HARTFORD EAST HARTFORD**  
 DRAWING TITLE: **ILLUMINATION PLAN**

PROJECT NO. **63-703**  
 DRAWING NO. **ILL-16**  
 SHEET NO. **01.11.02.16**

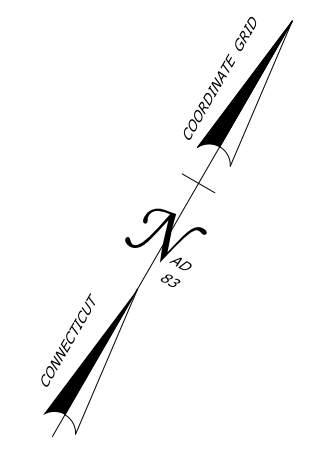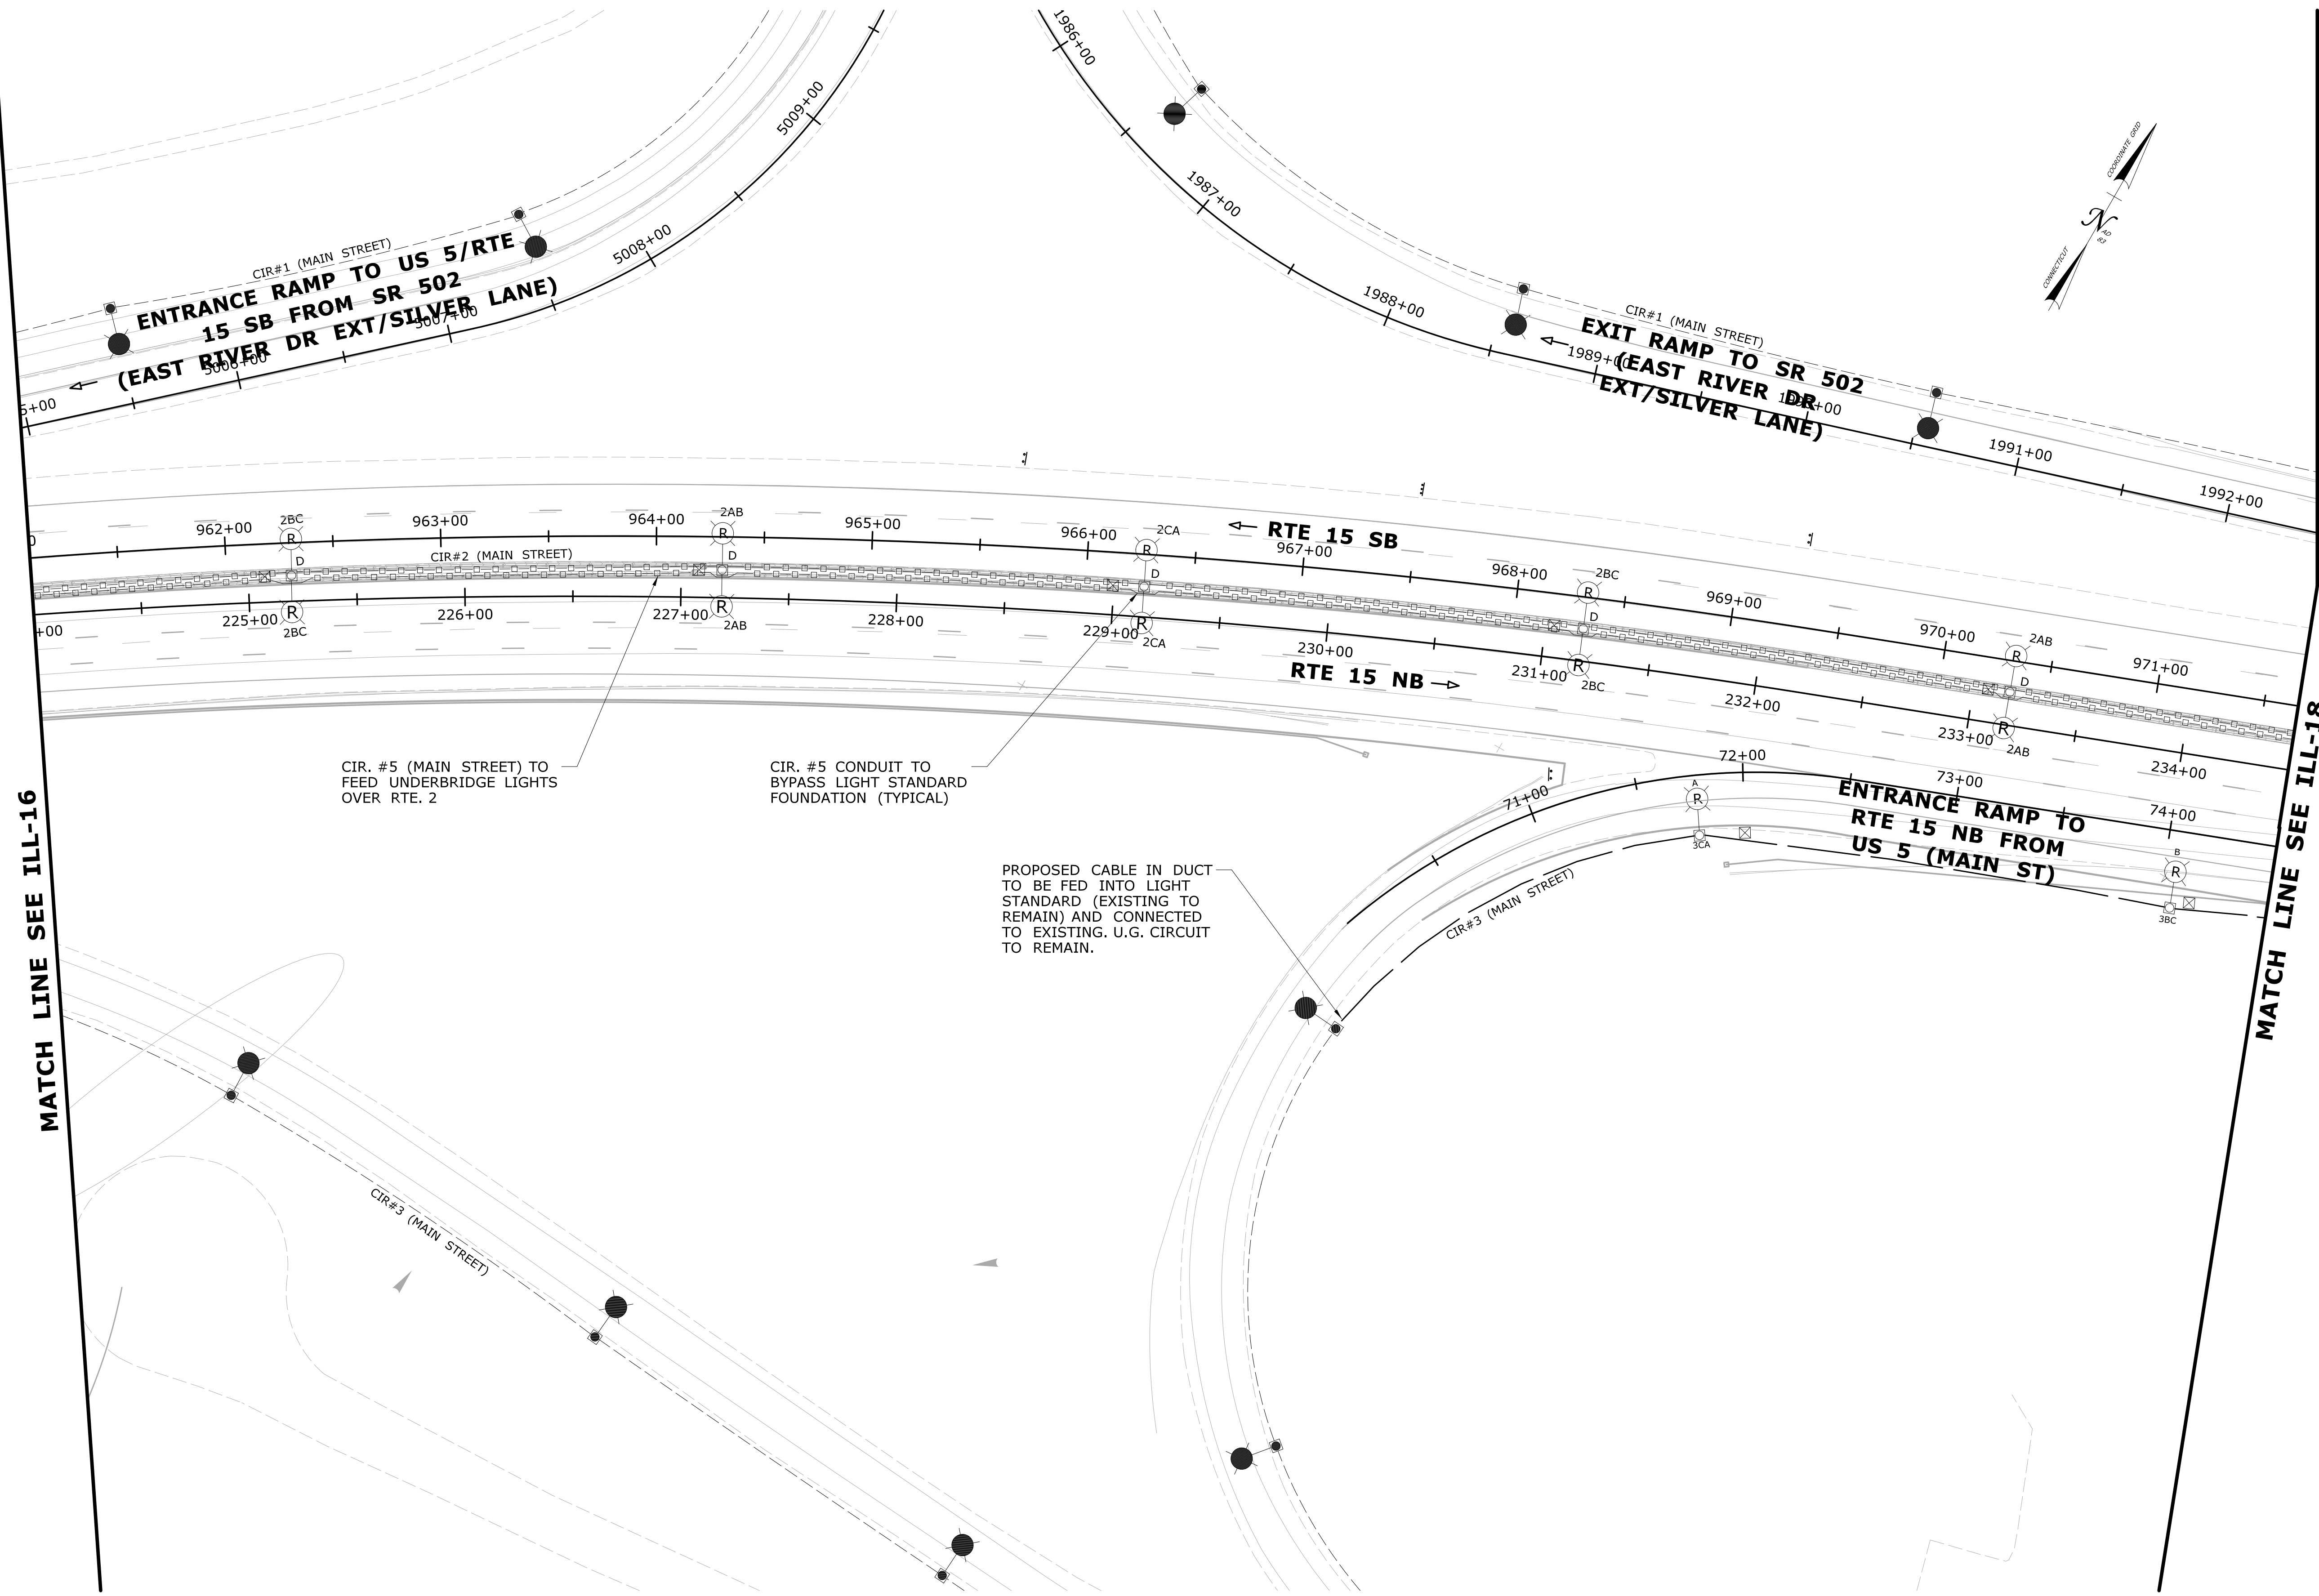


REV.	DATE	REVISION DESCRIPTION	SHEET NO.

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Plotted Date: 3/9/2018

DESIGNER/DRAFTER: DDR  
 CHECKED BY: MSB  
 SCALE IN FEET  
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 SCALE 1"=40'


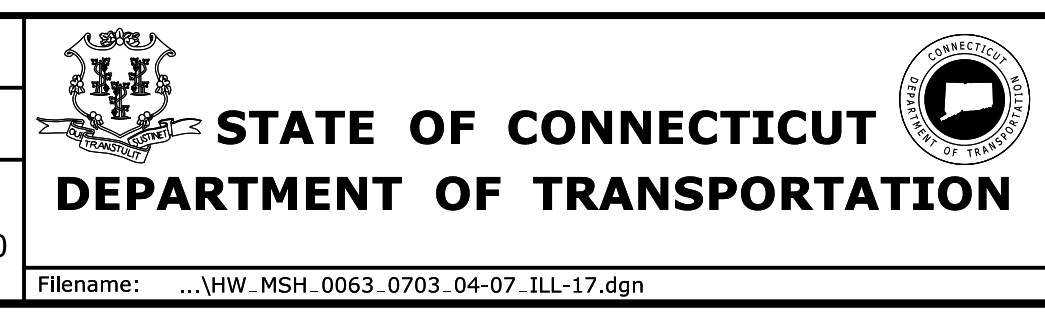


SIGNATURE/BLOCK:  
 OFFICE OF ENGINEERING  
 APPROVED BY: *Chapman*

PROJECT TITLE:  
**RELOCATION OF I-91 NB INTERCHANGE 29 AND WIDENING OF I-91 NB AND ROUTE 15 NB TO I-84 EB**

EDR/REOWN:  
**EAST HARTFORD**  
 DRAWING TITLE:  
**ILLUMINATION PLAN**

PROJECT NO.  
**63-703**  
 DRAWING NO.  
**ILL-17**  
 SHEET NO.  
 01.11.02.17

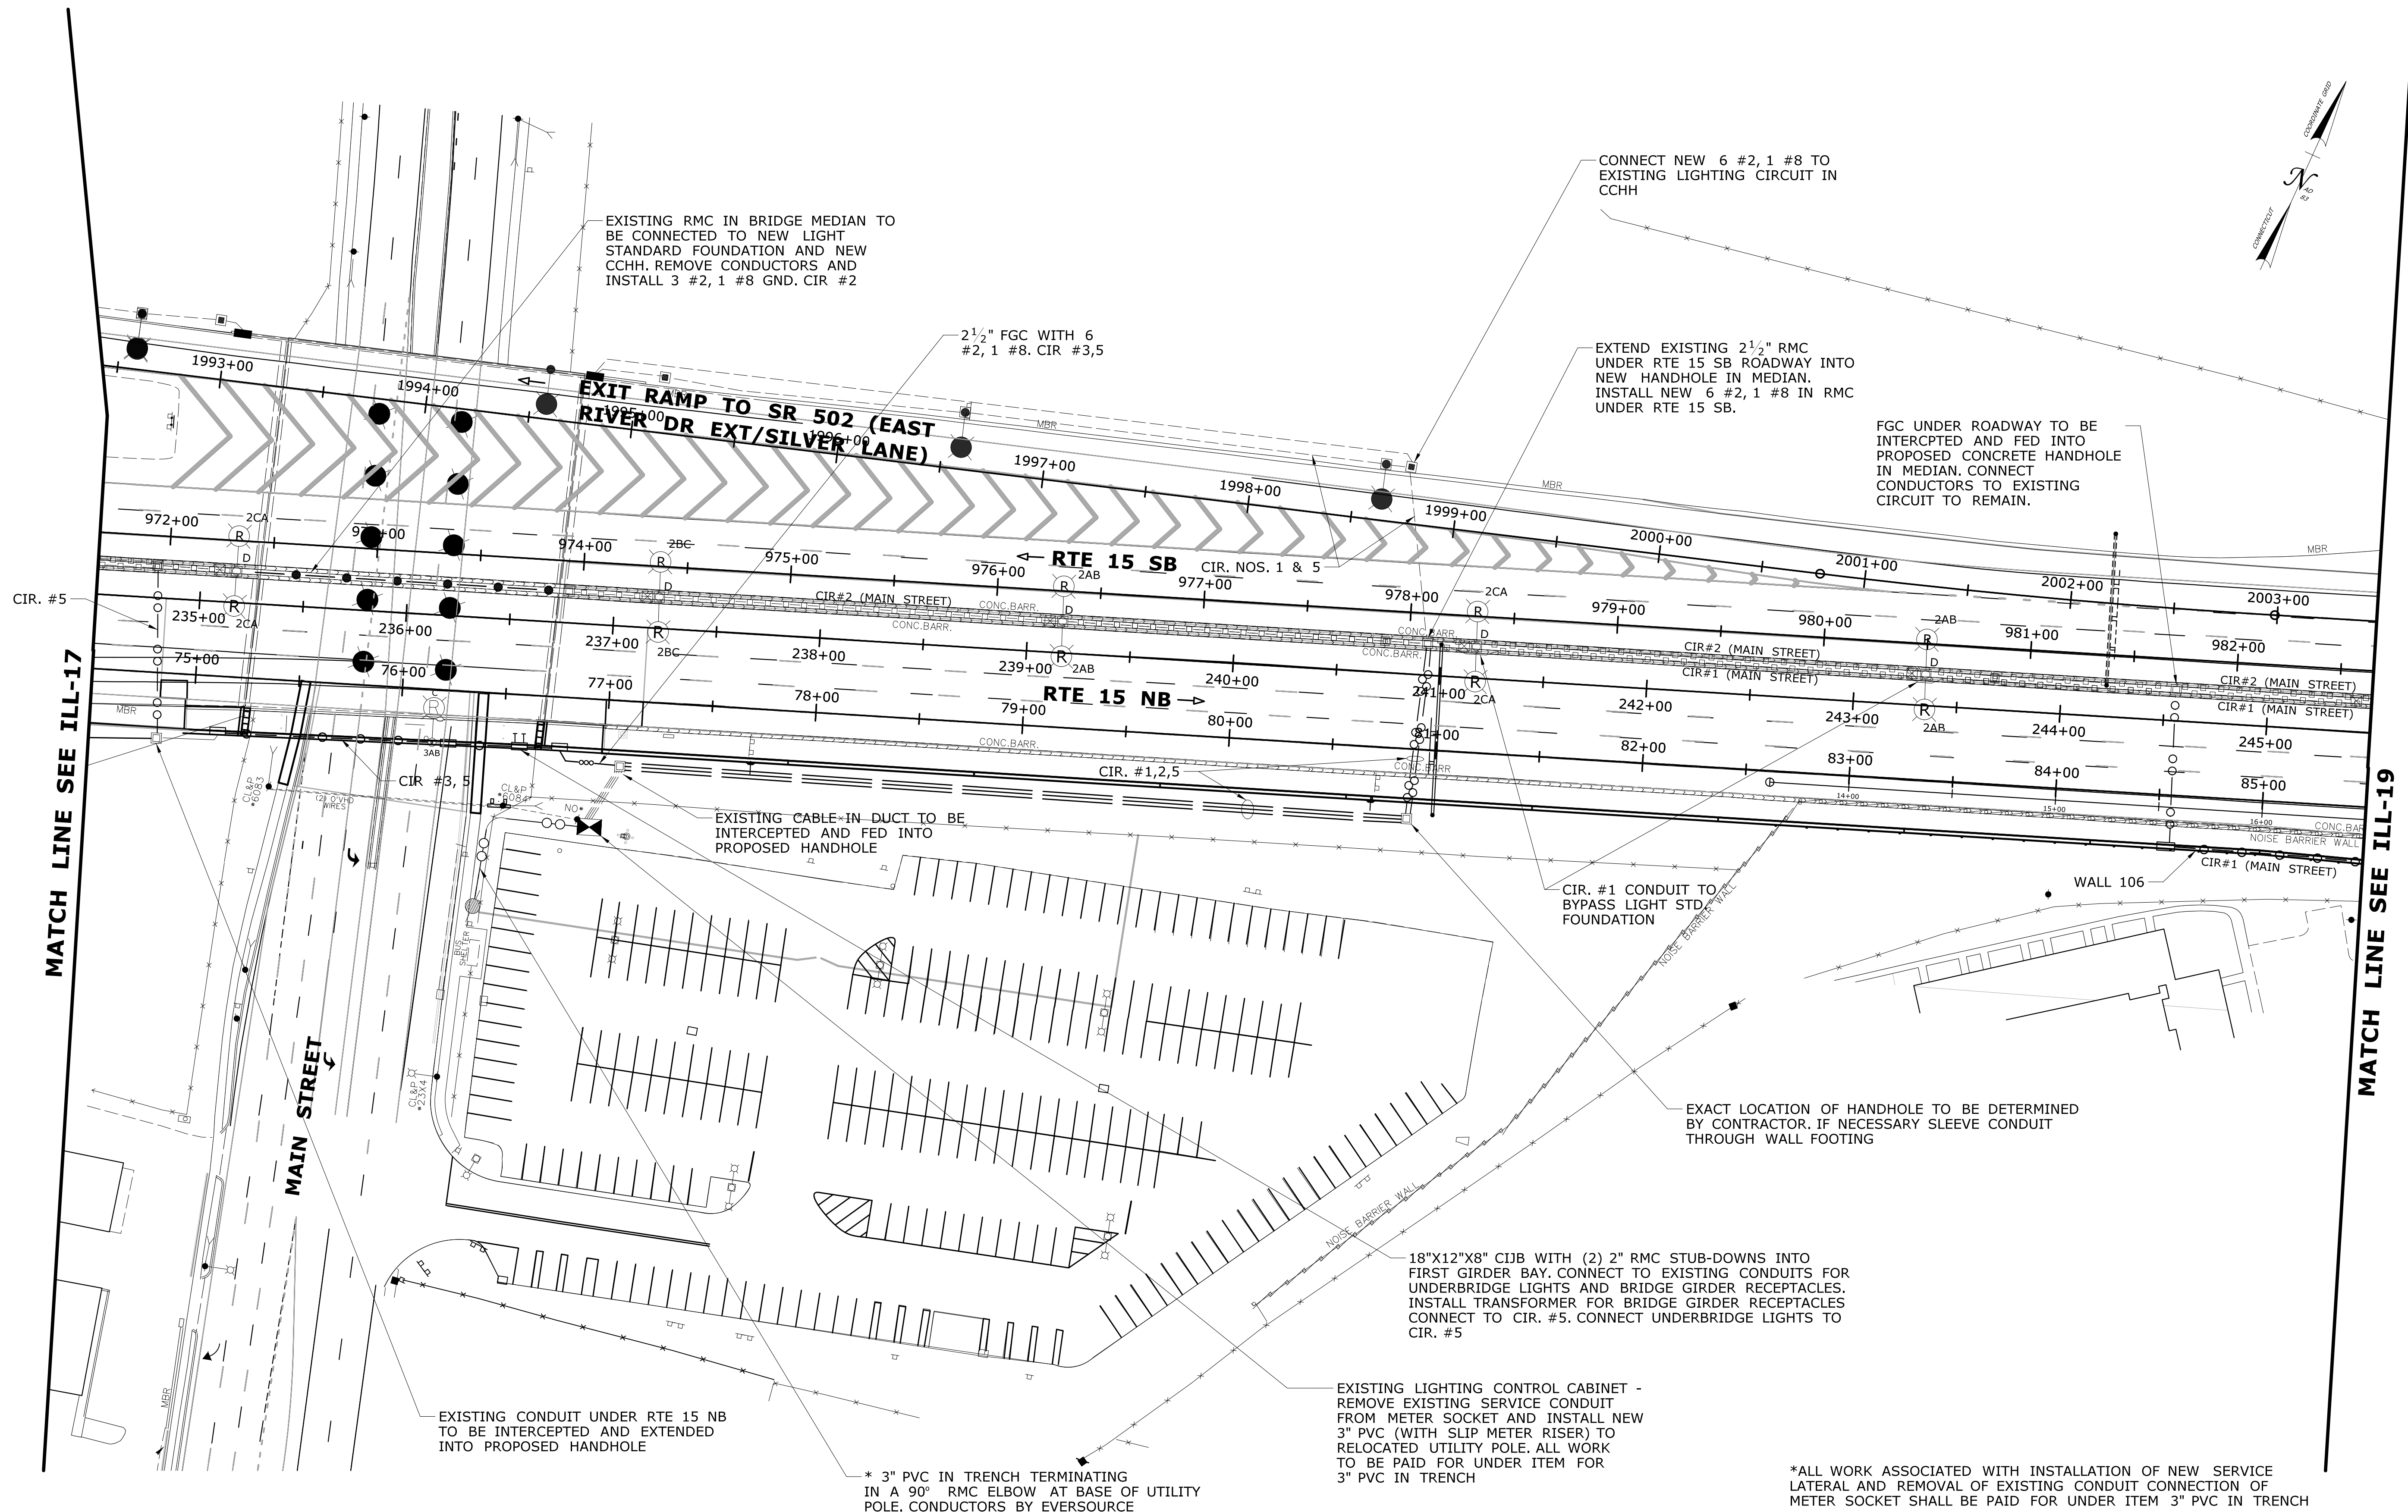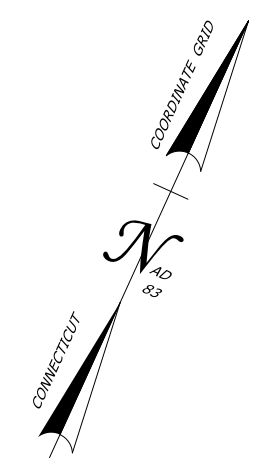

MATCH LINE SEE ILL-17

MATCH LINE SEE ILL-19

EXISTING CONDUIT UNDER RTE 15 NB TO BE INTERCEPTED AND EXTENDED INTO PROPOSED HANDHOLE


\* 3" PVC IN TRENCH TERMINATING IN A 90° RMC ELBOW AT BASE OF UTILITY POLE. CONDUCTORS BY EVERSOURCE

\*ALL WORK ASSOCIATED WITH INSTALLATION OF NEW SERVICE LATERAL AND REMOVAL OF EXISTING CONDUIT CONNECTION OF METER SOCKET SHALL BE PAID FOR UNDER ITEM 3" PVC IN TRENCH

REV. DATE REVISION DESCRIPTION SHEET NO. Plotted Date: 4/26/2018	DESIGNER/DRAFTER: DDR CHECKED BY: MSB	STATE OF CONNECTICUT DEPARTMENT OF TRANSPORTATION	SIGNATURE/BLOCK: [Signature] OFFICE OF ENGINEERING	PROJECT TITLE: <b>RELOCATION OF I-91 NB INTERCHANGE 29 AND WIDENING OF I-91 NB AND ROUTE 15 NB TO I-84 EB</b>	DRAWN BY: EAST HARTFORD	PROJECT NO.: <b>63-703</b>
	SCALE IN FEET 0 40 80 SCALE 1"=40'		APPROVED BY: [Signature]		DRAWING TITLE: <b>ILLUMINATION PLAN</b>	DRAWING NO.: <b>ILL-18</b> SHEET NO.: 01.11.02.18

MATCH LINE SEE ILL-18

MATCH LINE SEE ILL-20

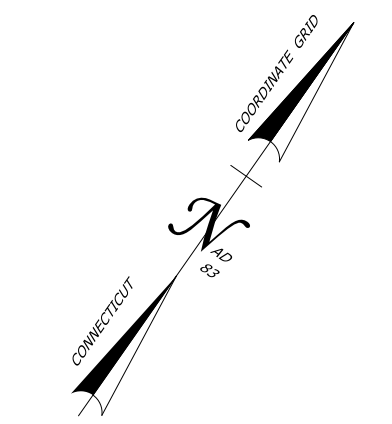

ENTRANCE RAMP  
TO RTE 15 SB

SR 502 (SILVER LANE)

PROPOSED CABLE IN DUCT TO BE FED INTO EXISTING LIGHT STANDARD AND CONNECTED TO EXISTING U.G. CIRCUIT TO REMAIN.

EXTEND EXISTING CONDUIT IN MEDIAN TO NEW LIGHT STANDARD FOUNDATION AND CONNECT TO EXISTING CIRCUIT.


LEAVE COINDUIT EMPTY

END CIR. #2 FROM MAIN STREET LIGHTING CABINET

CIR. #1 CONDUIT TO BYPASS LIGHT STD. FOUNDATION

END OF CIR. #1 FROM CLEMENT ROAD LIGHTING CABINET



PROPOSED CABLE IN DUCT TO BE FED INTO EXISTING LIGHT STANDARD AND CONNECT TO EXISTING U.G. CIRCUIT.

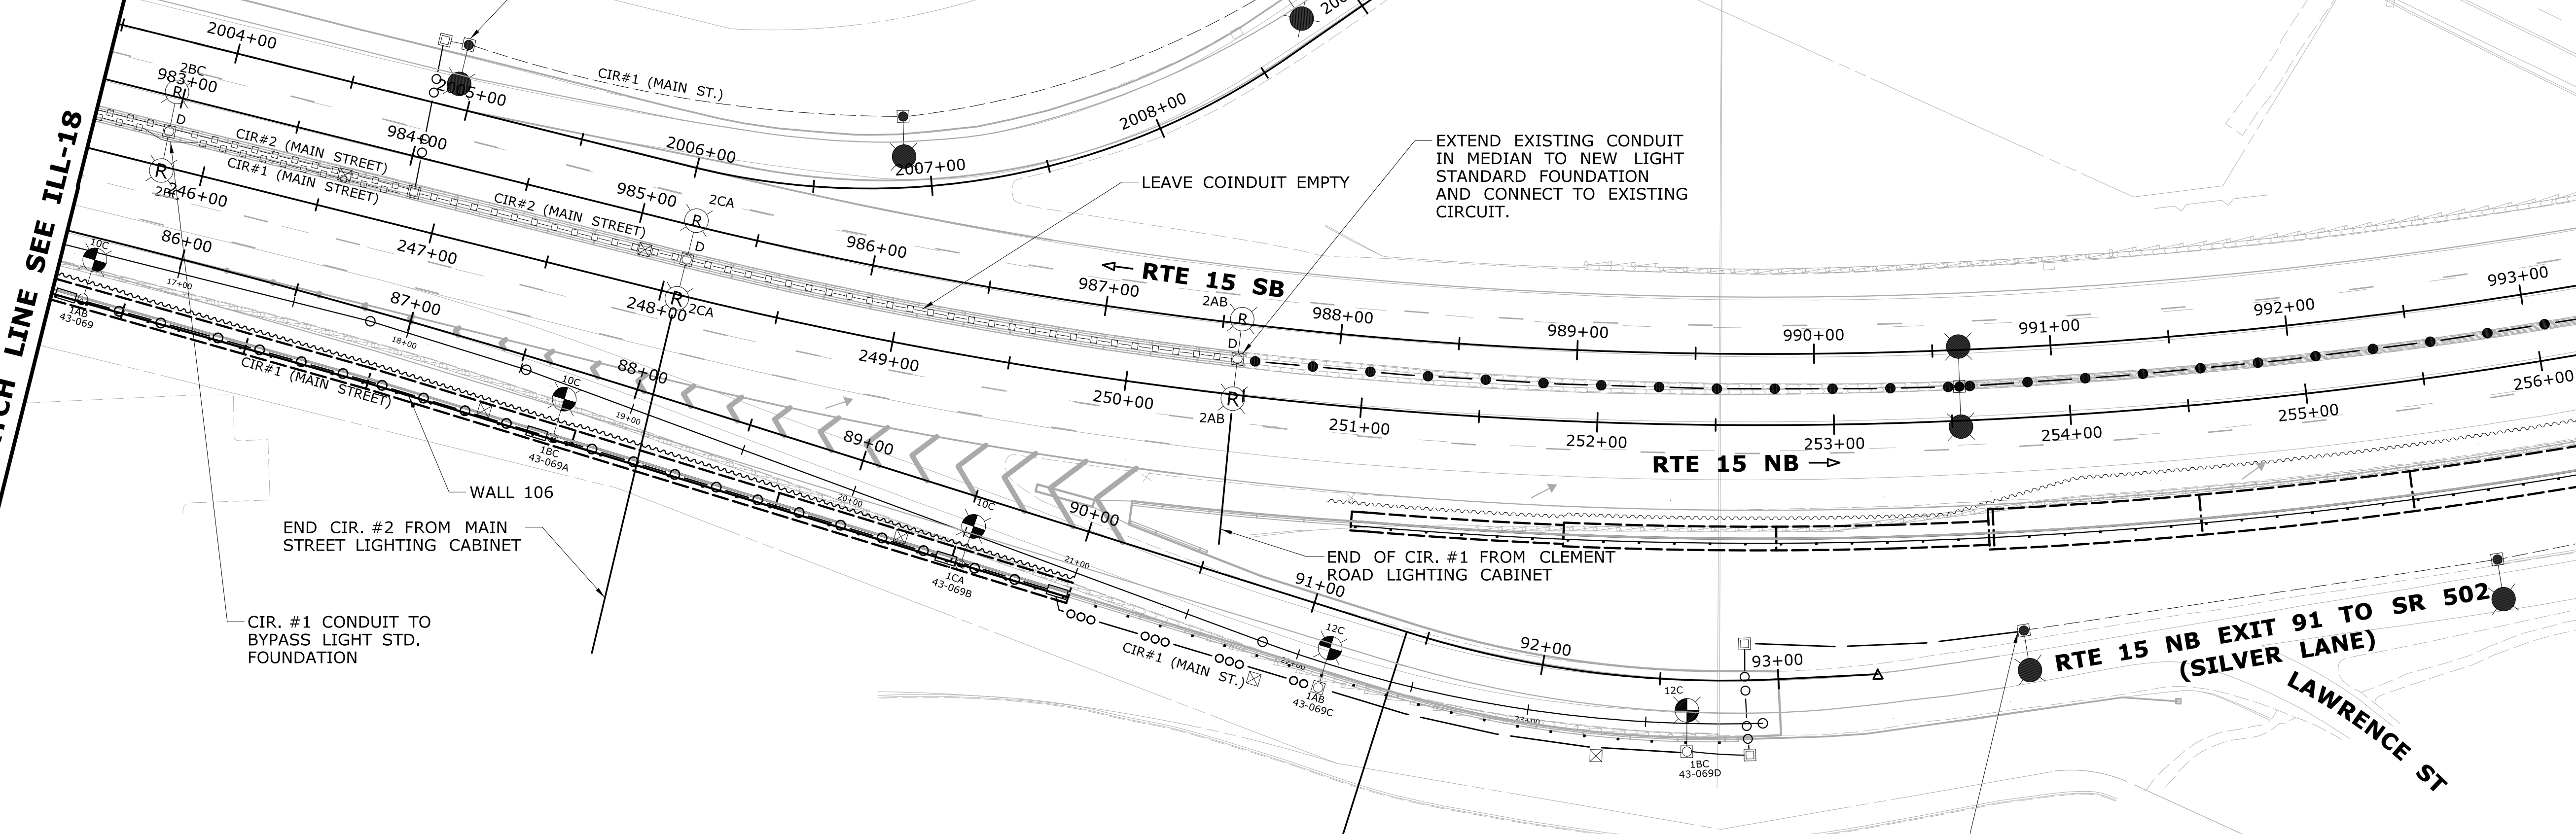

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CHECKED BY: MSB	SCALE IN FEET 0 40 80 SCALE 1"=40'	FILENAME: ...VHW_MSH_0063_0703_04-07_ILL-19.dgn		DRAWING TITLE: <b>ILLUMINATION PLAN</b>	DRAWING NO. <b>ILL-19</b>	SHEET NO. 01.11.02.19	

REV.	DATE	REVISION DESCRIPTION	SHEET NO.

Plotted Date: 4/16/2018

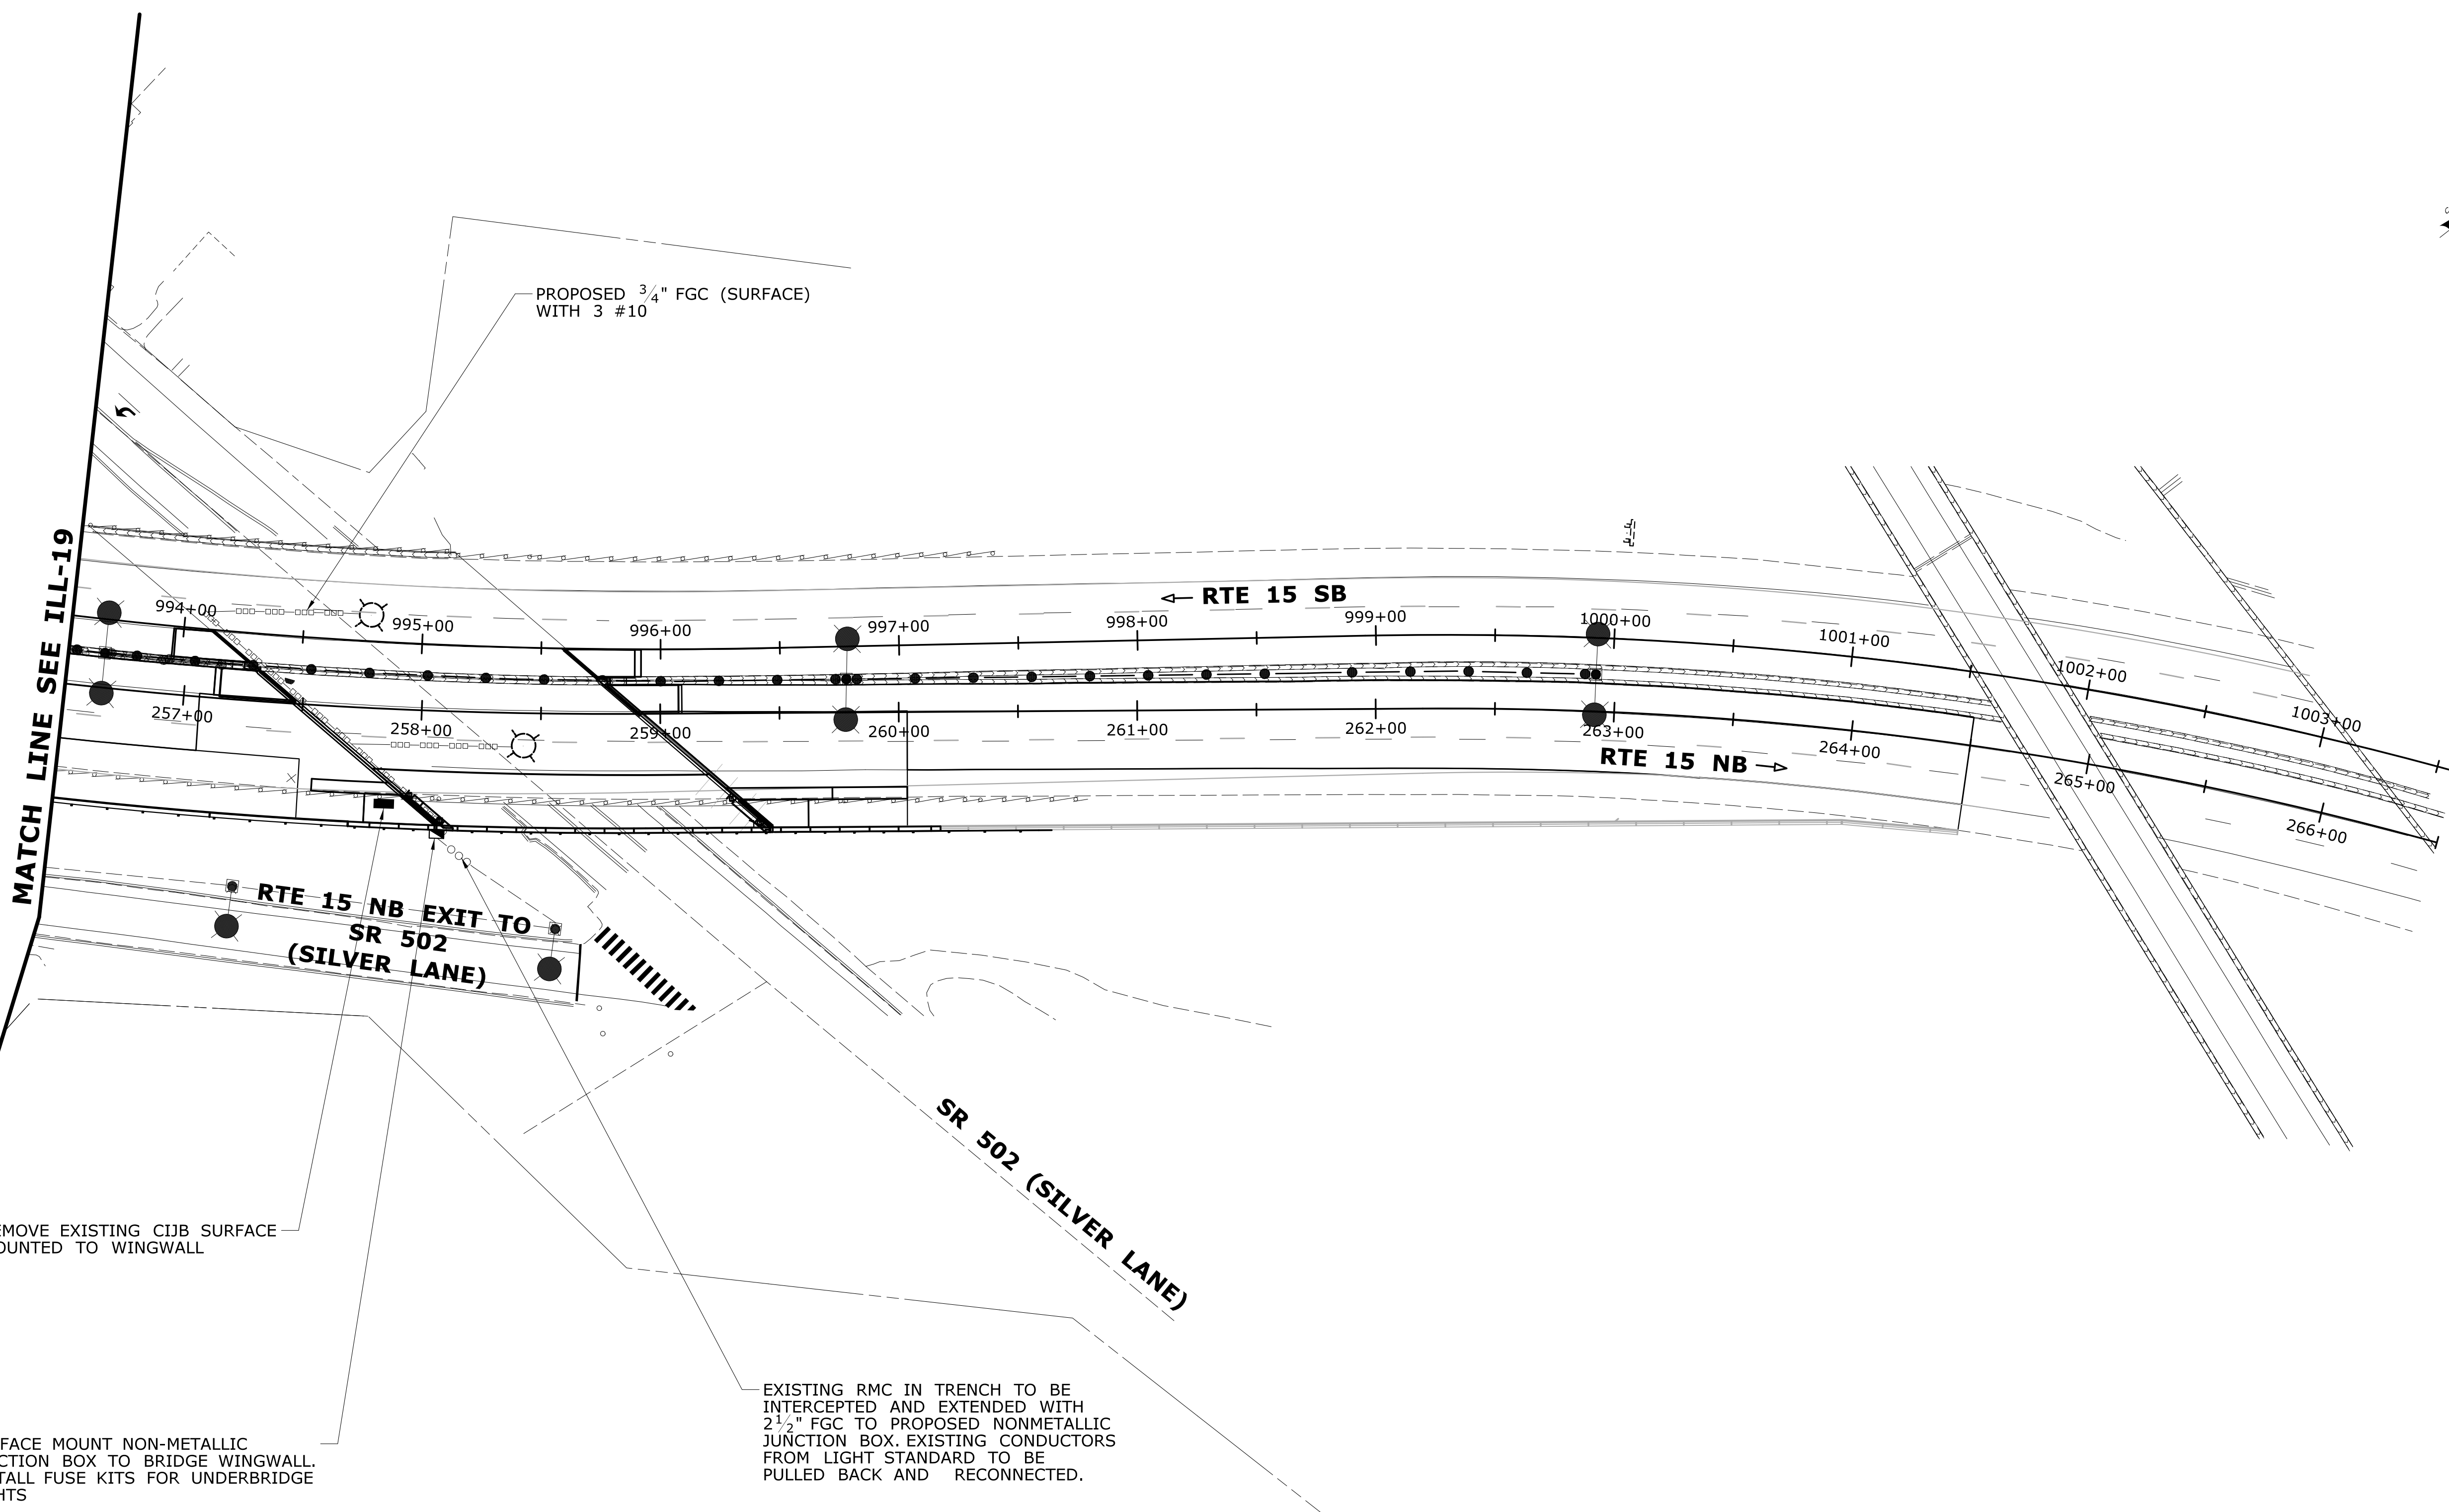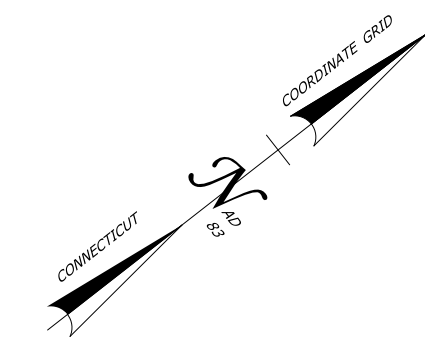


REV.	DATE	REVISION DESCRIPTION	SHEET NO.

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Plotted Date: 5/14/2018

DESIGNER/DRAFTER: DDR  
 CHECKED BY: MSB  
 SCALE IN FEET  
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 SCALE 1"=40'

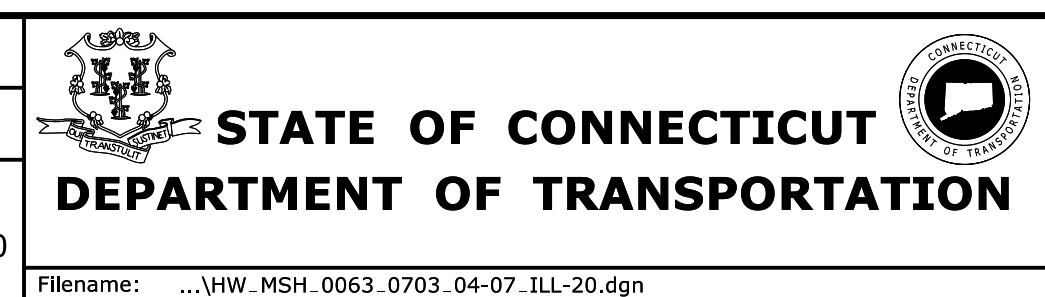


SIGNATURE/BLOCK:  
 OFFICE OF ENGINEERING  
 APPROVED BY: *Chapman*

PROJECT TITLE:  
**RELOCATION OF I-91 NB INTERCHANGE 29 AND WIDENING OF I-91 NB AND ROUTE 15 NB TO I-84 EB**


EDR/REOWN: EAST HARTFORD  
 DRAWING TITLE: **ILLUMINATION PLAN**

PROJECT NO. **63-703**  
 DRAWING NO. **ILL-20**  
 SHEET NO. 01.11.02.20

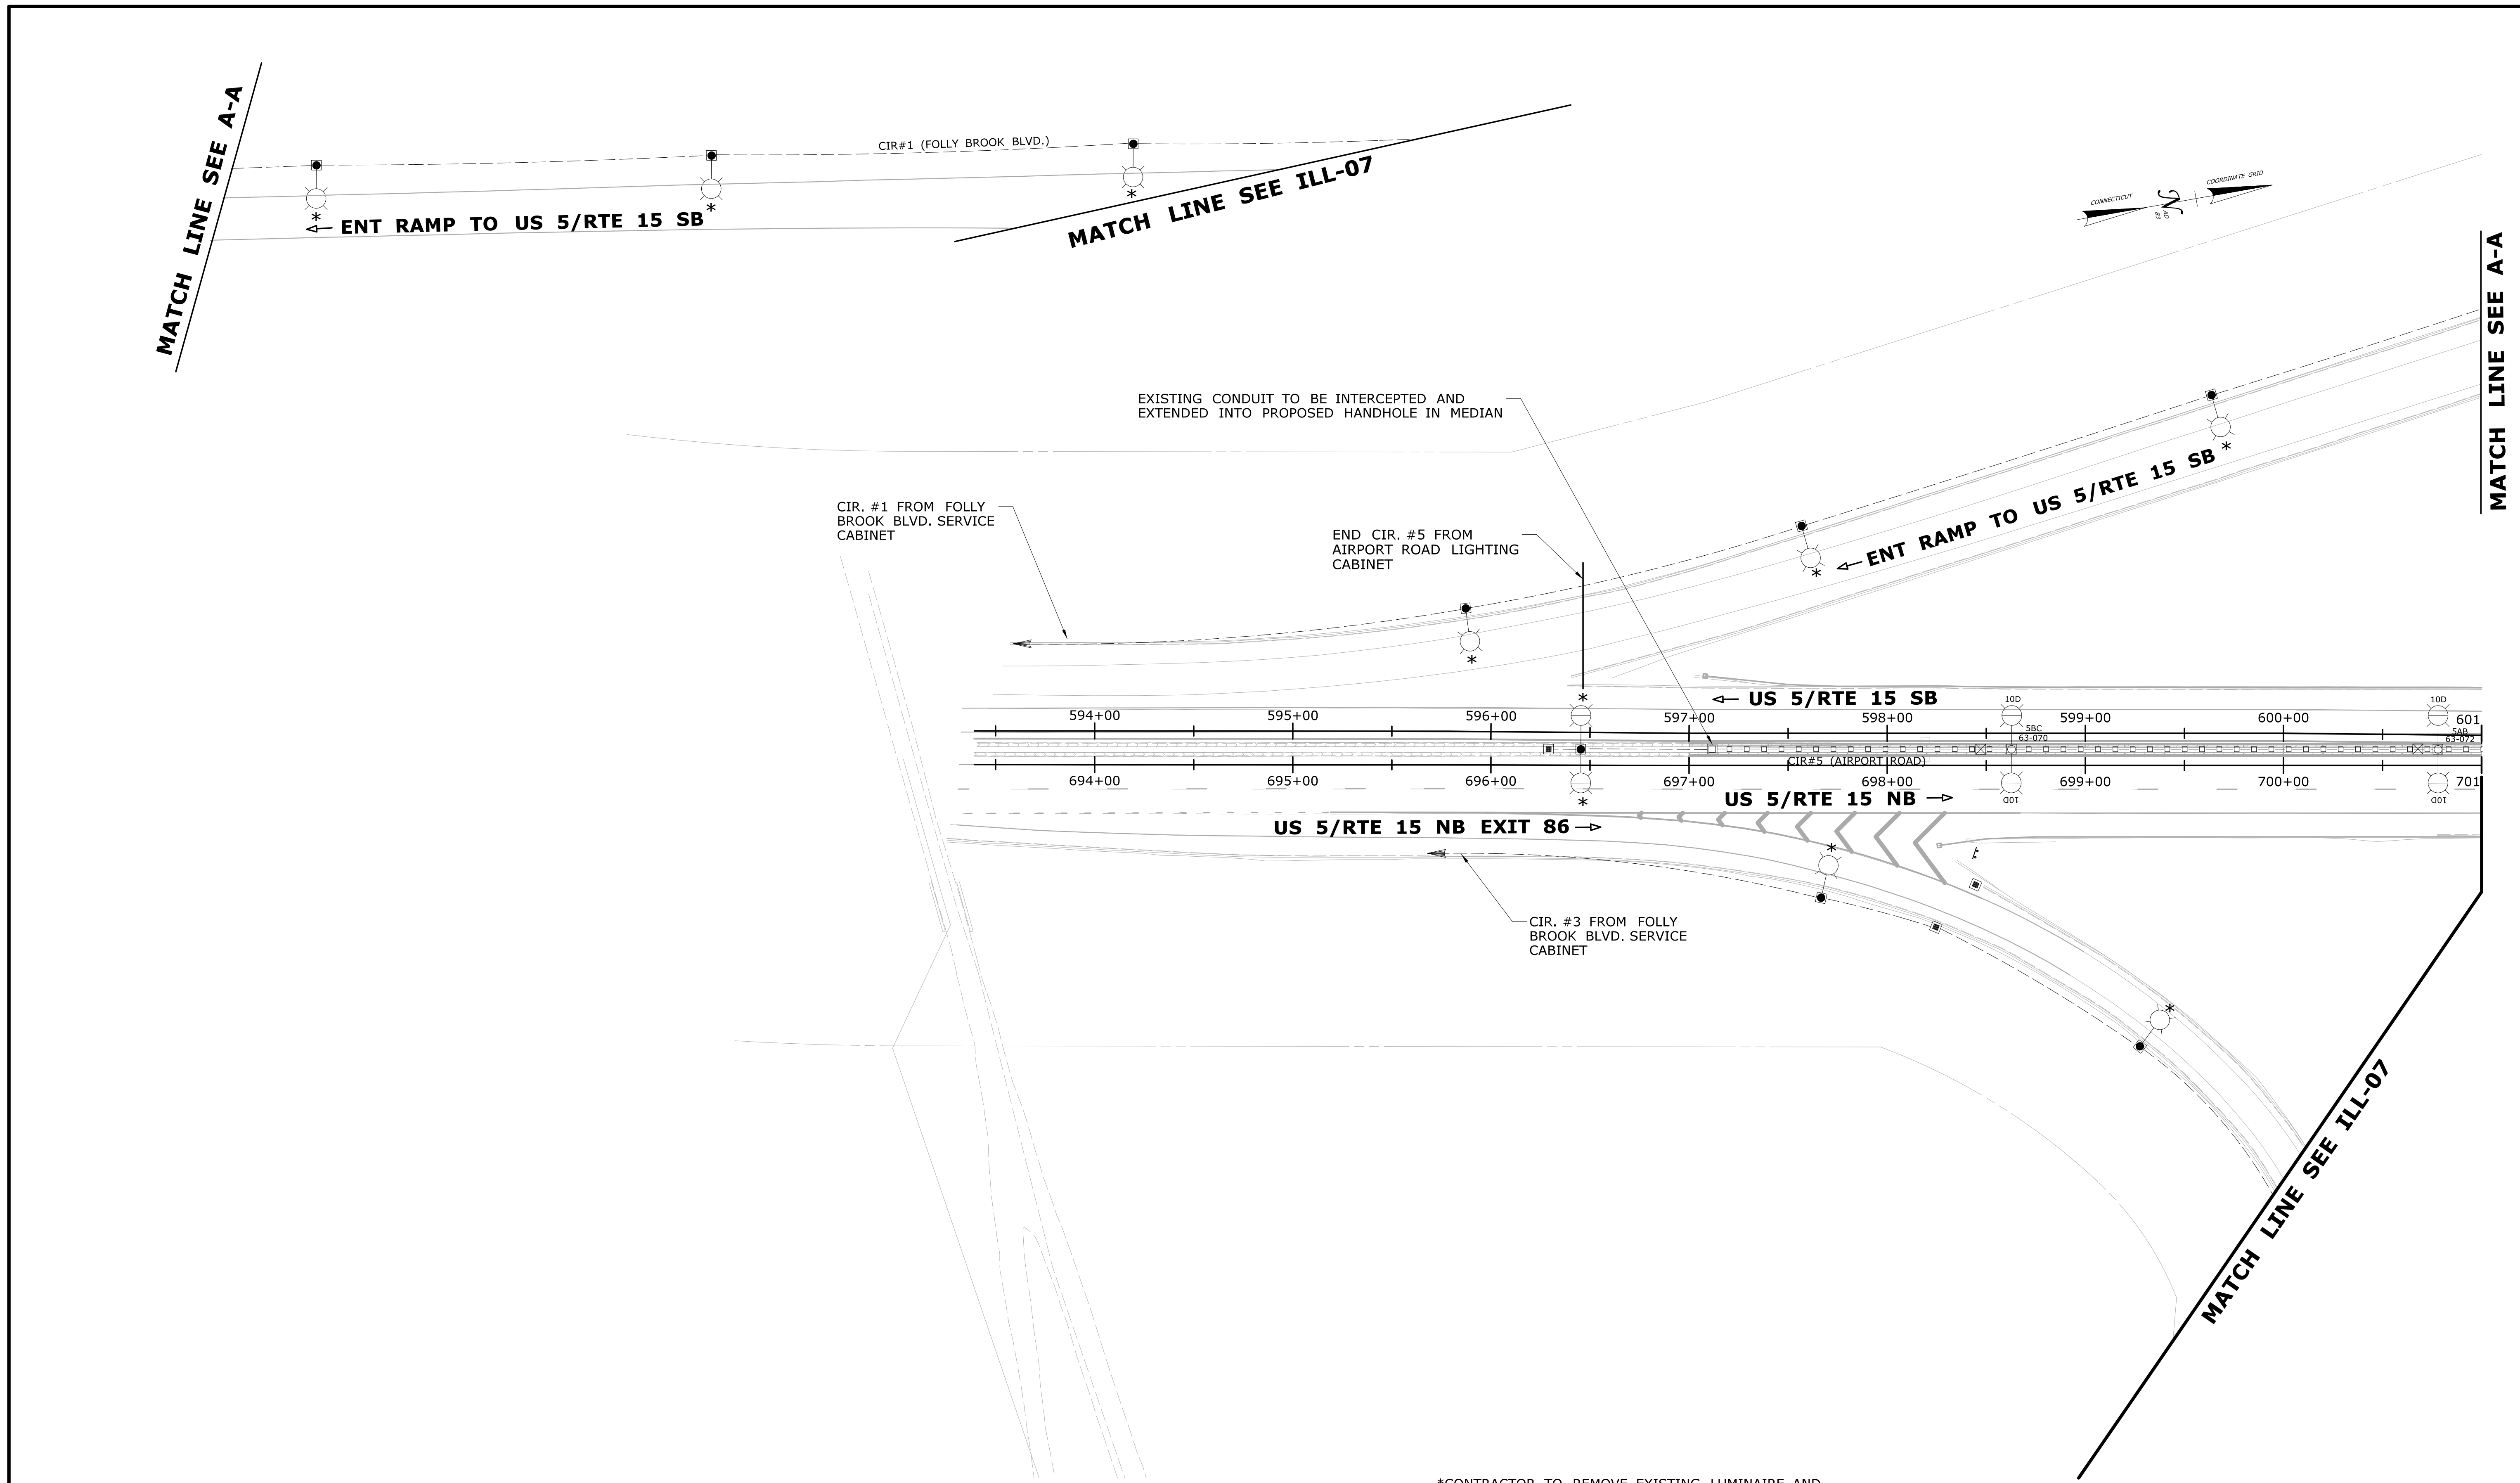


\*CONTRACTOR TO REMOVE EXISTING LUMINAIRE AND INSTALL LED LUMINAIRE ONLY. ALL ELSE TO REMAIN

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CHECKED BY: <b>MSB</b>		SCALE IN FEET SCALE 1"=40'					
REV.	DATE	REVISION DESCRIPTION	SHEET NO.	Plotted Date: 3/9/2018	Filename: ...VHW_MSH_0063_0703_04-07_ILL-21.dgn		

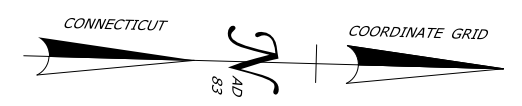

END OF CIR. #1 FROM AIRPORT ROAD SERVICE

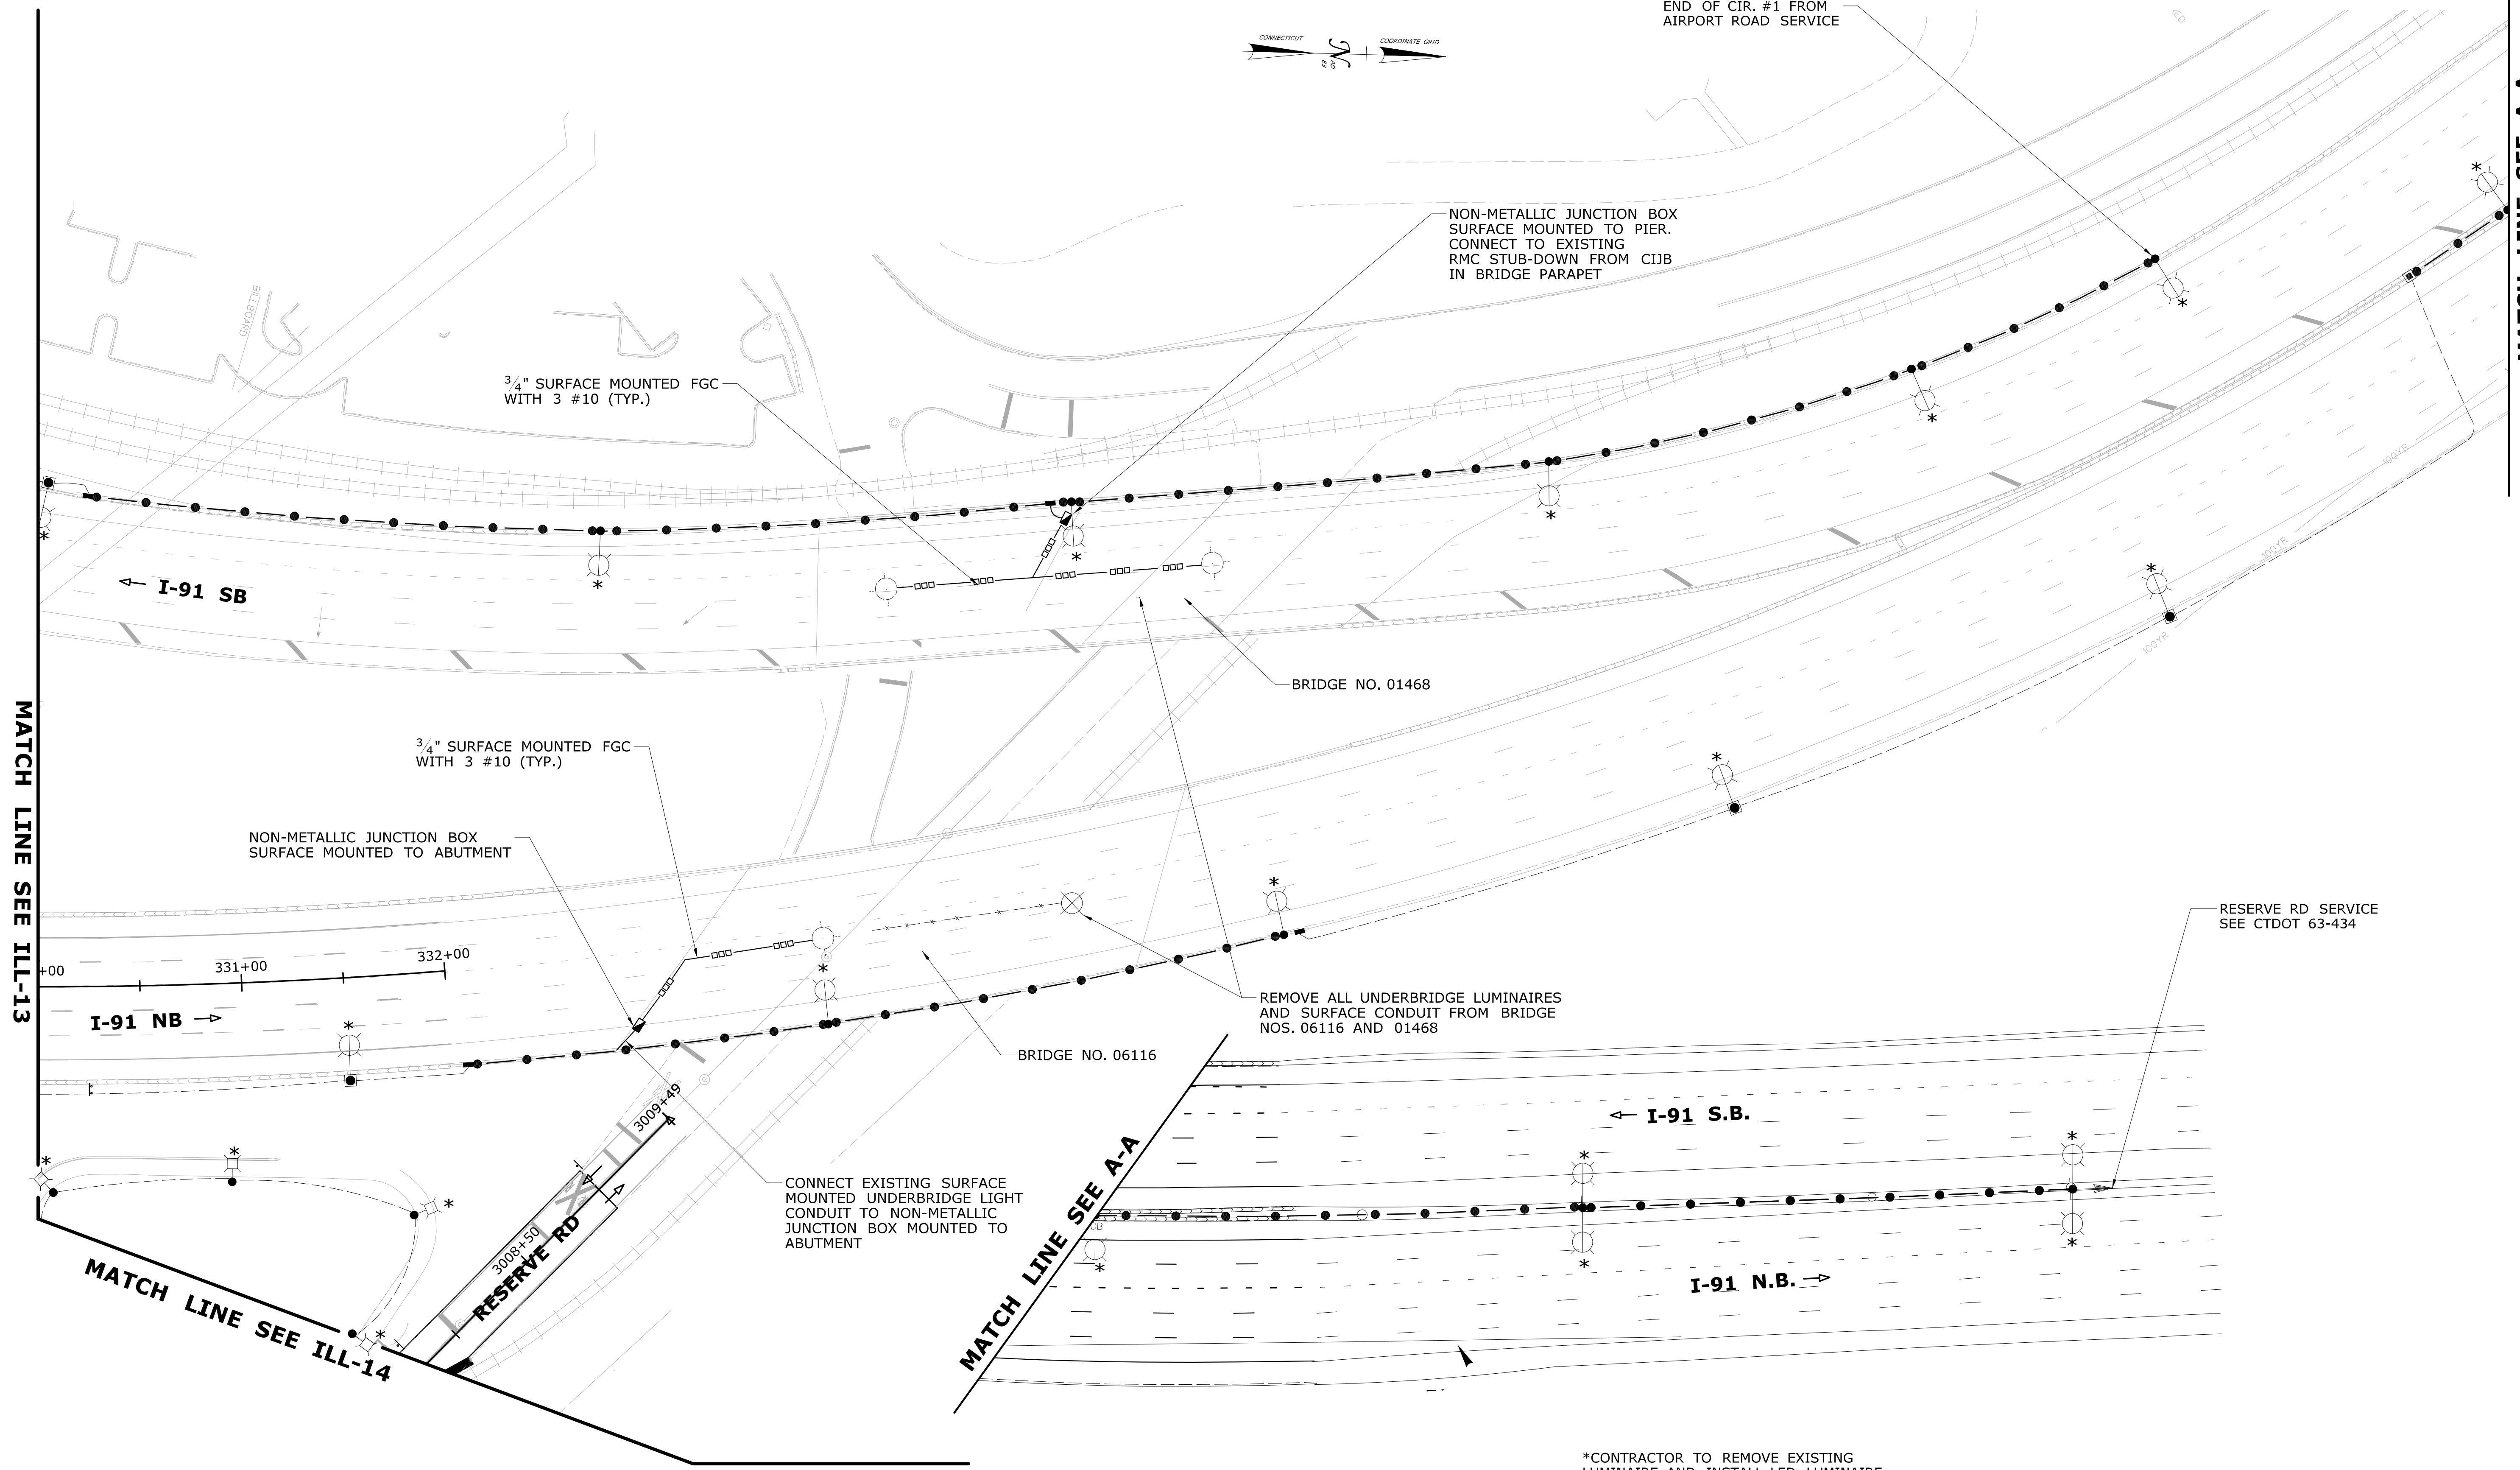

MATCH LINE SEE ILL-13


MATCH LINE SEE A-A

MATCH LINE SEE A-A

\*CONTRACTOR TO REMOVE EXISTING LUMINAIRE AND INSTALL LED LUMINAIRE ONLY. ALL ELSE TO REMAIN

REV.	DATE	REVISION DESCRIPTION	SHEET NO.	Plotted Date: 5/14/2018

DESIGNER/DRAFTER:  
DDR  
CHECKED BY:  
MSB  
SCALE IN FEET  
0 40 80  
SCALE 1"=40'

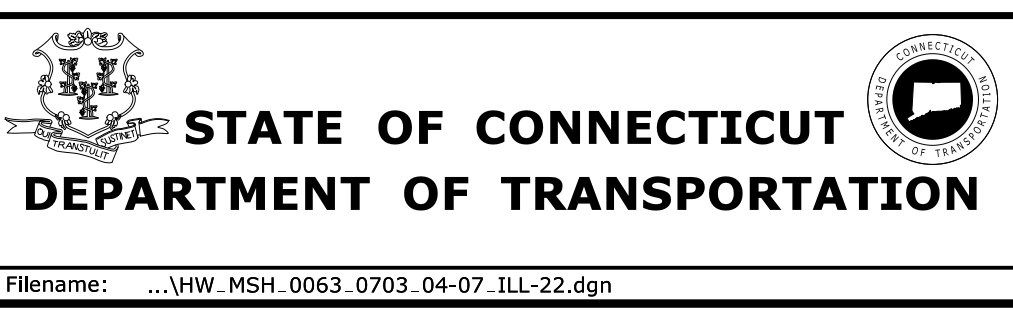

SIGNATURE/  
BLOCK:  
*Clayton*

PROJECT TITLE:  
**RELOCATION OF I-91 NB INTERCHANGE 29 AND WIDENING OF I-91 NB AND ROUTE 15 NB TO I-84 EB**


EDR/REOWN:  
**HARTFORD EAST HARTFORD**  
DRAWING TITLE:  
**ILLUMINATION PLAN**

PROJECT NO.  
**63-703**  
DRAWING NO.  
**ILL-22**  
SHEET NO.  
01.11.02.22

MATCH LINE SEE ILL-09

MATCH LINE SEE ILL-08

MATCH LINE SEE ILL-24

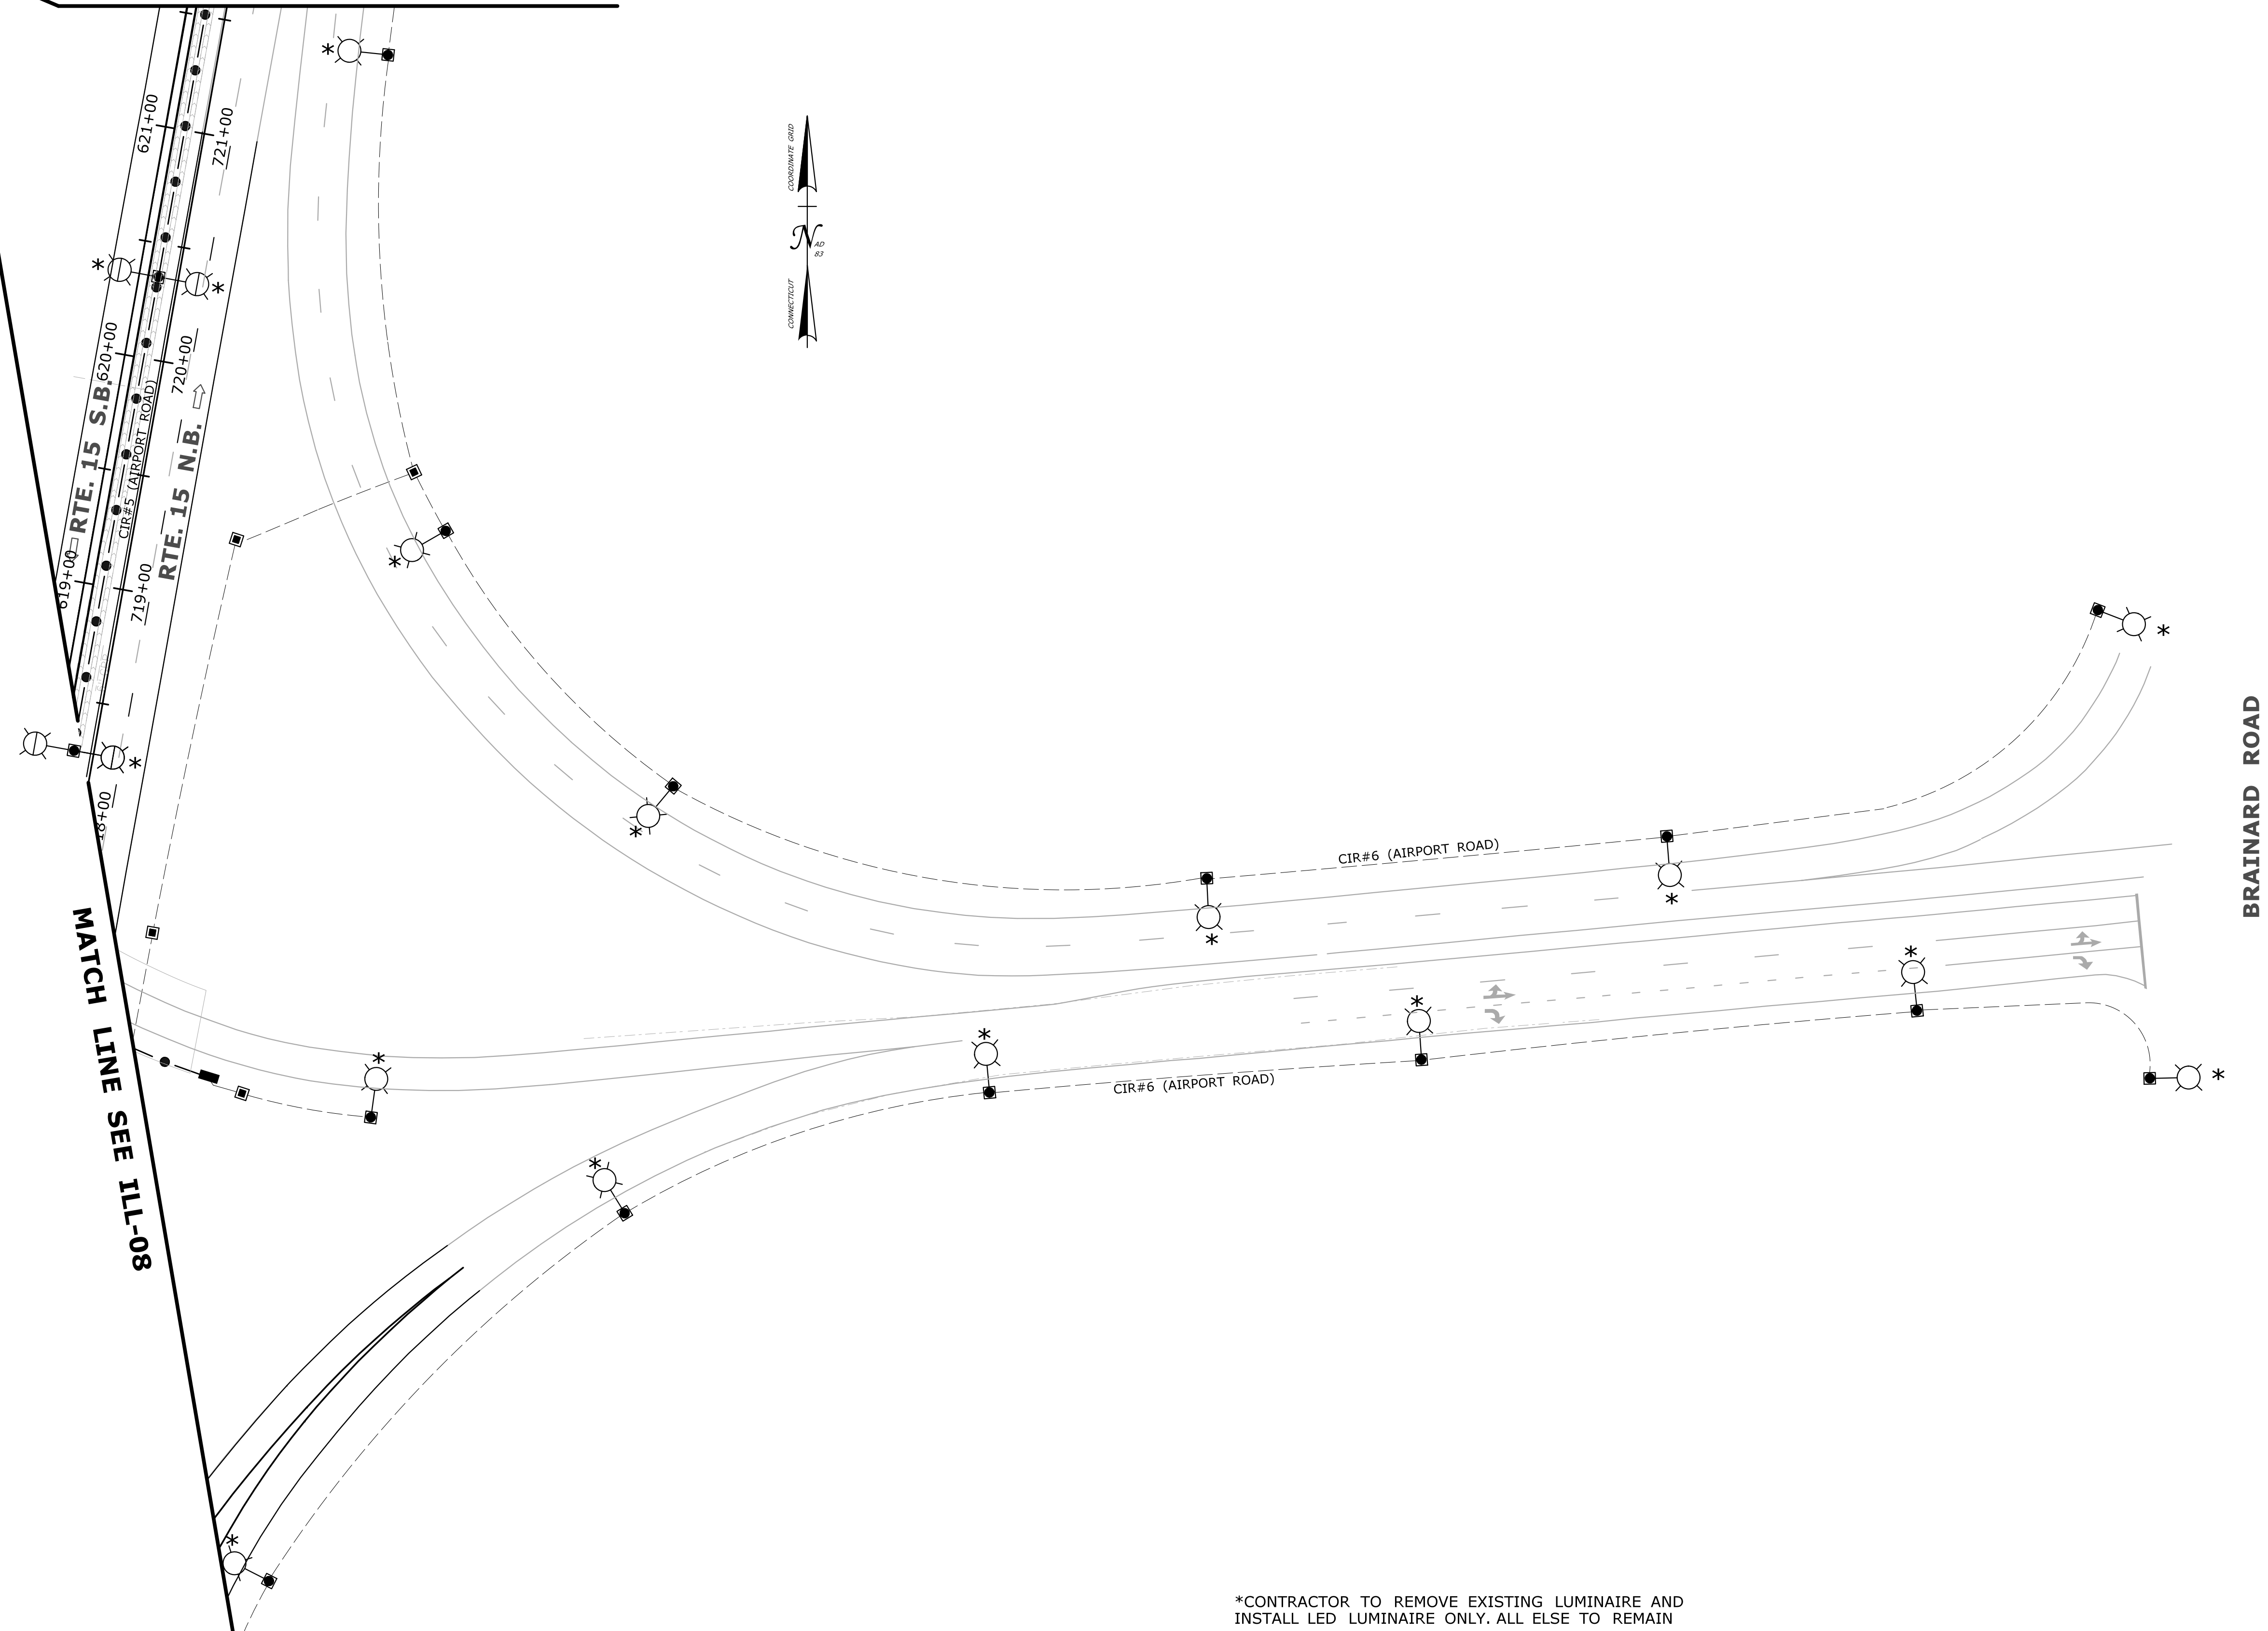

BRAINARD ROAD


\*CONTRACTOR TO REMOVE EXISTING LUMINAIRE AND INSTALL LED LUMINAIRE ONLY. ALL ELSE TO REMAIN

REV.	DATE	REVISION DESCRIPTION	SHEET NO.

THE INFORMATION, INCLUDING ESTIMATED QUANTITIES OF WORK, SHOWN ON THESE SHEETS IS BASED ON LIMITED INVESTIGATIONS BY THE STATE AND IS IN NO WAY WARRANTED TO INDICATE THE CONDITIONS OF ACTUAL QUANTITIES OF WORK WHICH WILL BE REQUIRED.

Plotted Date: 3/9/2018

DESIGNER/DRAFTER: DDR  
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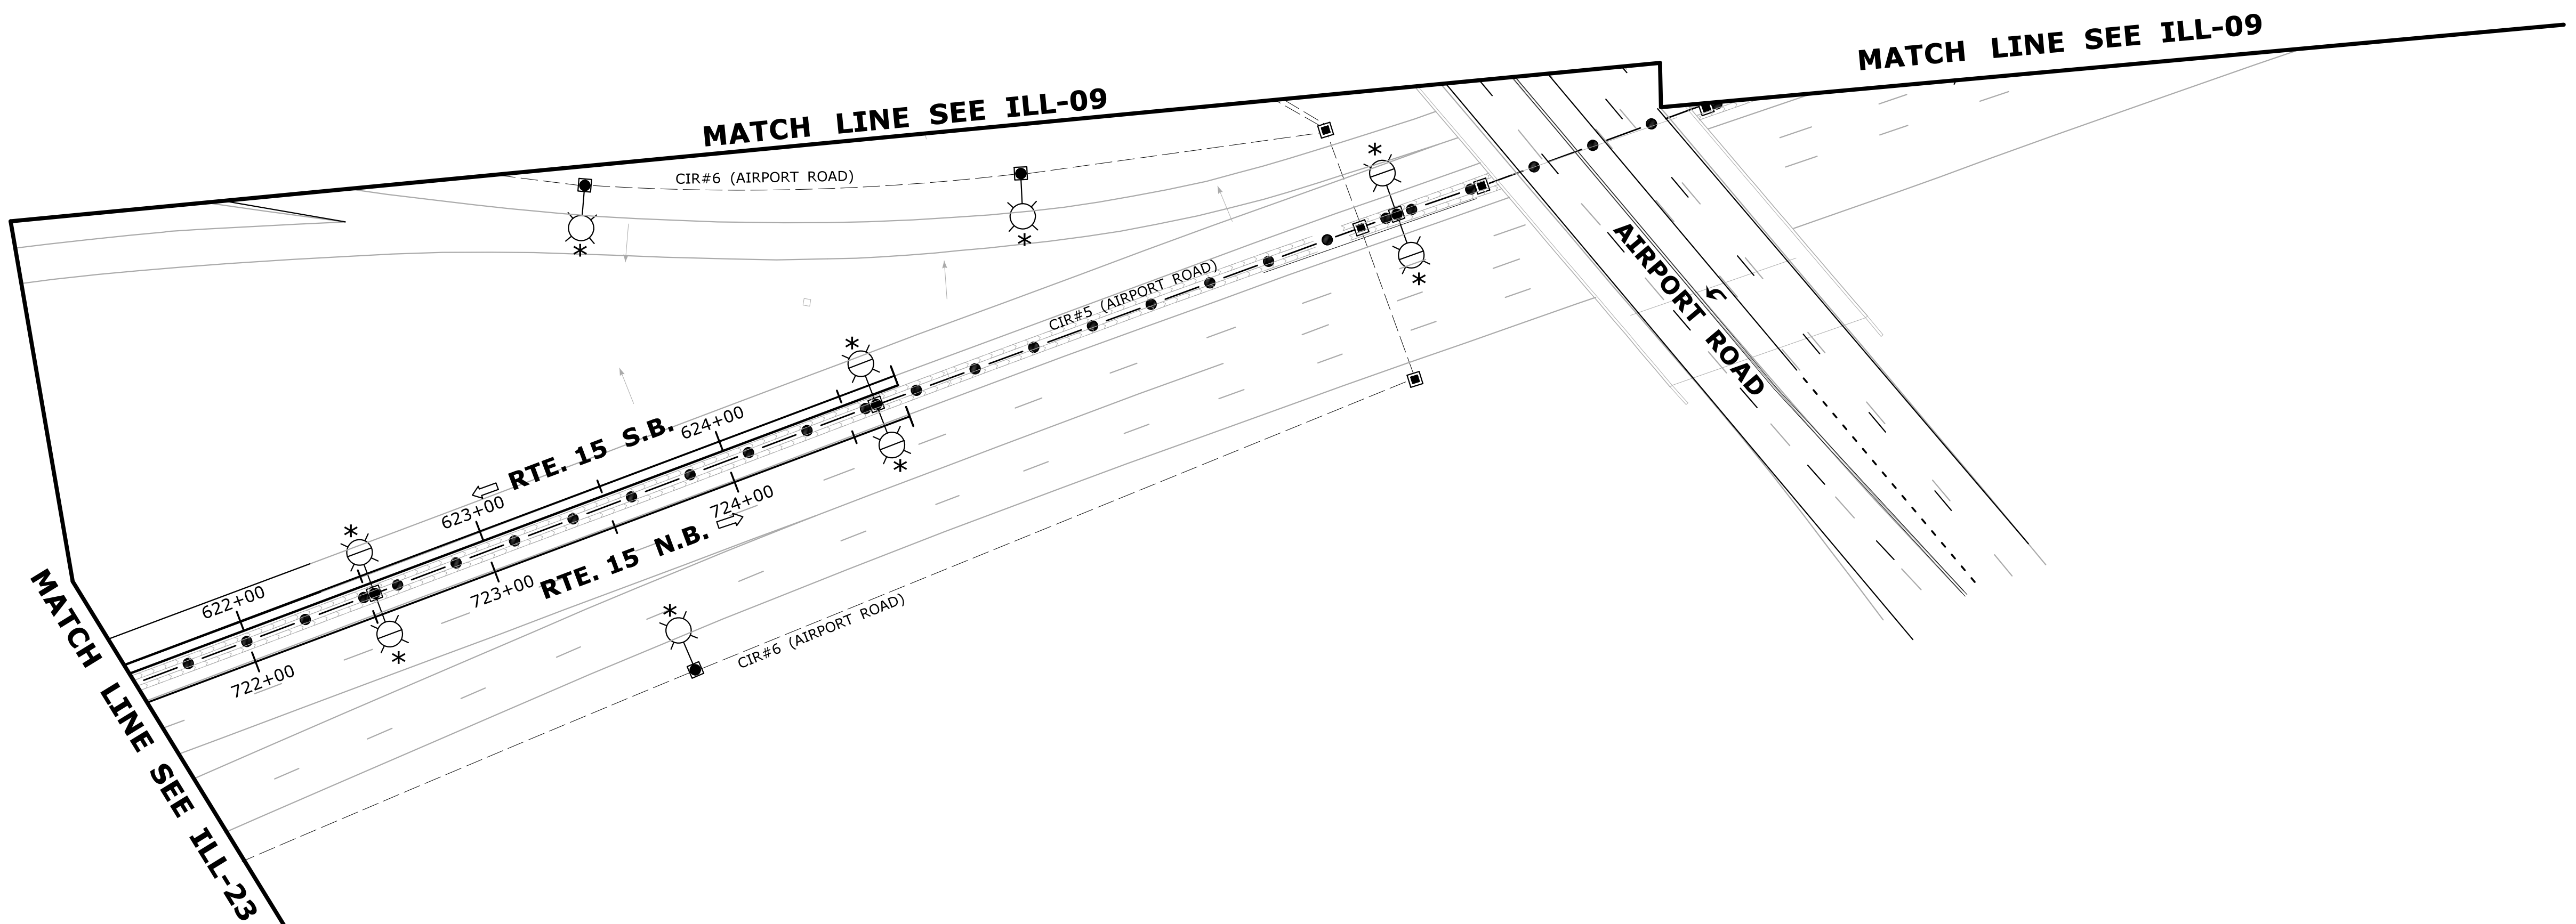
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 BLOCK:

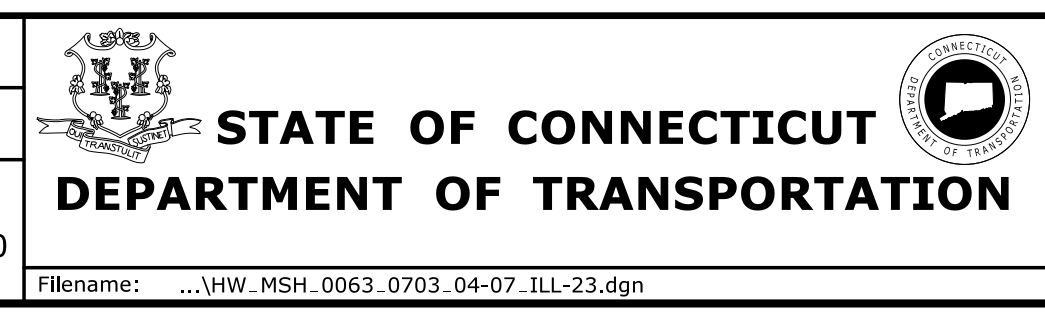PROJECT TITLE:  
**RELOCATION OF I-91 NB  
 INTERCHANGE 29 AND WIDENING  
 OF I-91 NB AND ROUTE 5/15 NB  
 TO I-84 EB**

CITY/TOWN: **HARTFORD  
 EAST HARTFORD**  
 DRAWING TITLE: **ILLUMINATION  
 PLAN**

PROJECT NO. **63-703**  
 DRAWING NO. **ILL-23**  
 SHEET NO. **01.11.02.23**





\*CONTRACTOR TO REMOVE EXISTING LUMINAIRE AND INSTALL LED LUMINAIRE ONLY. ALL ELSE TO REMAIN

REV.	DATE	REVISION DESCRIPTION	SHEET NO.

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Plotted Date: 3/9/2018


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BLOCK:

PROJECT TITLE:  
**RELOCATION OF I-91 NB  
INTERCHANGE 29 AND WIDENING  
OF I-91 NB AND ROUTE 5/15 NB  
TO I-84 EB**



CITY/TOWN:  
**HARTFORD  
EAST HARTFORD**

DRAWING TITLE:  
**ILLUMINATION  
PLAN**


PROJECT NO.  
**63-703**

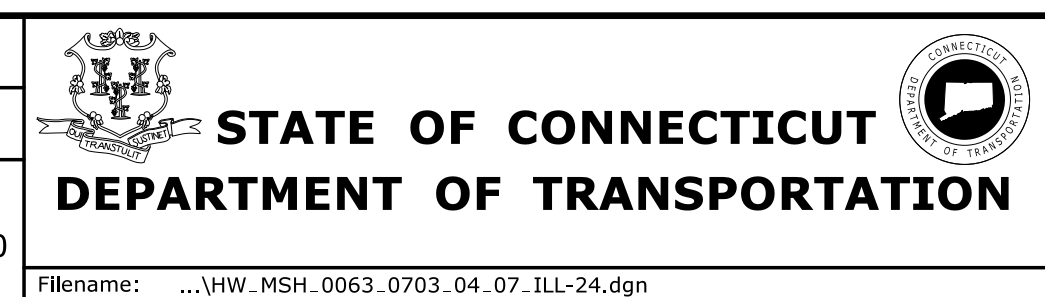DRAWING NO.  
**ILL-24**

SHEET NO.  
01.11.02.24

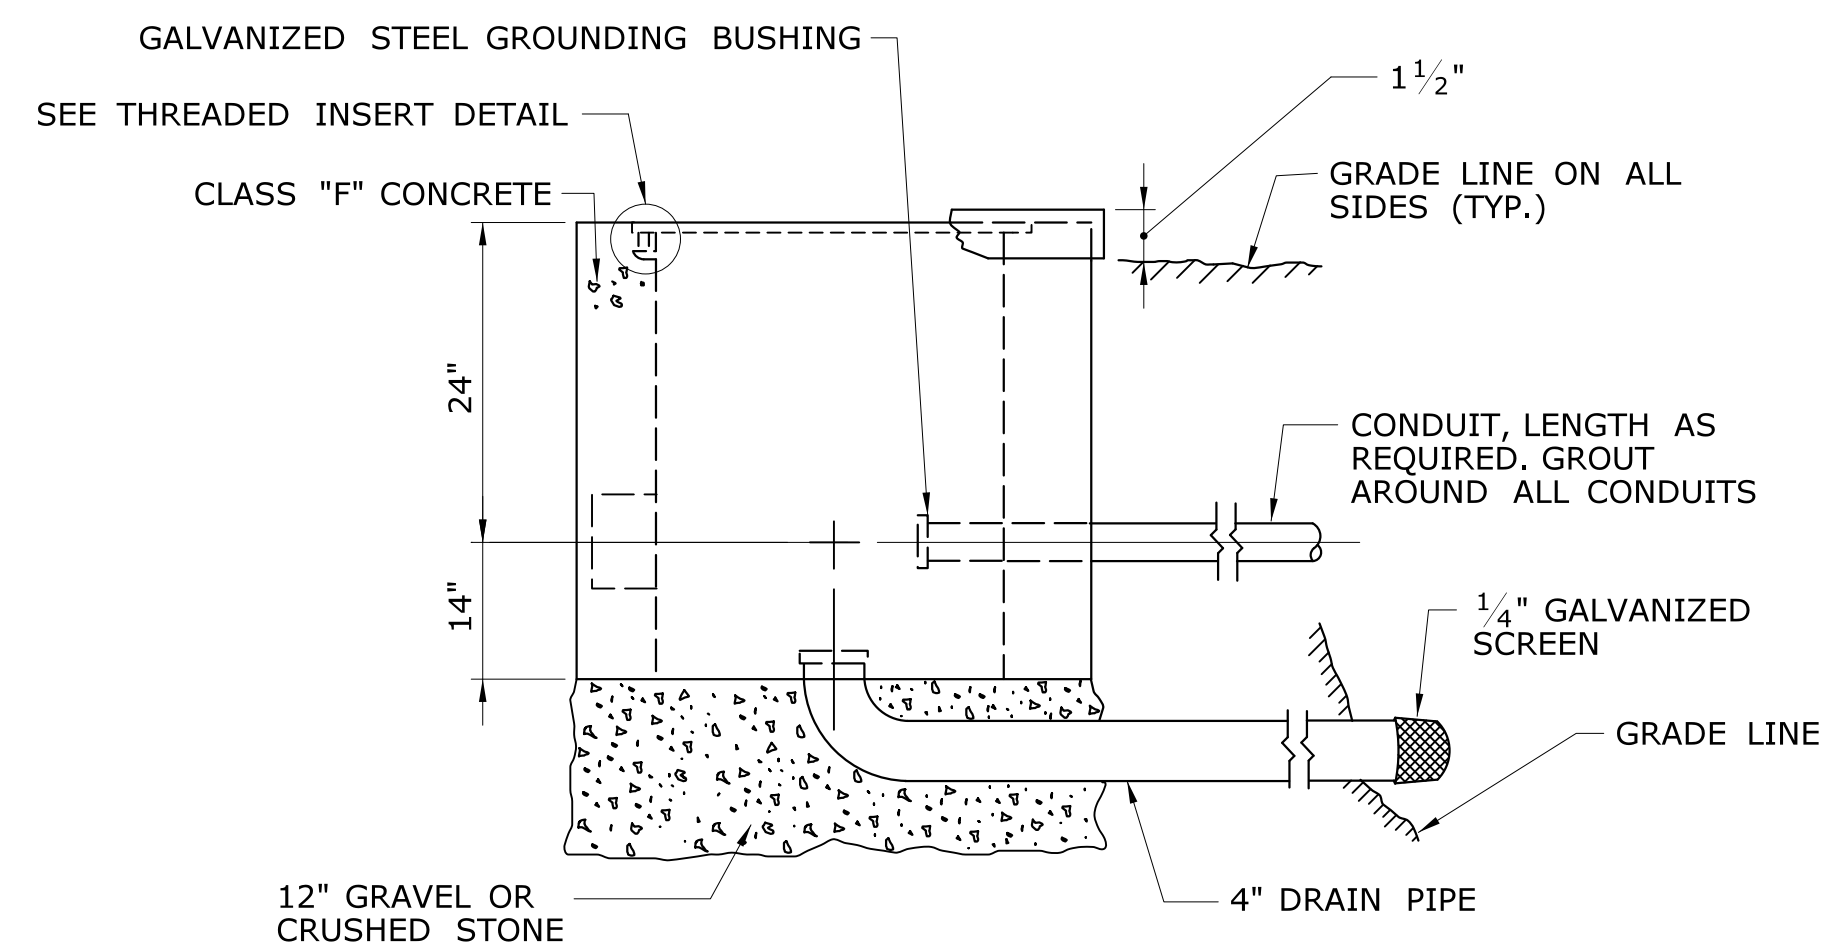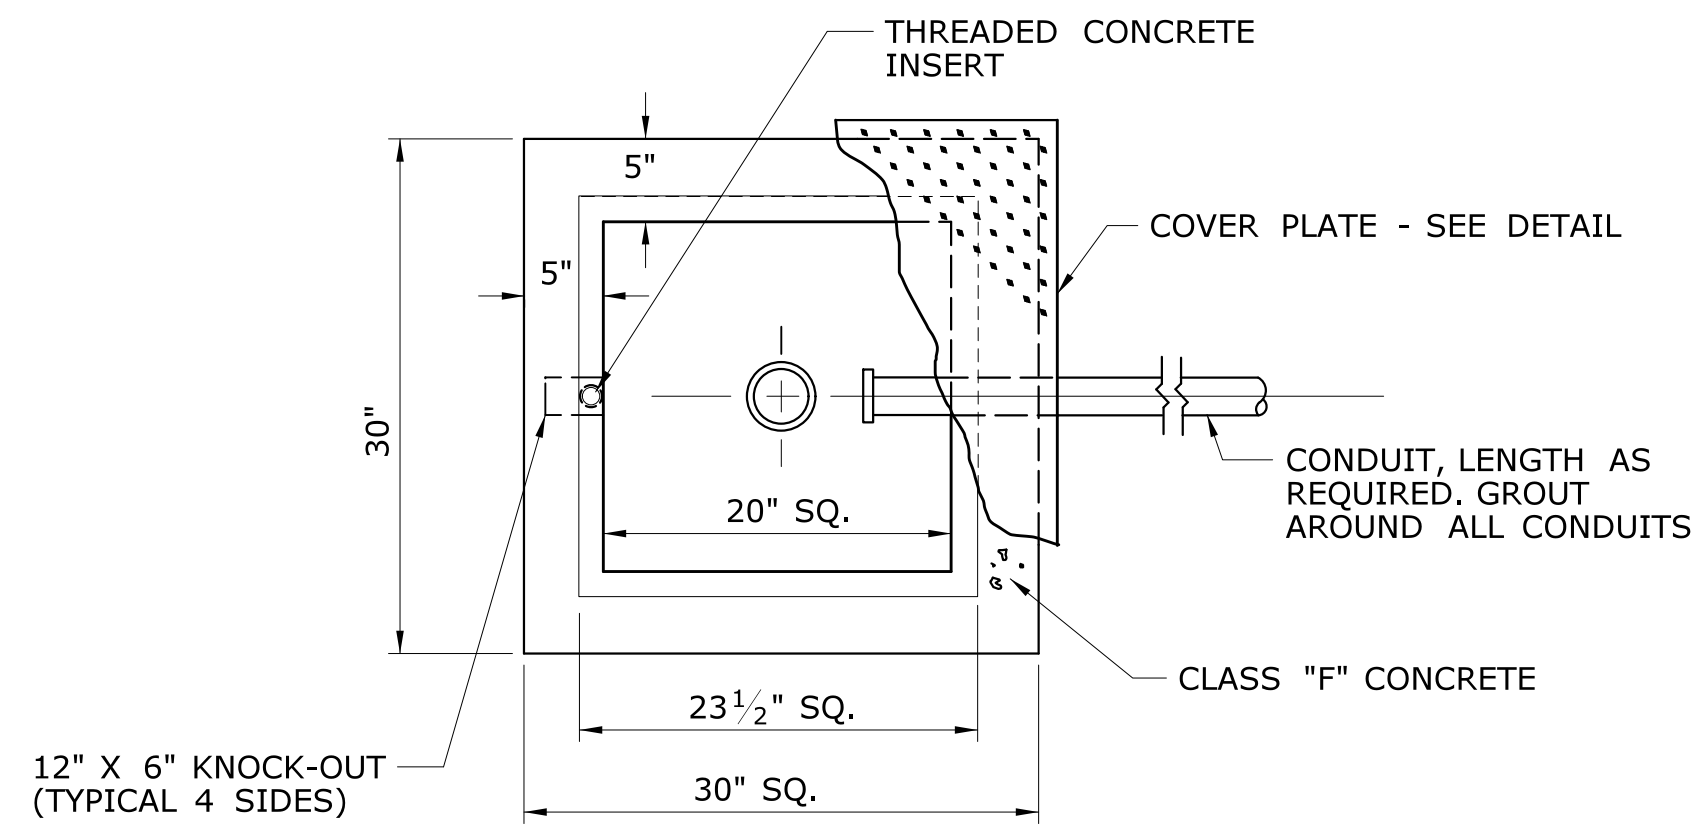

**CONCRETE HANDHOLE - TYPE I**

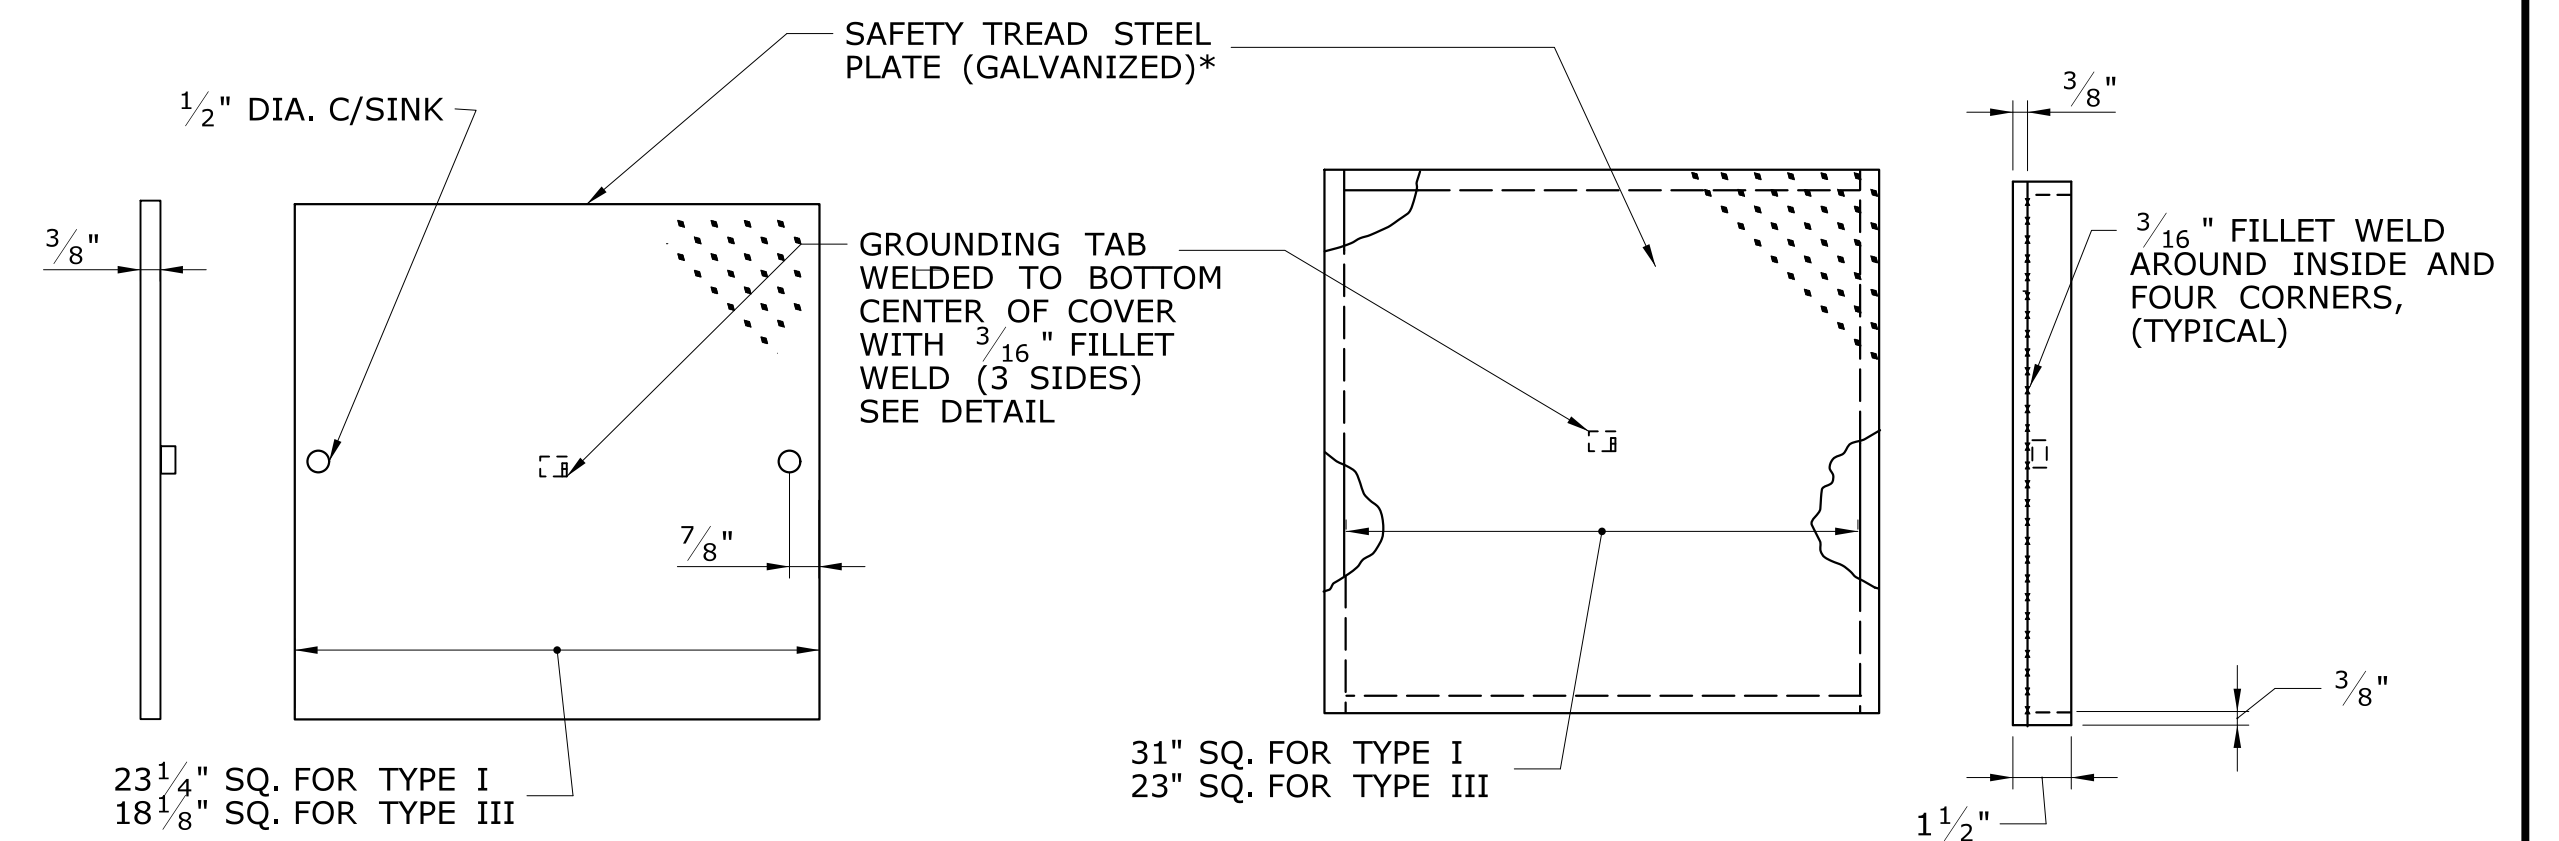


RECESSED COVER TO BE USED IN MEDIAN, IN PAVEMENT, IN SIDEWALK, OR WHERE INDICATED ON PLANS.


**RECESSED TYPE COVER**

\*GALVANIZE COMPLETE COVER ASSEMBLY AFTER WELDING


**OVERLAP TYPE COVER**

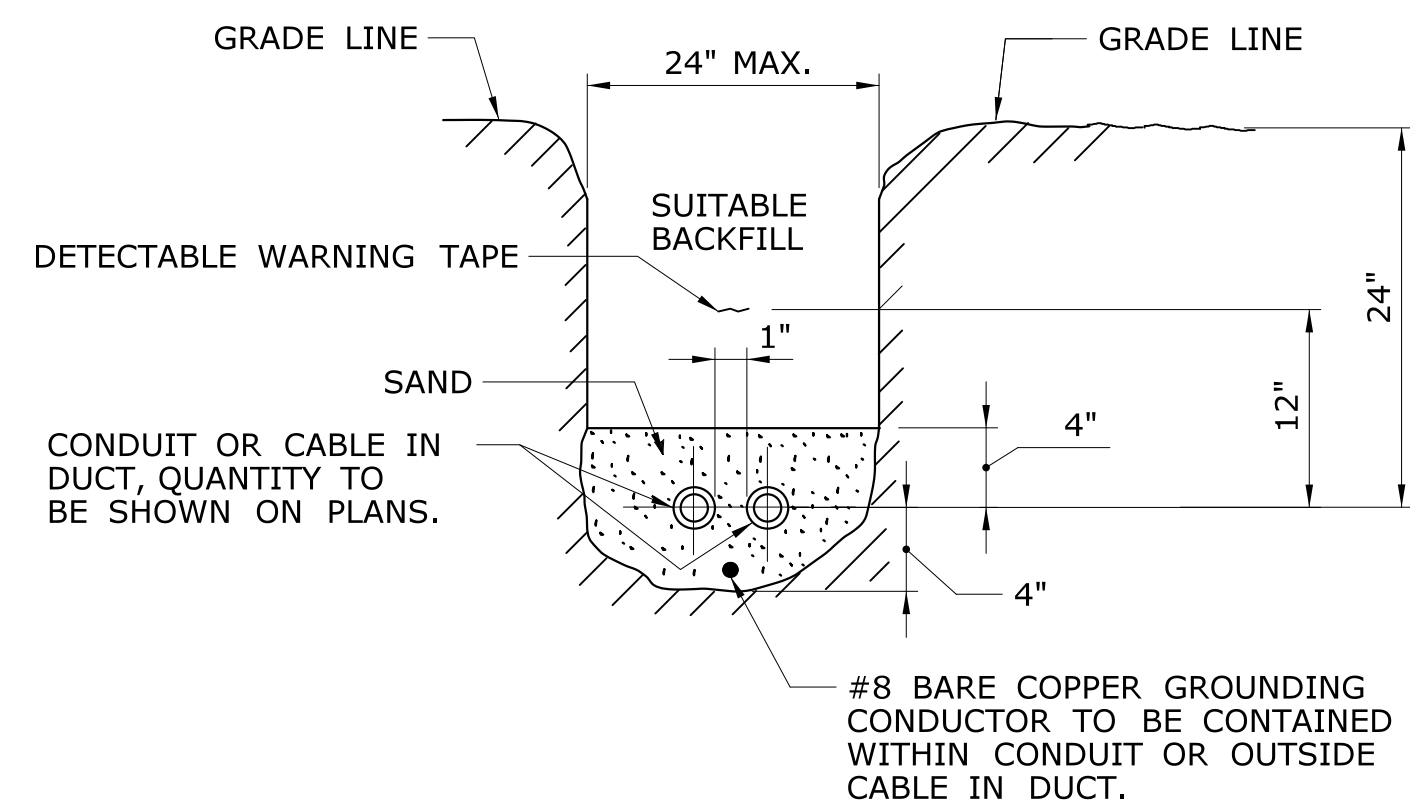

**BURIED CONDUIT OR CABLE IN DUCT**

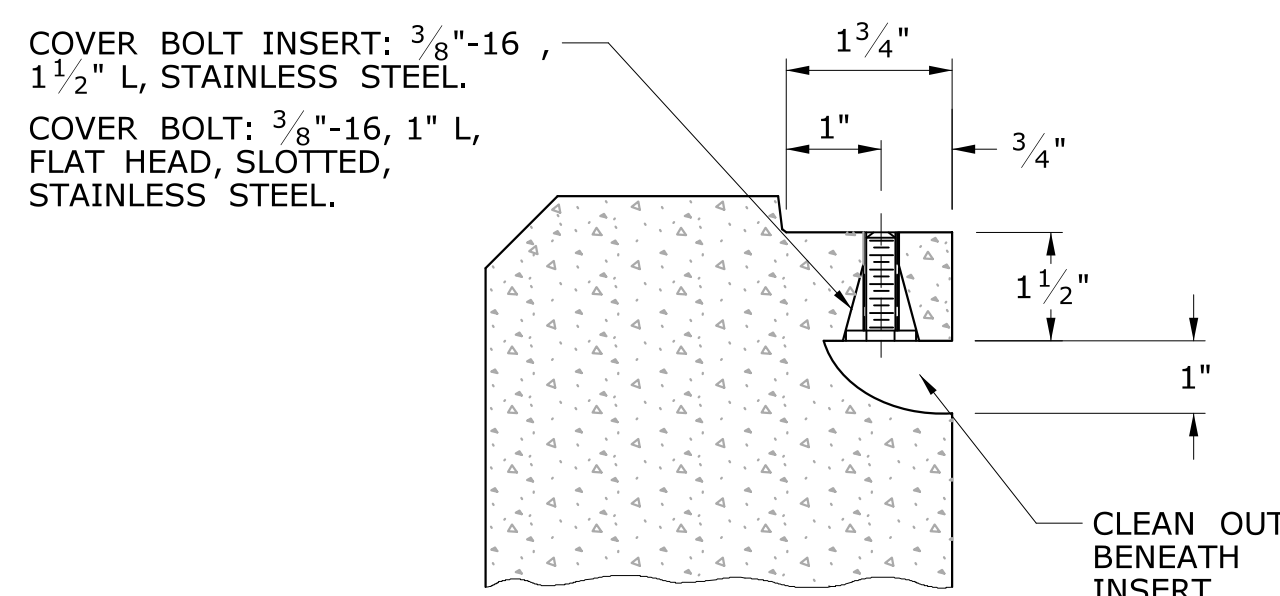


**THREADED INSERT**

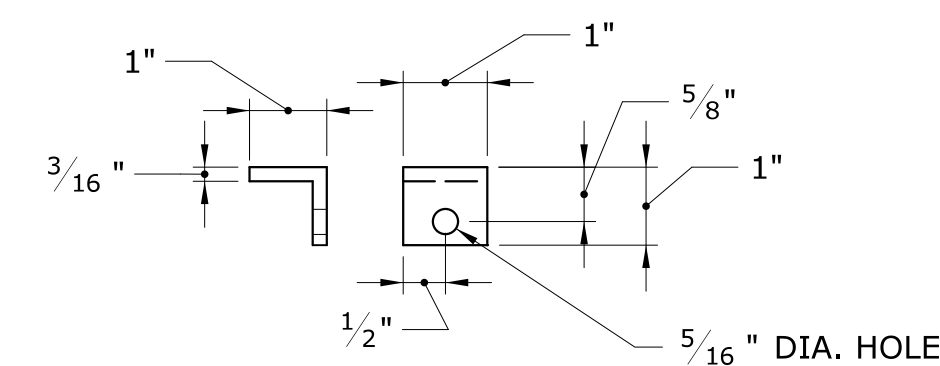


**STEEL GROUNDING TAB**

NOTE:  
ATTACH 72" LENGTH OF NO. 8 GROUND WIRE TO GROUNDING TAB WITH ONE HOLE LUG, 1/4" X 3/4" LG. SST HEX HEAD BOLT, AND SST FLAT WASHER. ATTACH FREE END OF GROUND WIRE TO NO. 8 BARE GROUND WIRE IN HANDHOLE.


<p>THE INFORMATION, INCLUDING ESTIMATED QUANTITIES OF WORK SHOWN ON THESE SHEETS IS BASED ON LIMITED INVESTIGATIONS BY THE STATE AND IS IN NO WAY WARRANTED TO INDICATE THE CONDITIONS OF ACTUAL QUANTITIES OF WORK WHICH WILL BE REQUIRED.</p>				<p>DESIGNER/DRAFTER: DDR</p> <p>CHECKED BY: MSB</p> <p>NO SCALE</p>	<p>STATE OF CONNECTICUT DEPARTMENT OF TRANSPORTATION</p> <p>Signature: <i>Chapman</i></p>	<p>PROJECT TITLE: <b>RELOCATION OF I-91 NB INTERCHANGE 29 AND WIDENING OF I-91 NB AND ROUTE 5/15 NB TO I-84 EB</b></p>	<p>CITY/TOWN: <b>HARTFORD EAST HARTFORD</b></p> <p>DRAWING TITLE: <b>CONCRETE HANDHOLES</b></p>	<p>PROJECT NO. <b>63-703</b></p> <p>DRAWING NO. <b>ILL-25</b></p> <p>SHEET NO. 01.11.02.25</p>
REV.	DATE	REVISION DESCRIPTION	SHEET NO.	Plotted Date: 3/9/2018	Filename: ...VHW_MSH_0063_0703_04_07_ILL-25-HANDHOLE.dgn			

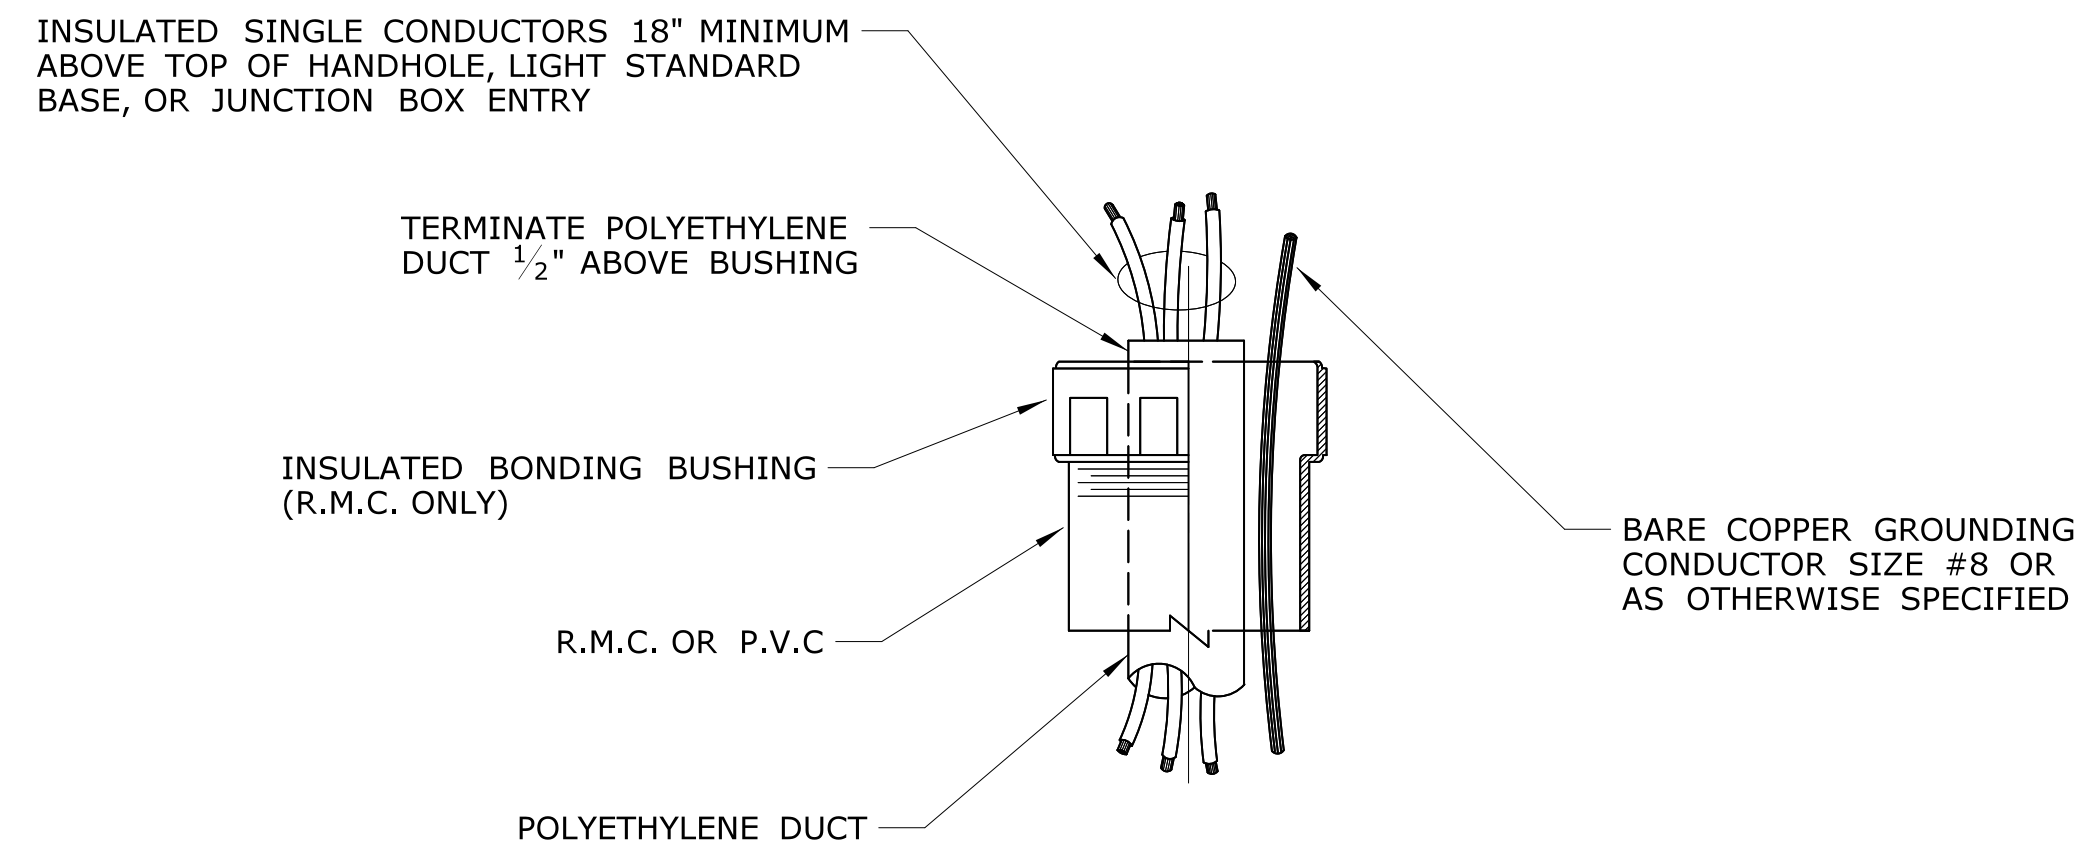

**CABLE IN DUCT TERMINATION AT LIGHT STANDARD BASE, HANDHOLE AND CAST IRON JUNCTION BOX**

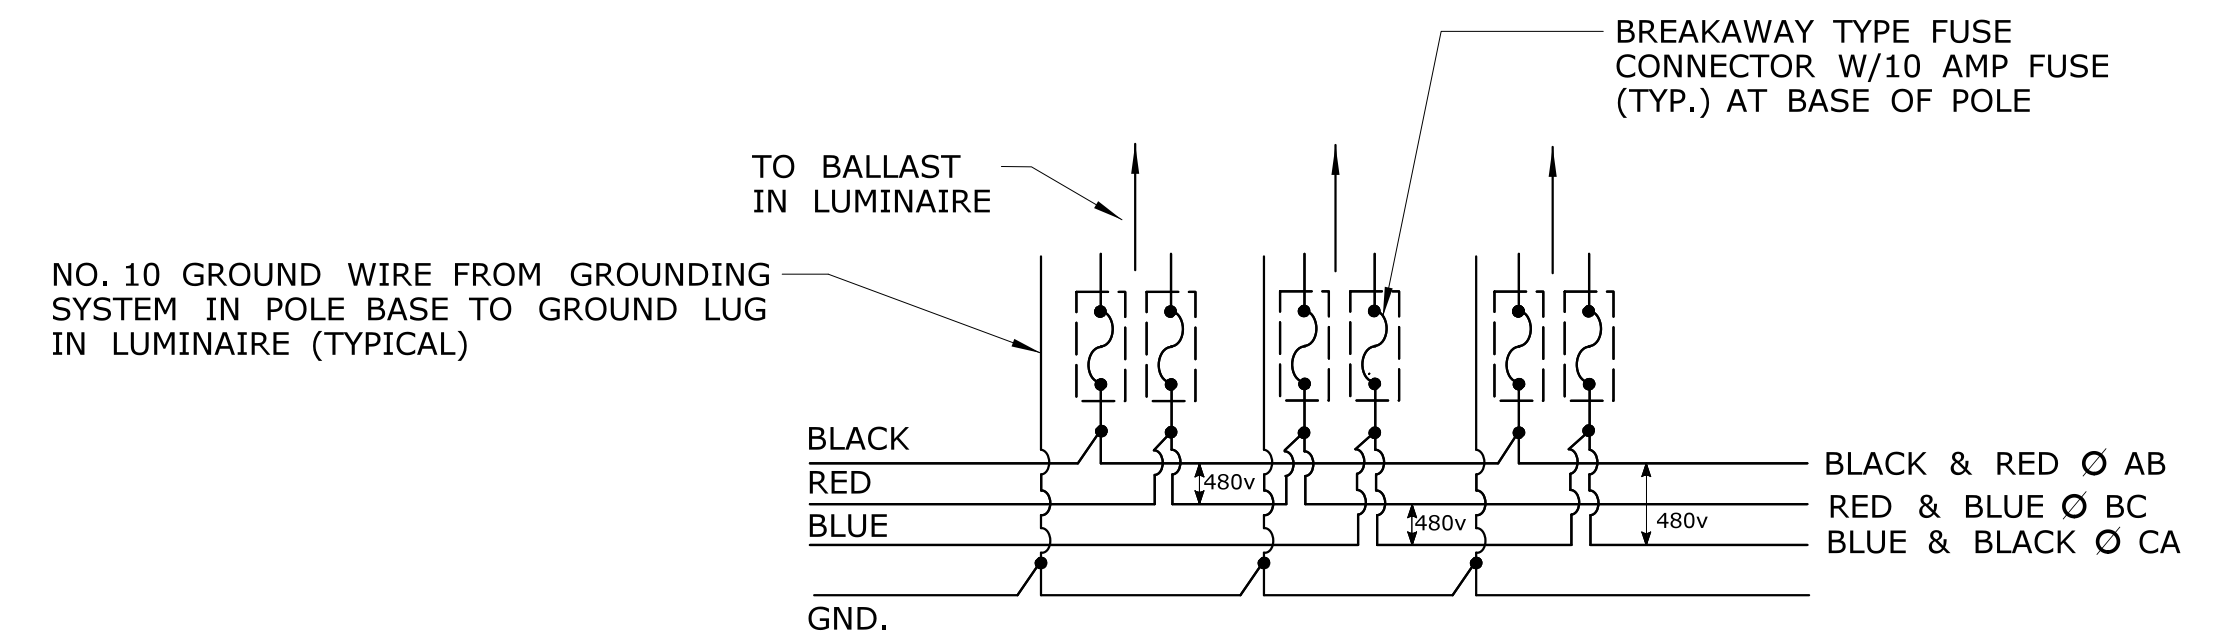


**3 PHASE 3 WIRE SYSTEM**

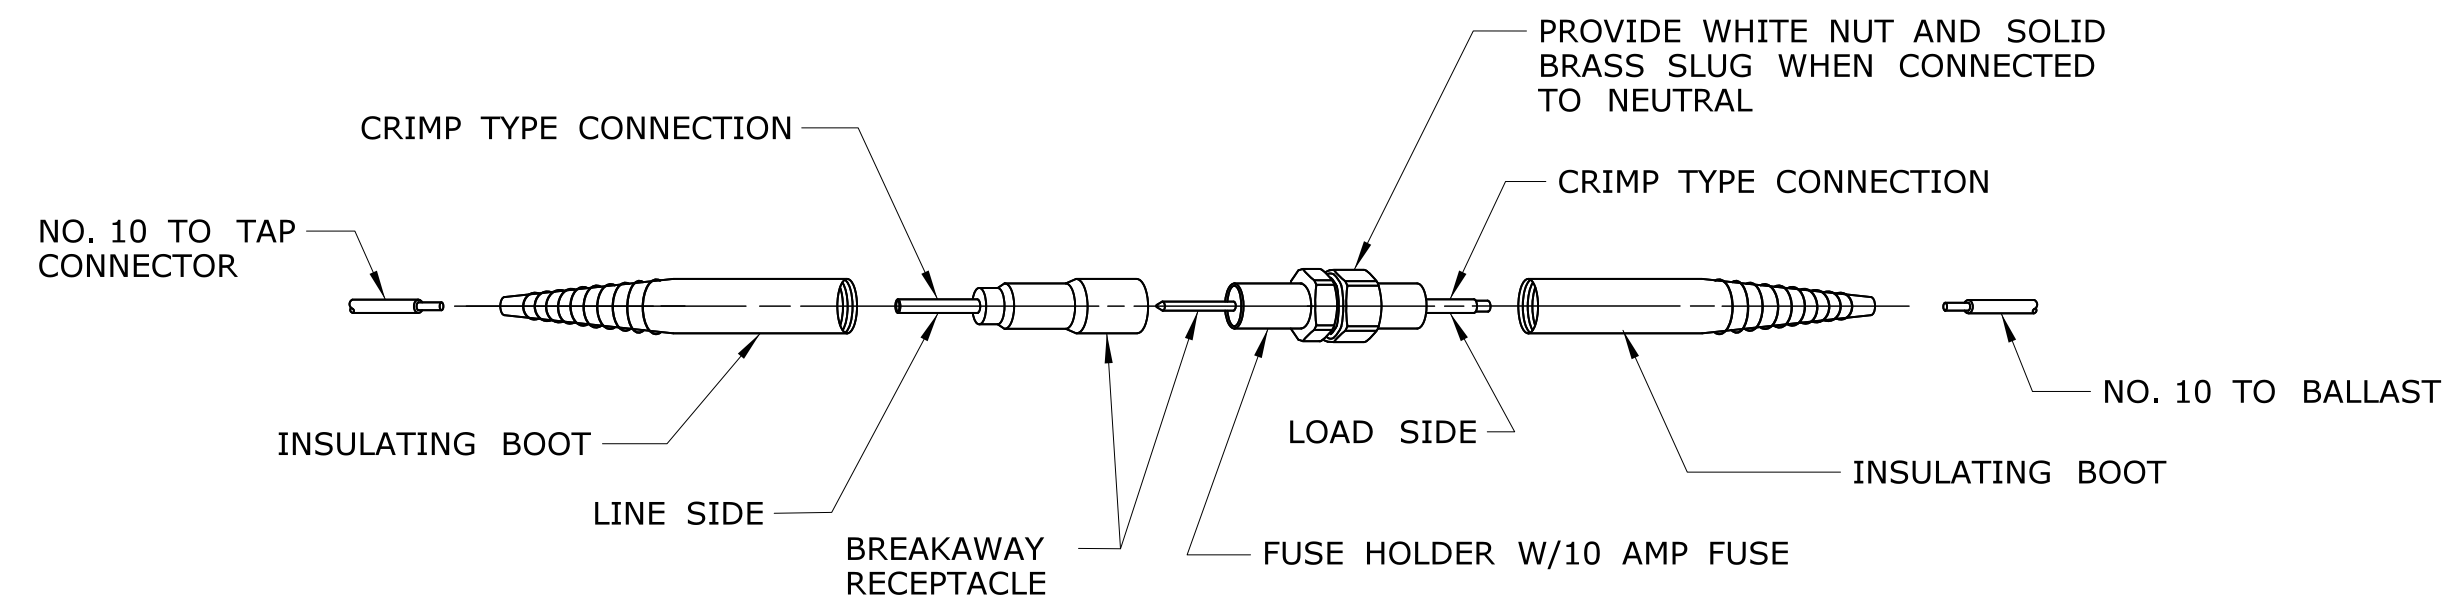


**BREAKAWAY FUSE CONNECTOR**

TO BE USED WITH TWIN LUMINAIRE LIGHT STANDARDS (4 REQUIRED PER LIGHT STANDARD) AND UNDERBRIDGE LUMINAIRES

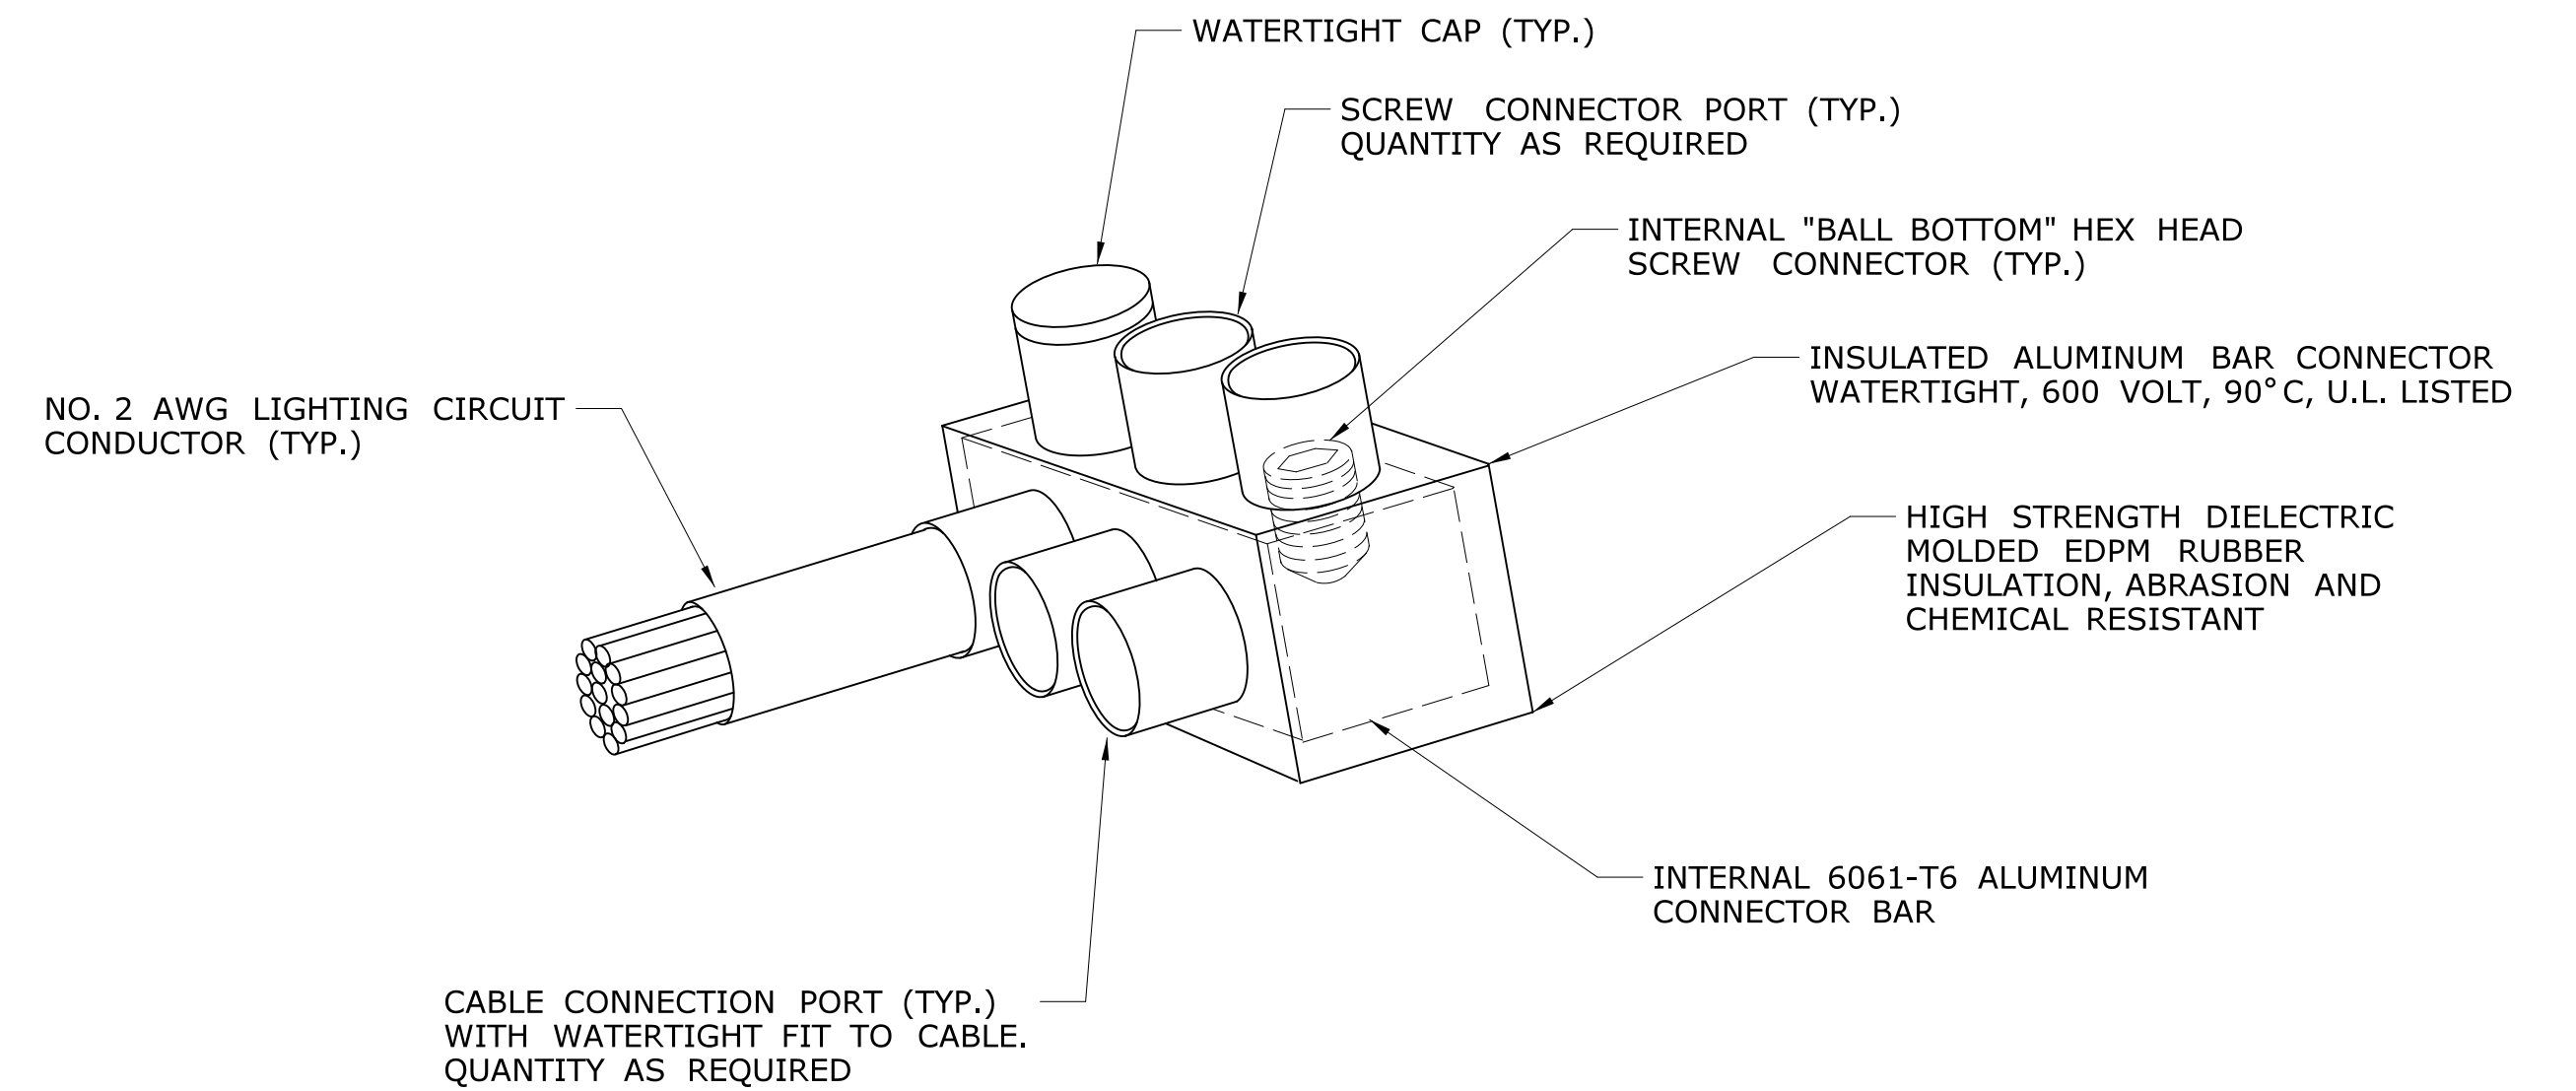

**WATERTIGHT CONNECTOR**


TO BE USED IN HANDHOLES AND JUNCTION BOXES

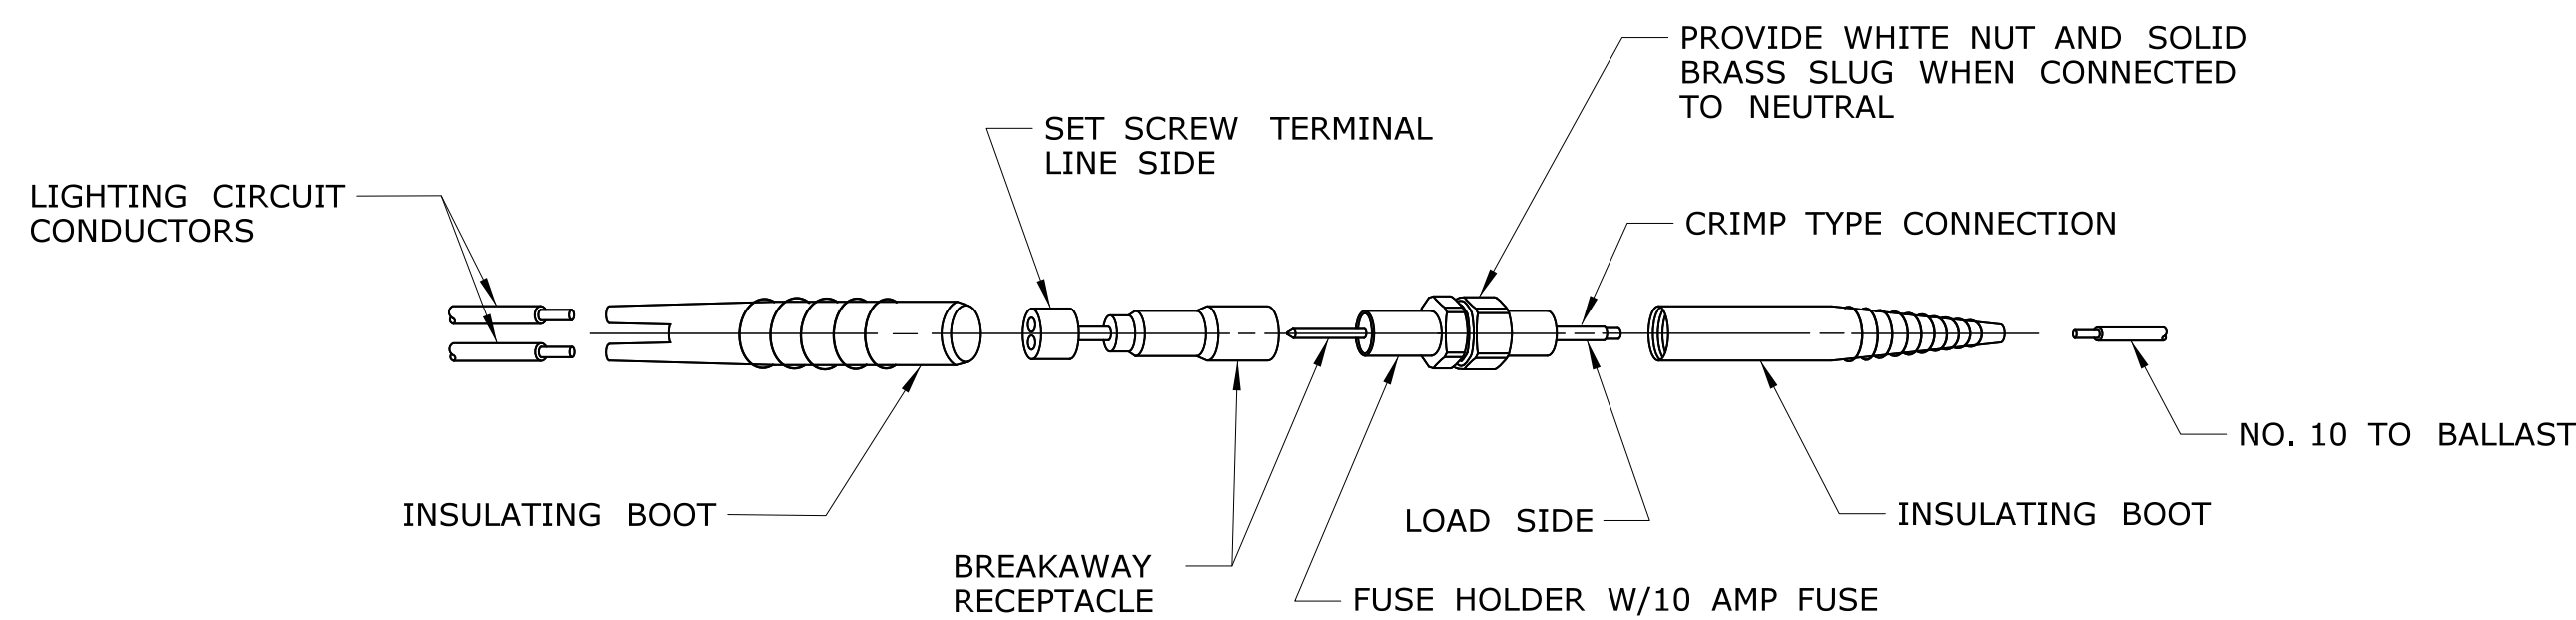

**BREAKAWAY FUSE CONNECTOR**

APPLY RUBBER SPLICING TAPE WITH APPROX. 50% OVERLAP TO A THICKNESS OVER THE CONNECTOR 1 1/2 TIMES THE FACTORY APPLIED INSULATION AND TAPER DOWN TO THE JACKET AT A POINT APPROX. 1/2" FROM THE EDGE OF PENCIL


COVER THE ENTIRE SPLICE PLUS 1 1/2" OF JACKET AT EACH END WITH 4 LAYERS OF SCOTCH #88 (OR EQUAL) PLASTIC ELECTRICAL TAPE CONSISTING OF TWO TAPES APPLIED SPIRALLY WITH A 50% OVERLAP

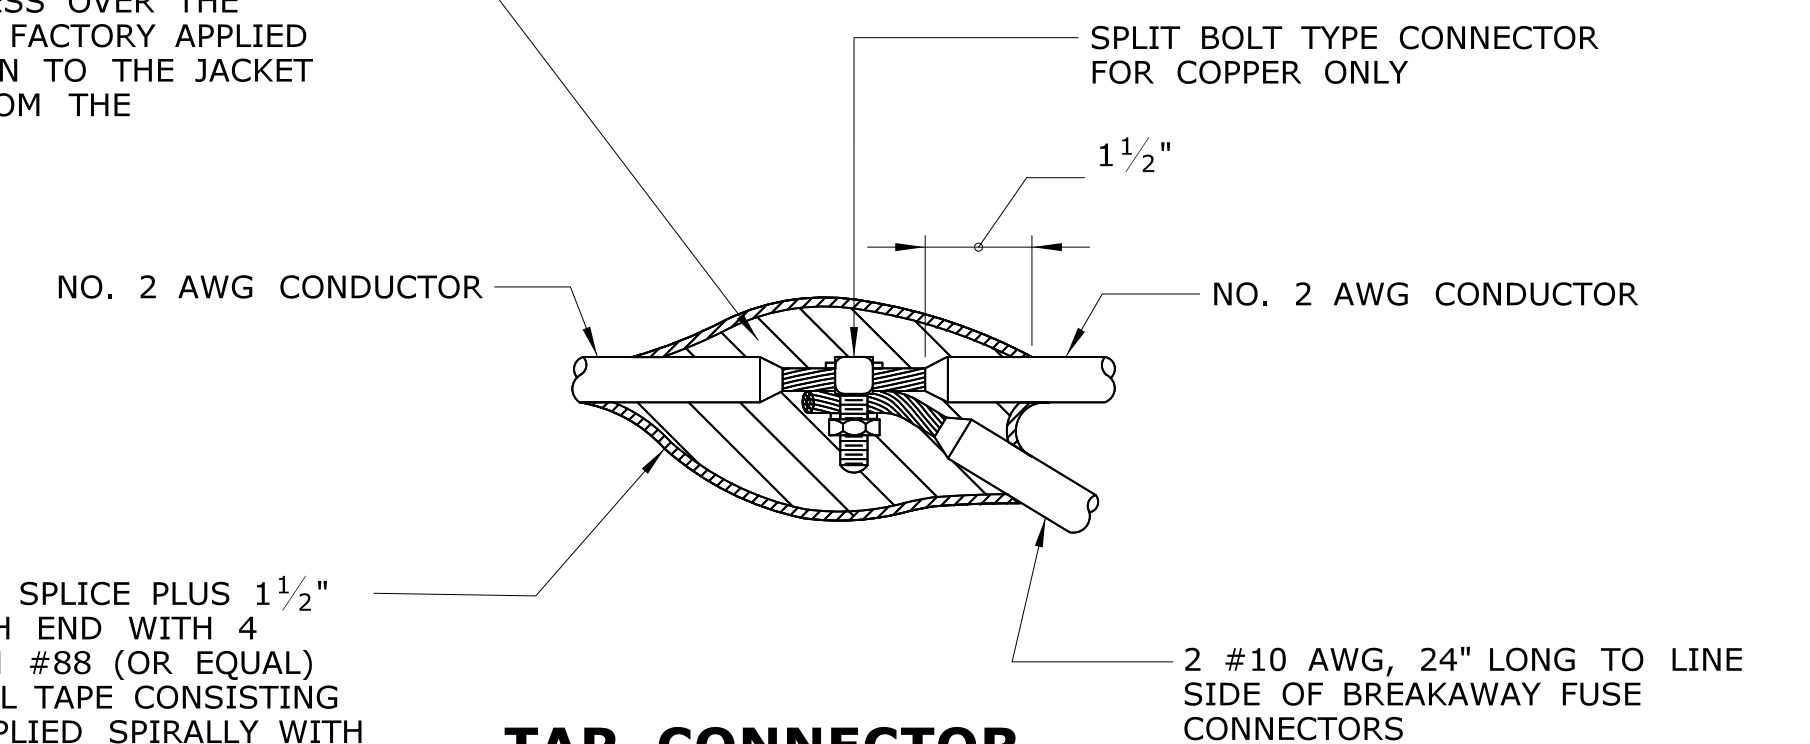

**TAP CONNECTOR**

TO BE USED W/TWIN LUMINAIRE LIGHT STANDARDS

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REV.	DATE	REVISION DESCRIPTION	SHEET NO.	Plotted Date: 3/9/2018				

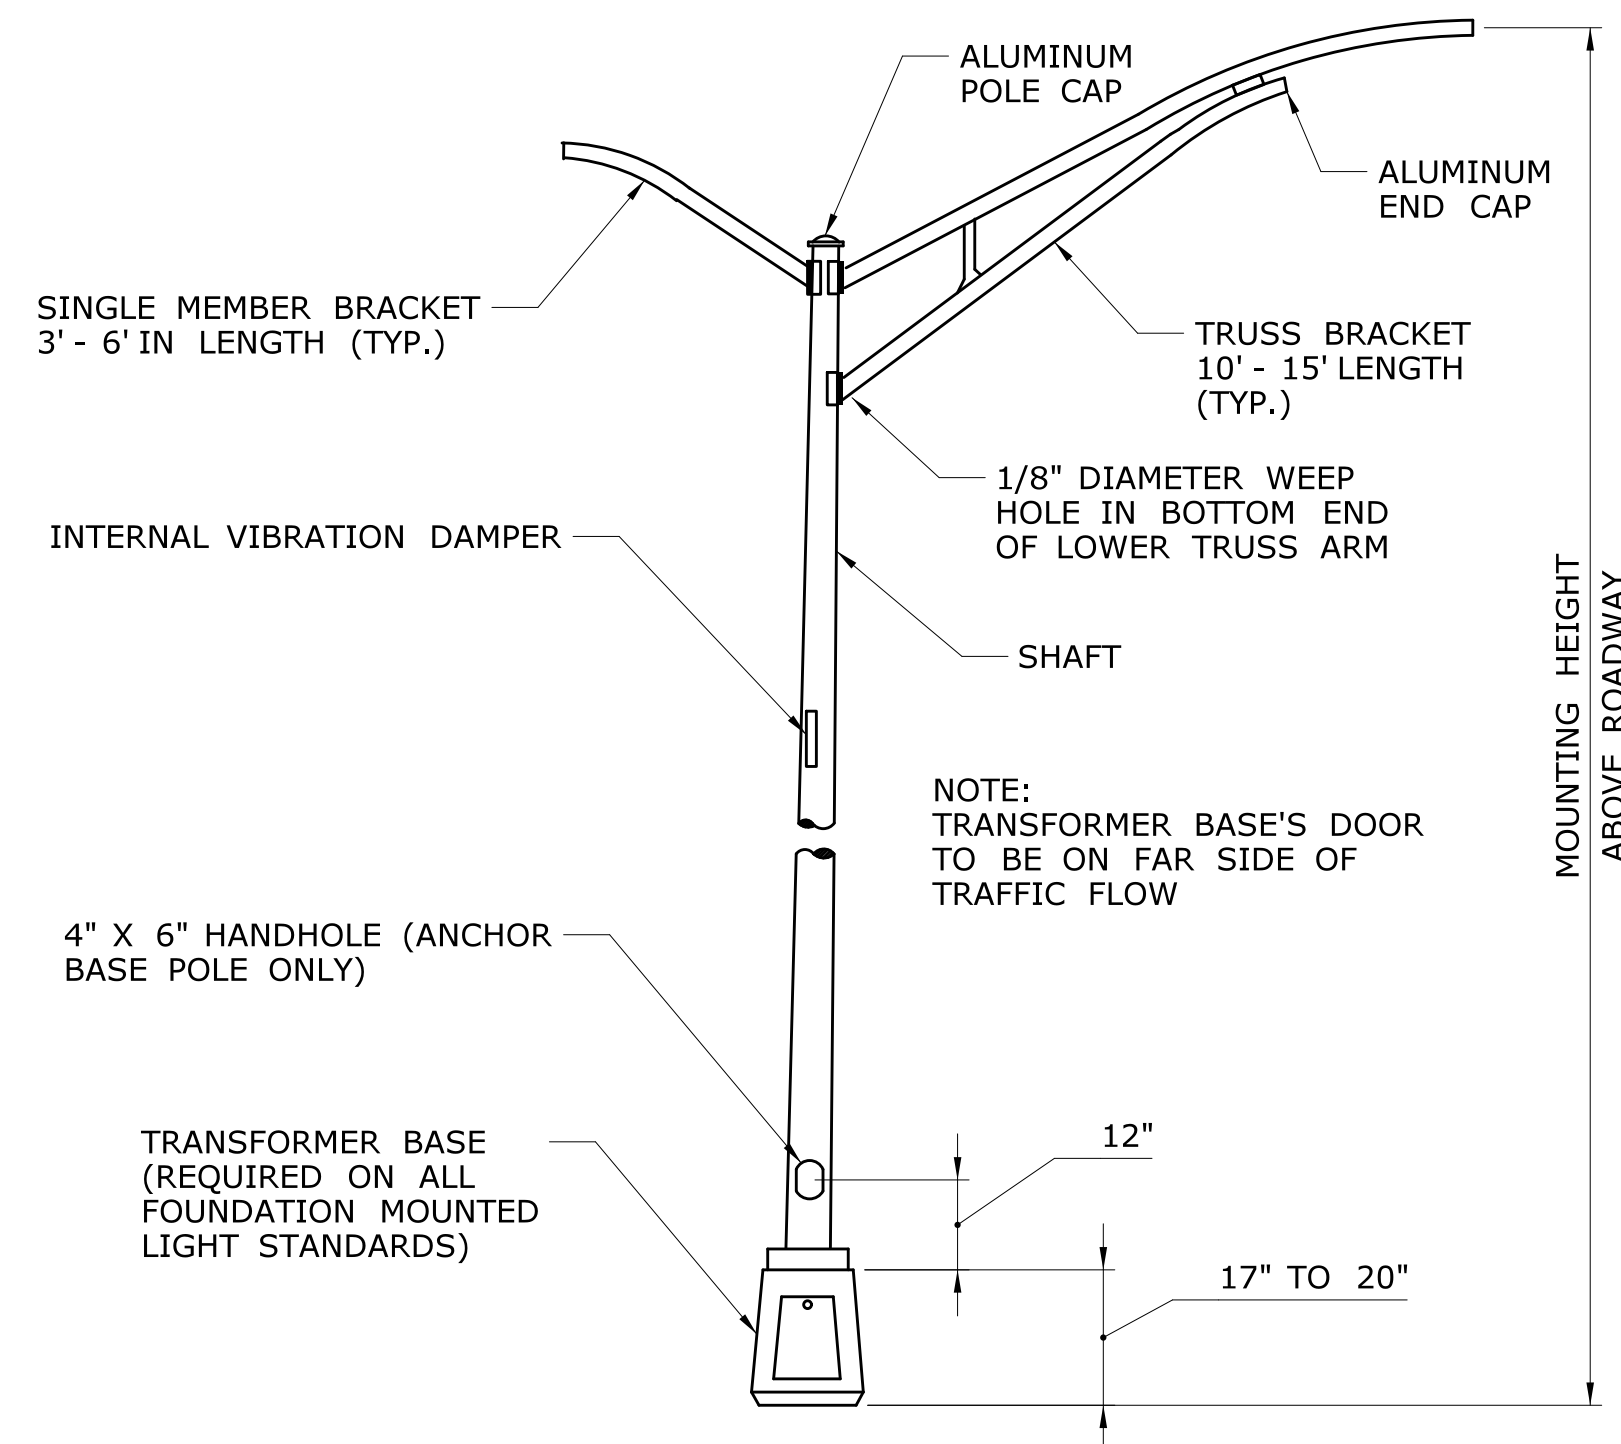

**ALUMINUM LIGHT STANDARD**



ALUMINUM LIGHT STANDARD - DIMENSION TABLE							
MOUNTING HEIGHT	BRACKET LENGTH	SHAFT DIAMETER		SHAFT WALL THICKNESS	BASE TYPE	ANCHOR BOLT SIZE	BOLT CIRCLE DIAMETER
		BOTTOM	TOP				
30'	6'	8"	6"	.156"	TRANSFORMER	1" x 40"	15"
30'	10'	8"	6"	.188"	ANCHOR	1" x 40"	11"
30'	12'	8"	6"	.188"	TRANSFORMER	1" x 40"	15"
40'	10'	10"	6"	.188"	ANCHOR	1" x 40"	15"
40'	12'	10"	6"	.188"	ANCHOR	1" x 40"	15"
40'	12'	10"	6"	.188"	TRANSFORMER	1" x 40"	15"
40'	15'	10"	6"	.188"	TRANSFORMER	1" x 40"	15"
40'	TWIN 10'	10"	6"	.312"	TRANSFORMER	1" x 40"	15"
40'	TWIN 12'	10"	6"	.312"	TRANSFORMER	1" x 40"	15"
** 40'	TWIN 12'	10"	6"	.312"	ANCHOR	1" x 40"	15"

\*\* NOTE: THE BRACKET ARMS ON THIS LIGHT STANDARD SHALL BE CLAMP ON TYPE AND CAPABLE OF MOUNTING AT VARIOUS LOCATIONS ALONG THE POLE SHAFT TO PROVIDE THE 40' LUMINAIRE MOUNTING HEIGHT OVER THE ROADWAY AS CALLED FOR ON THE PLANS


**LIGHT STANDARD NOTES:**

- ALUMINUM ALLOY SHALL BE 6063, T6 TEMPER.
- BOLT CIRCLE SHOWN IS FOR ANCHOR BASE BOTTOM OR TRANSFORMER BASE BOTTOM (WHICHEVER IS APPLICABLE).
- TO BE DESIGNED TO AASHTO "STANDARD SPECIFICATION FOR STRUCTURAL SUPPORTS FOR HIGHWAY SIGNS, LUMINAIRES AND TRAFFIC SIGNALS" FOR 90 M.P.H. WINDS.
- WELDING DESIGN AND FABRICATION SHALL CONFORM TO THE LATEST EDITION OF THE ANSI/AWS D1.2, STRUCTURAL WELDING CODE - ALUMINUM.
- FOR BASE CONNECTION WELDS, FABRICATION INSPECTION AND TESTING SHALL BE PERFORMED AS NECESSARY PRIOR TO ASSEMBLY, DURING ASSEMBLY, DURING WELDING, AND AFTER WELDING, TO ENSURE THAT MATERIALS AND WORKMANSHIP MEET THE REQUIREMENTS OF THE CONTRACT DOCUMENTS. FABRICATION INSPECTION AND TESTING IS THE RESPONSIBILITY OF THE CONTRACTOR. VERIFICATION INSPECTION AND TESTING IS THE PREROGATIVE OF THE ENGINEER (CONNDOT).
- NON-DESTRUCTIVE TESTING FOR ALUMINUM SHALL BE AS FOLLOWS: A RANDOM 25% OF ALL BASE CONNECTION WELDS SHALL BE INSPECTED IN ACCORDANCE WITH ASTM E-165 STANDARD PRACTICE FOR LIQUID PENETRANT INSPECTION METHOD.

BOLT CIRCLE DIAMETER	BOLT SPACING
15"	10 <sup>5</sup> / <sub>8</sub> "
17"	12"

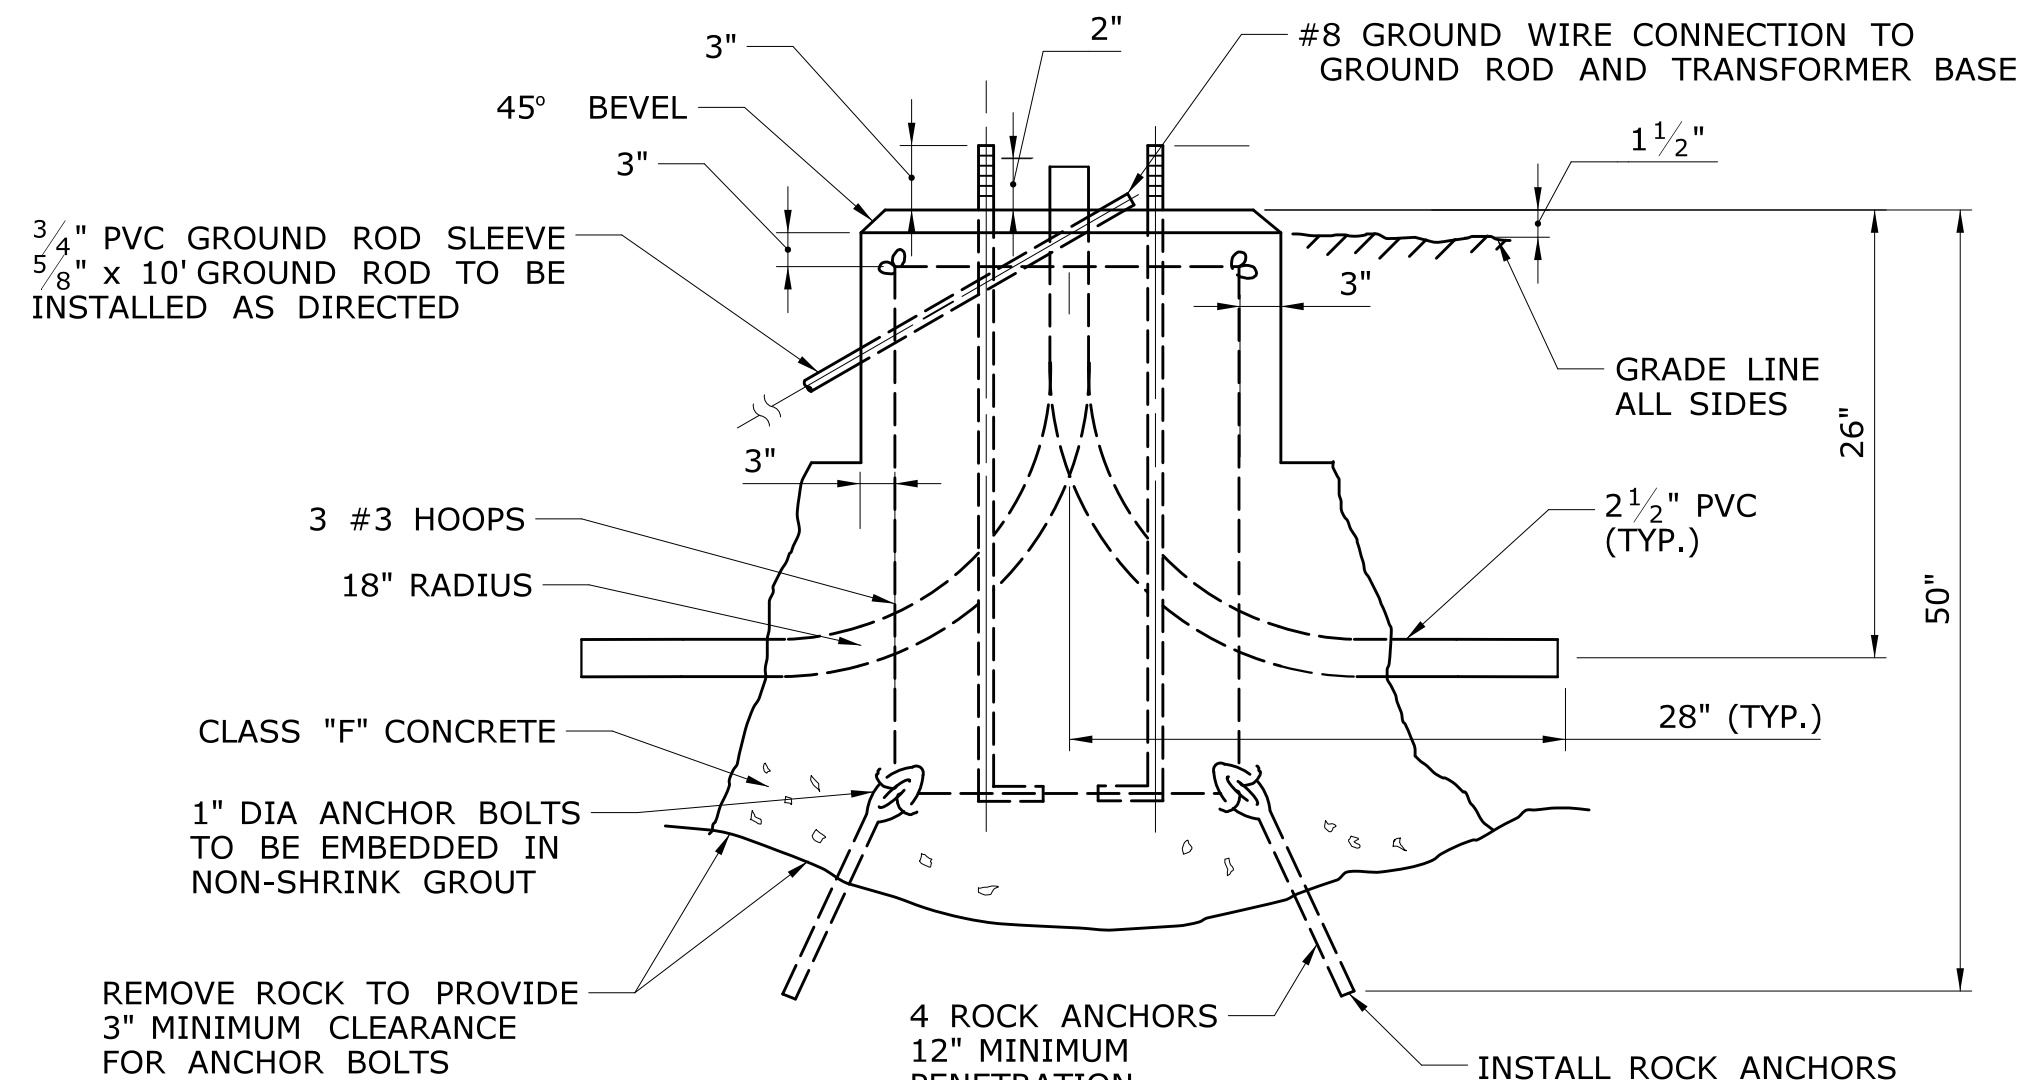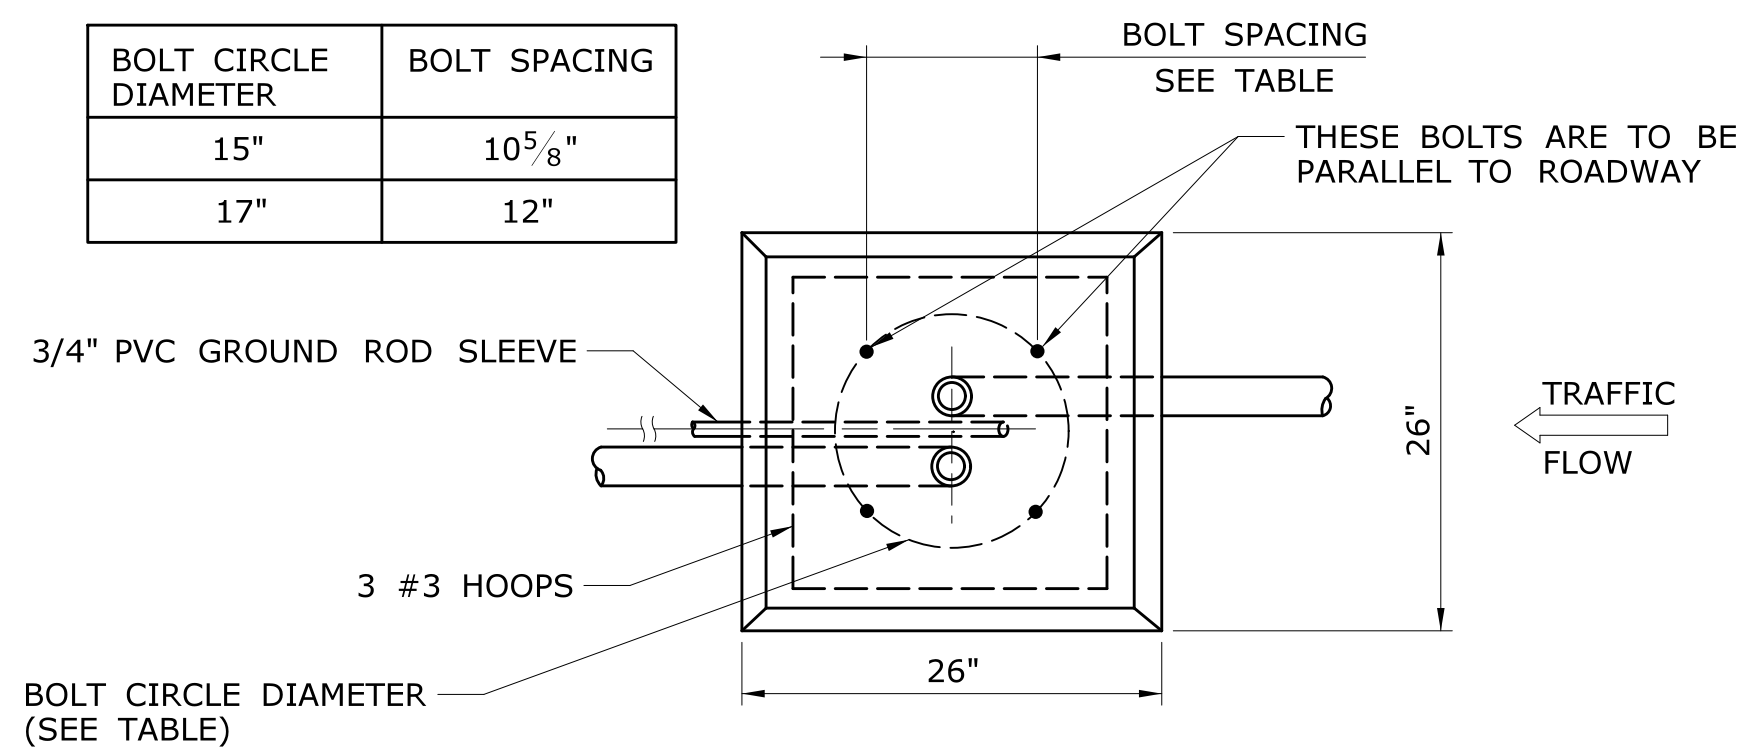


**LIGHT STANDARD FOUNDATION - TYPE II**

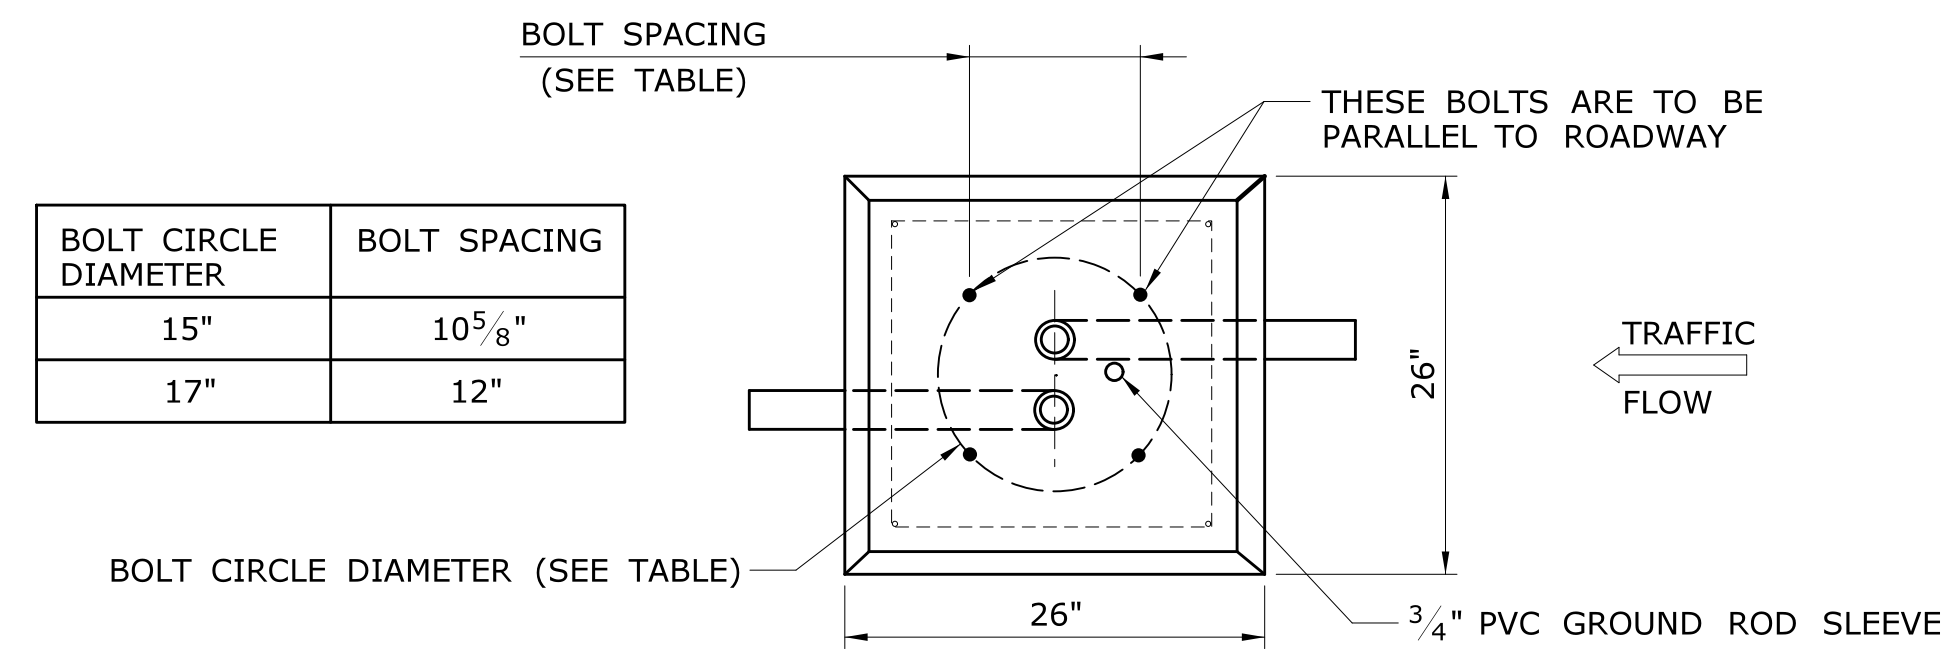


BOLT CIRCLE DIAMETER	BOLT SPACING
15"	10 <sup>5</sup> / <sub>8</sub> "
17"	12"

BOLT CIRCLE DIAMETER (SEE TABLE)

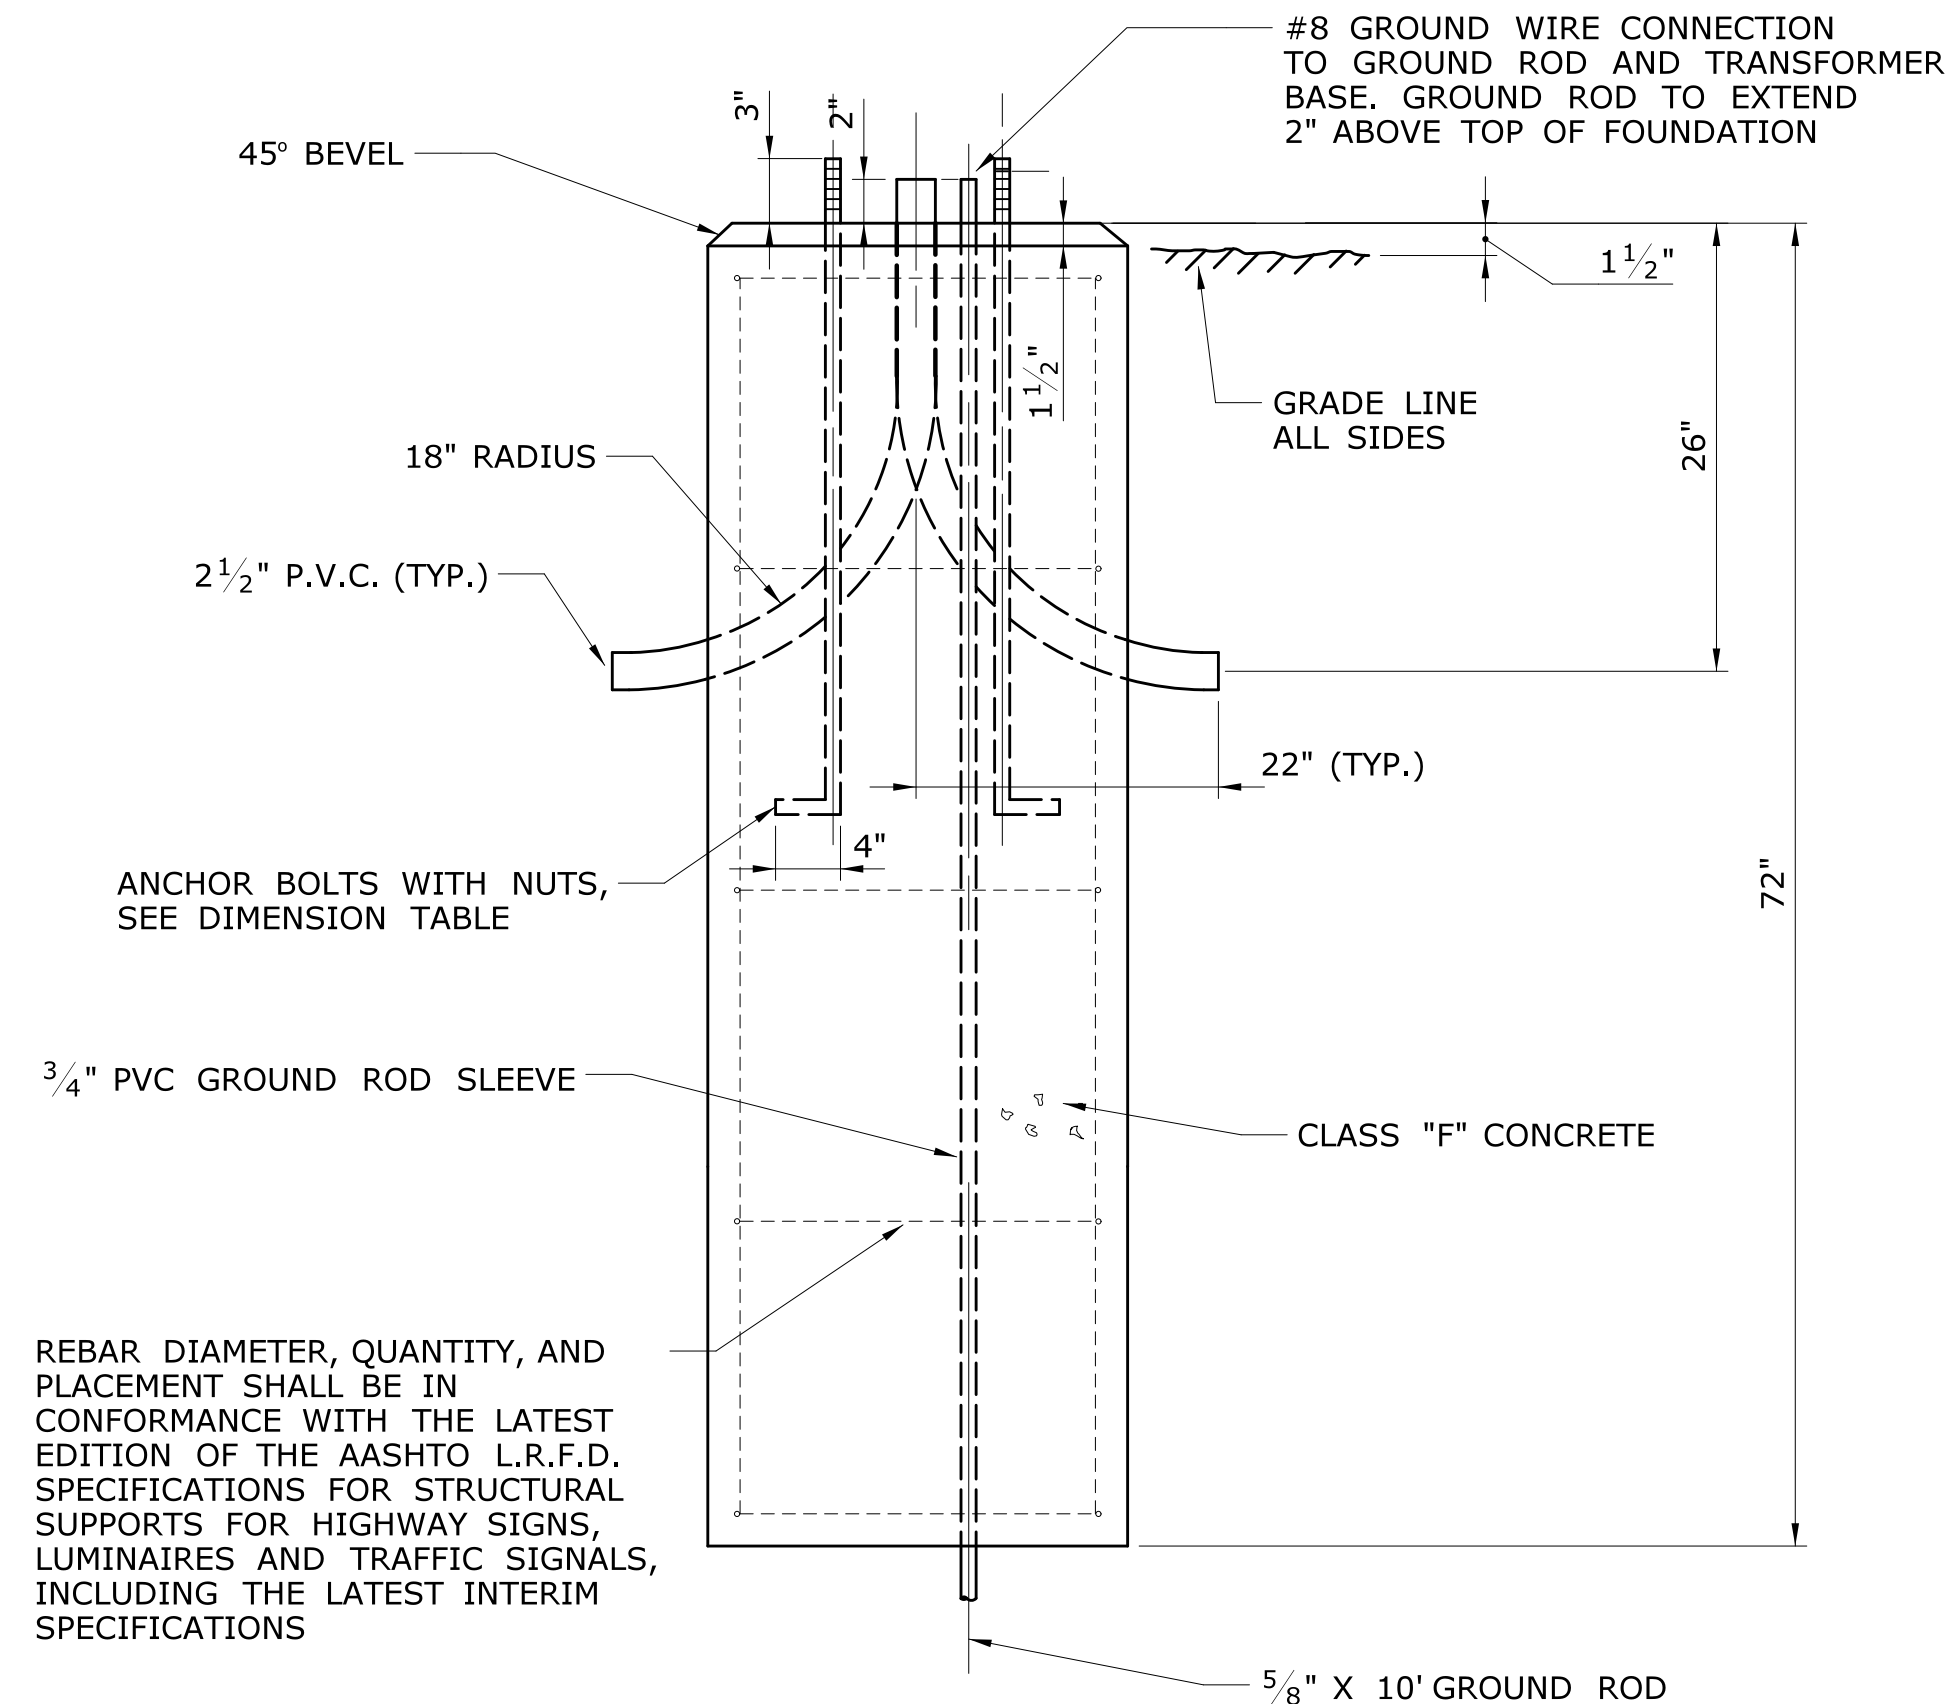

**LIGHT STANDARD FOUNDATION - TYPE I**

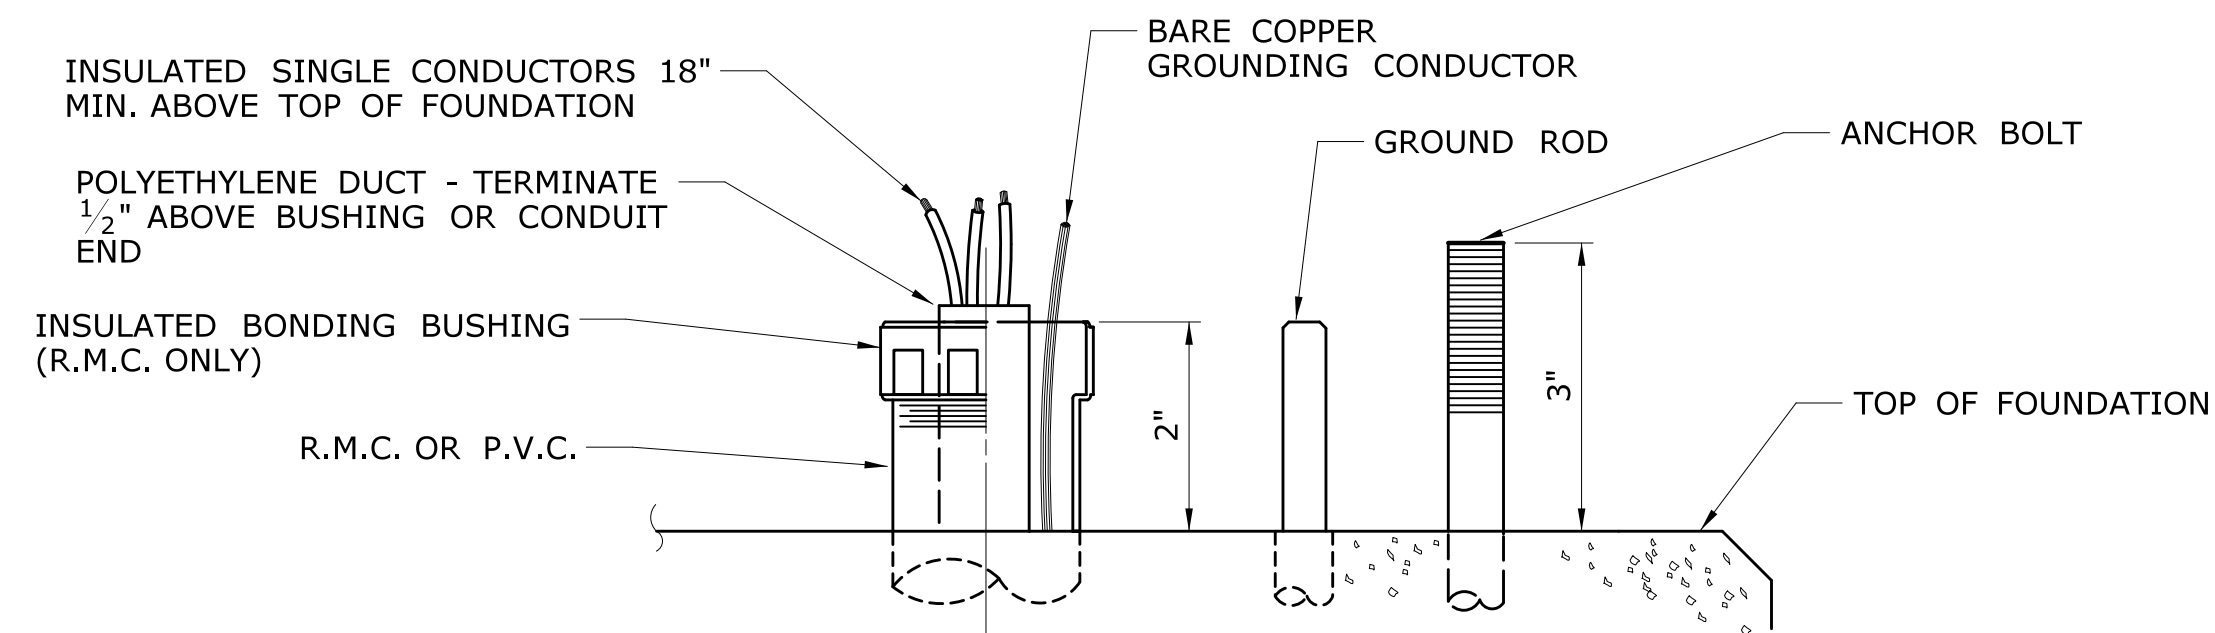


**CABLE IN DUCT TERMINATION AT LIGHT STANDARD BASE**

**NOTE:**


STEEL PLATE TO BE ATTACHED TO BRIDGE DECK USING CONNECTICUT D.O.T. APPROVED MECHANICAL ANCHOR (4). THREADED ROD SHALL BE 1/2" IN DIAMETER, 316 STAINLESS STEEL. MECHANICAL ANCHOR SHALL BE INSTALLED IN STRICT CONFORMANCE WITH MANUFACTURER'S SPECIFICATIONS.

**NOTE:**

ENTIRE PLATE ASSEMBLY TO BE HOT DIP GALVANIZED PER A.S.T.M. A123 AFTER FABRICATION

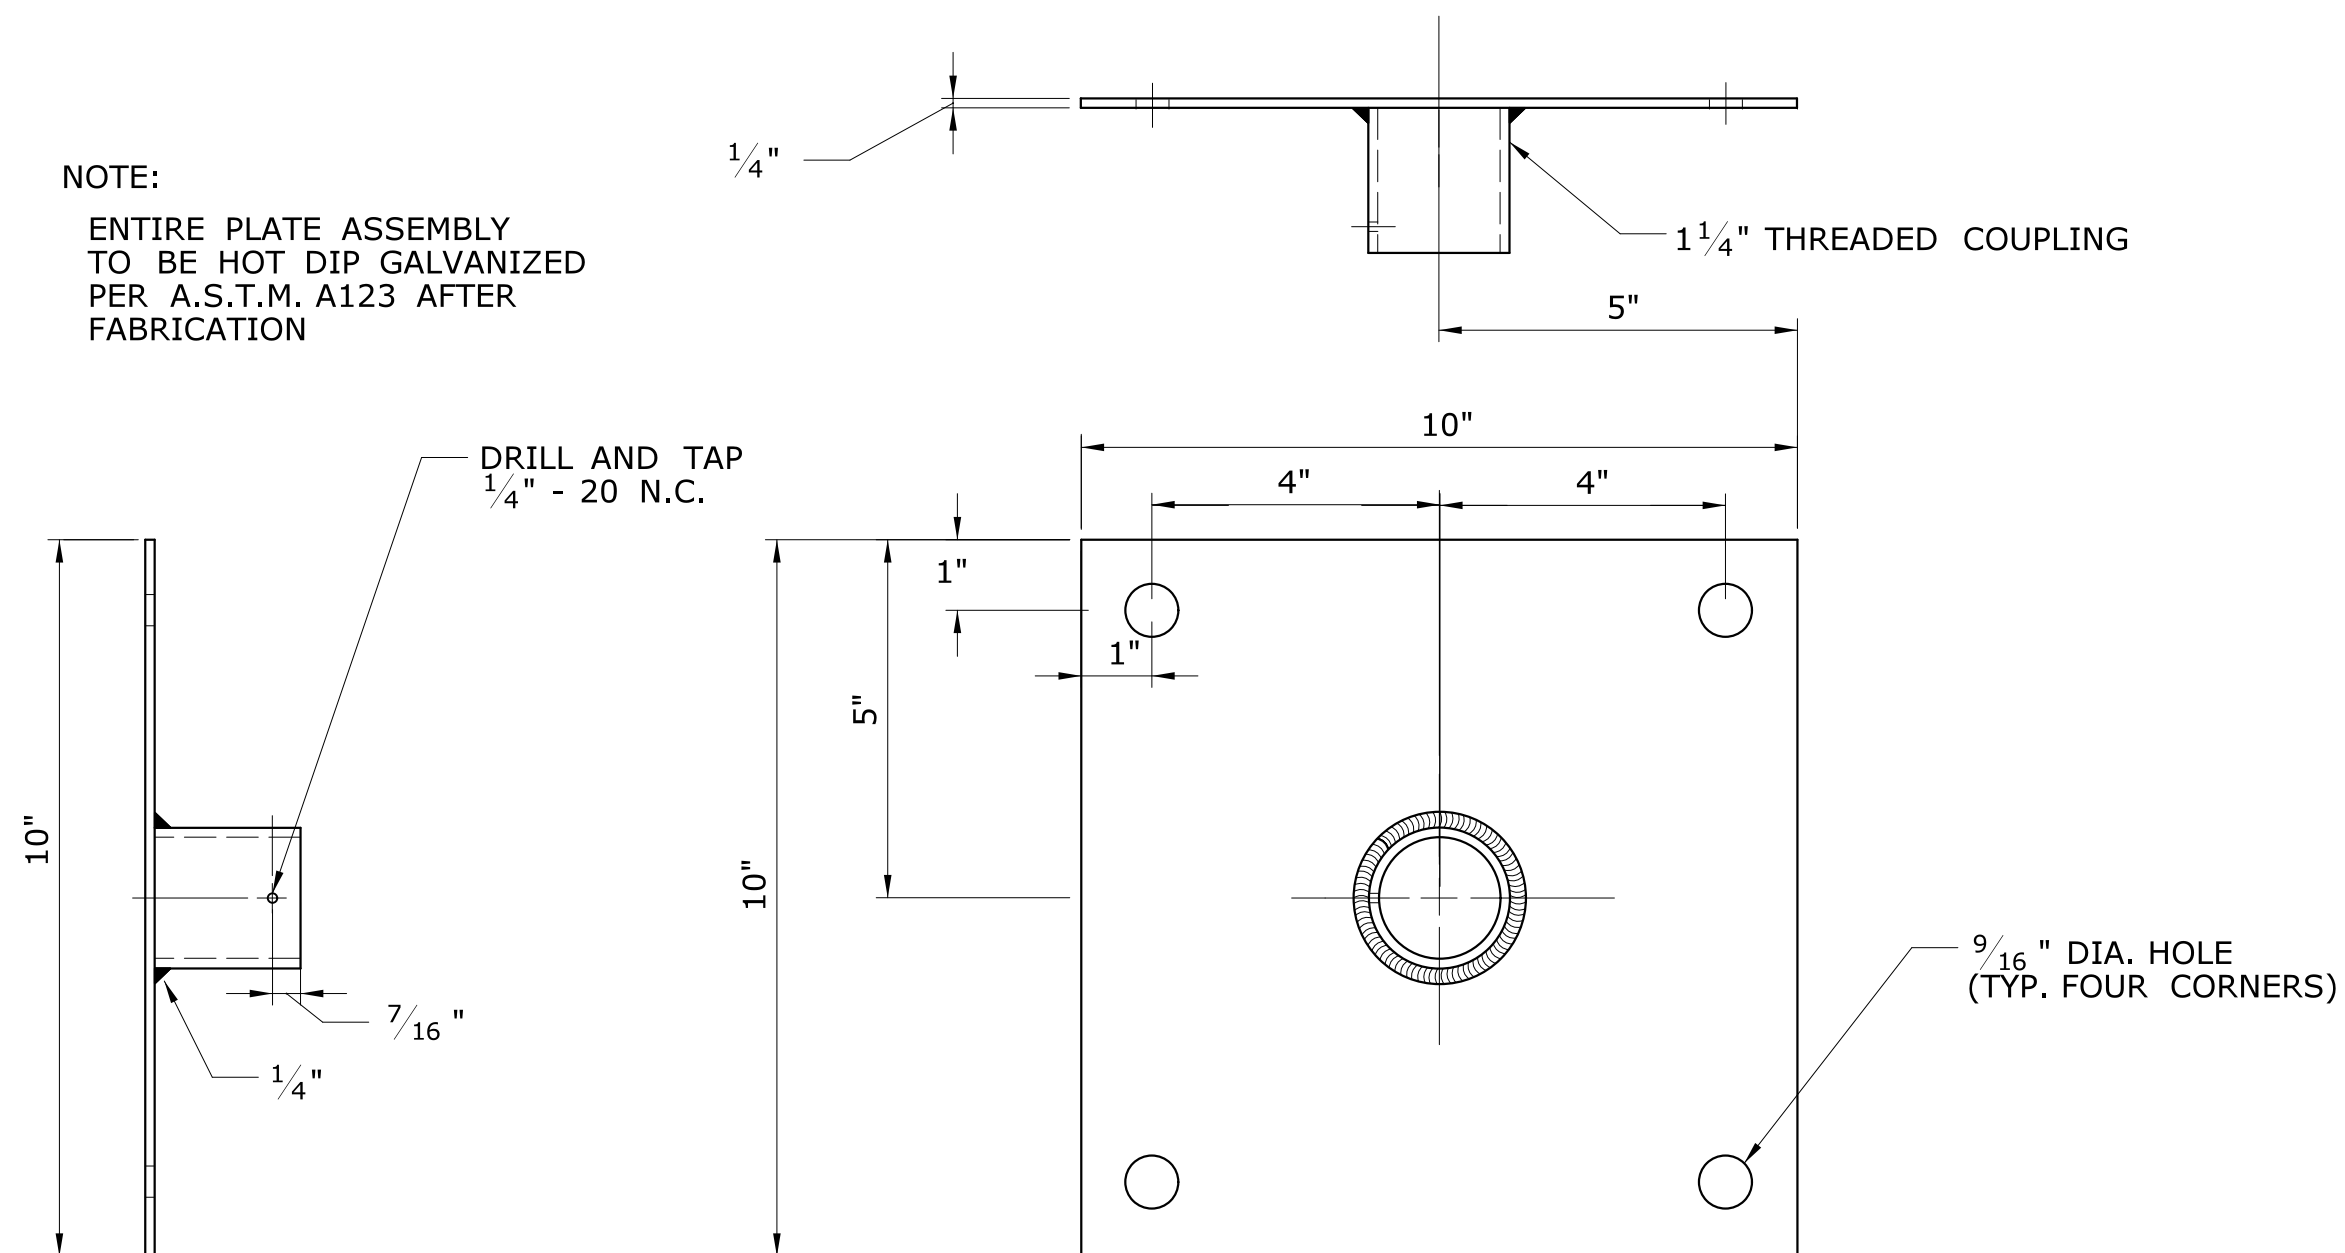

**STEEL PLATE FOR PENDANT LUMINAIRE**

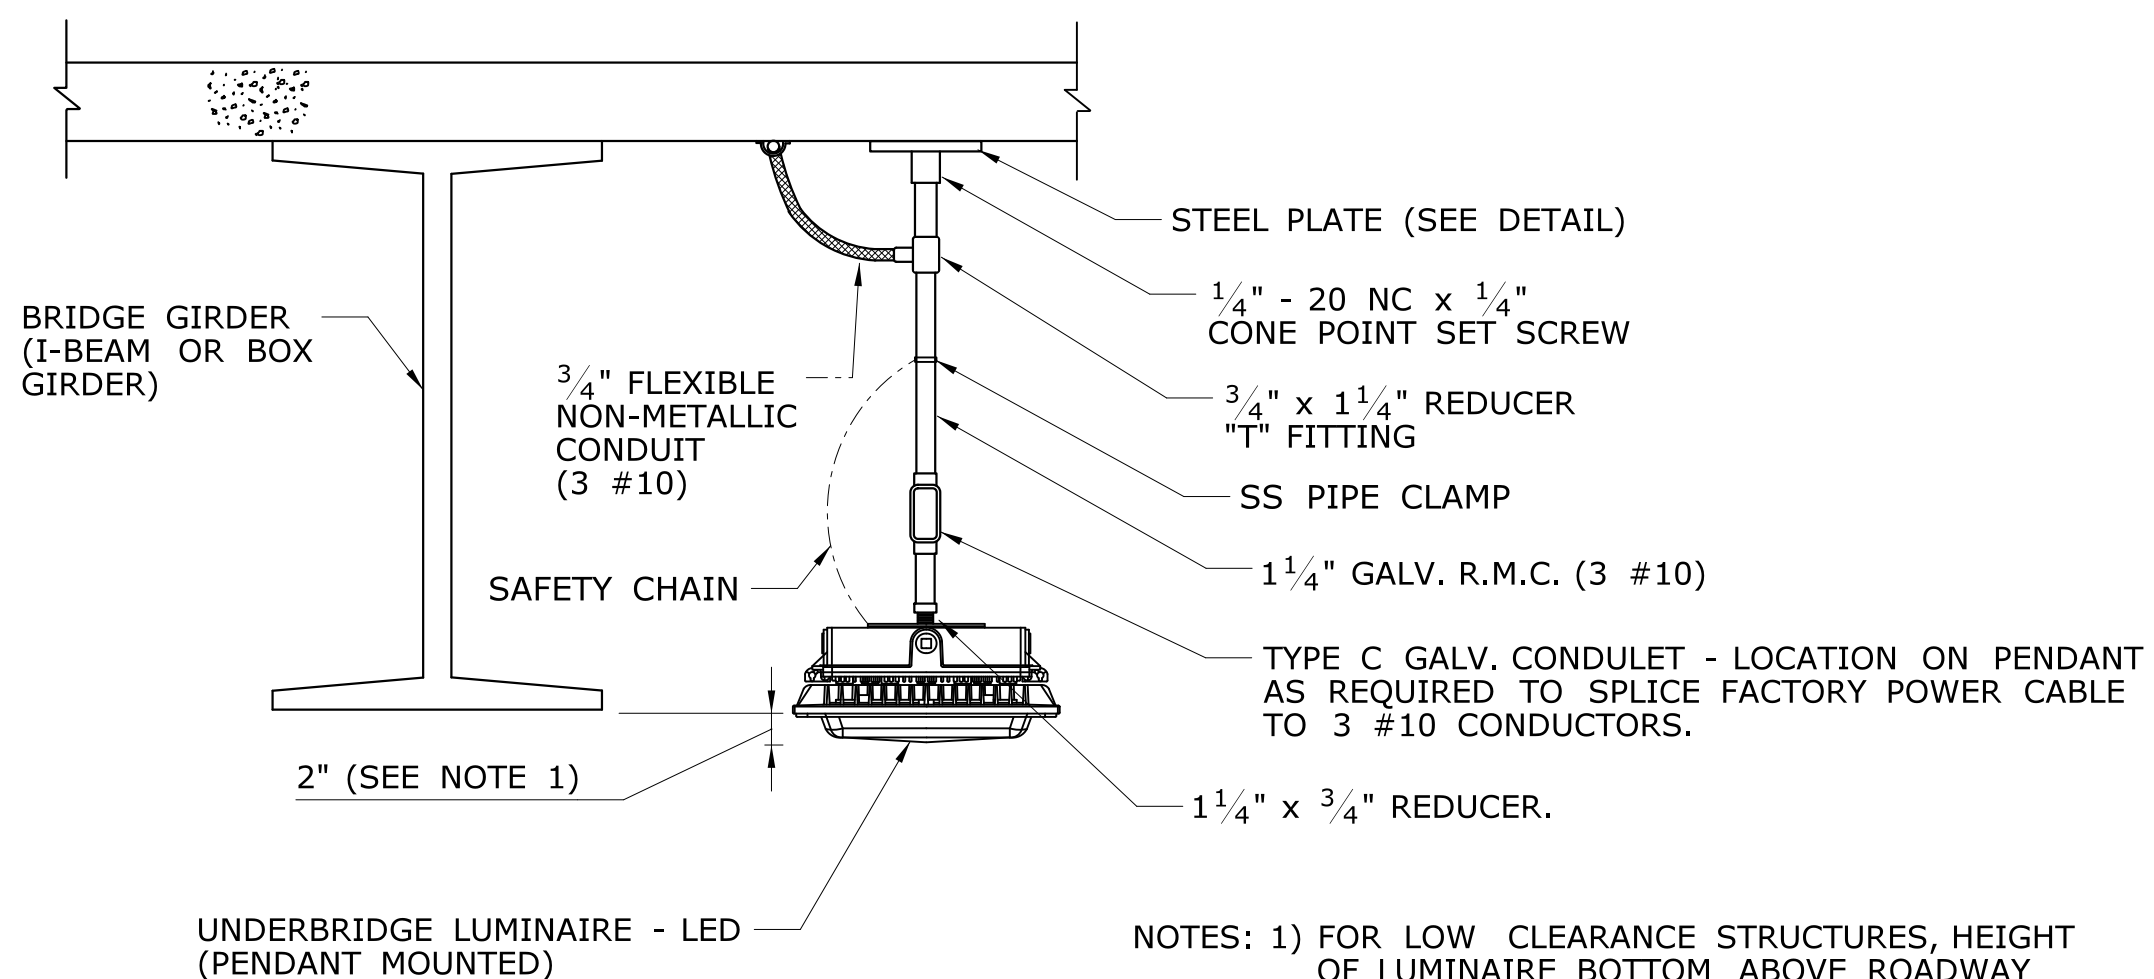


- NOTES: 1) FOR LOW CLEARANCE STRUCTURES, HEIGHT OF LUMINAIRE BOTTOM ABOVE ROADWAY SHALL NOT BE LESS THAN 14' - 3"  
 2) LUMINAIRE MOUNTING METHOD SHALL MAINTAIN IP66 RATING OR U.L. WET LOCATION LISTING OF LUMINAIRE  
 3) APPLY WATERPROOF THREAD SEALER TO ALL THREADED PENDANT CONNECTIONS (TYP.)


**UNDERBRIDGE LUMINAIRE - PENDENT MOUNTING**

**NOTES:**


1. THE CONTRACTOR SHALL COORDINATE WITH THE ENGINEER TO DETERMINE THE MAXIMUM AMOUNT OF MOVEMENT BETWEEN THE BRIDGE SUPERSTRUCTURE AND THE ABUTMENT/PIER. AN APPROPRIATE LENGTH OF FLEXIBLE CONDUIT SHALL BE INSTALLED TO ACCOMMODATE THIS MOVEMENT.
2. SURFACE MOUNTED JUNCTION BOX SHALL BE PAID FOR UNDER ITEM NO. 1009503A. 2" FGC (SURFACE), 2" FLEXIBLE CONDUIT (LFNC), NO. 2 CONDUCTORS, AND NO. 8 GROUNDING CONDUCTOR TO BE INCLUDED AS PART OF UNDERBRIDGE LIGHT ITEM.
3. 3/4" FIBERGLASS CONDUIT (FGC) SHALL BE STANDARD WALL TYPE (0.070" WALL THICKNESS). 2" FIBERGLASS CONDUIT SHALL BE EXTRA HEAVY WALL TYPE (0.250" WALL THICKNESS)
4. IF THE LIGHTING PLANS INDICATE THAT THE ELECTRICAL FEED TO THE UNDERBRIDGE LUMINAIRE IS TO COME FROM AN ADJACENT CONCRETE HANDHOLE, THEN THE SURFACE MOUNTED JUNCTION BOX, 2" LFNC, 2" FGC, AND CONDUCTORS BACK TO THE CIJB ARE NOT TO BE INSTALLED. FOR FEED FROM CONCRETE HANDHOLE, EXTEND 3/4" FGC (WITH 3 #10) TO HANDHOLE, INSTALL FUSE KITS, AND MAKE CIRCUIT CONNECTION IN HANDHOLE.
5. CONDUIT SUPPORT SPACING SHALL NOT EXCEED 3'-0" AS PER N.E.C. 355.30.
6. ALL MECHANICAL ANCHORS AND MOUNTING HARDWARE SHALL BE TYPE 316 STAINLESS STEEL.
7. WHEN THE FGC IS 50' TO 200' LONG, INSTALL ONE SINGLE EXPANSION CONDUIT JOINT (4" MOVEMENT) AT THE MID-POINT OF THE CONDUIT RUN. FOR CONDUIT LENGTHS OVER 200', INSTALL ONE SINGLE EXPANSION CONDUIT JOINT EVERY 200'. AT BRIDGE EXPANSION JOINTS, INSTALL ONE DOUBLE EXPANSION (8" MOVEMENT) CONDUIT JOINT. CONDUIT EXPANSION JOINTS SHALL HAVE AN INTERNAL O-RING.
8. WHERE FIBERGLASS CONDUIT IS FIELD CUT, THE OUTSIDE SURFACE OF THE CUT END SHALL BE SANDED TO REMOVE THE RESIN GLAZE PRIOR TO APPLYING ADHESIVE.
9. WHEN ATTACHING FGC TO CONCRETE, TWO HOLE MOUNTING STRAPS SHALL BE USED. THE TWO HOLE MOUNTING STRAPS SHALL BE SIZED TO ALLOW THE CONDUIT TO FLOAT FREELY WITHIN THE STRAP.
10. WHEN ATTACHING FGC TO STEEL, A "SLIP COLLAR" SHALL BE INSTALLED AT ALL CLAMP LOCATIONS TO ALLOW THE CONDUIT TO FLOAT FREELY WITHIN THE COLLAR. CLAMPS SHALL BE ONE HOLE TYPE OR BEAM CLAMP TYPE.

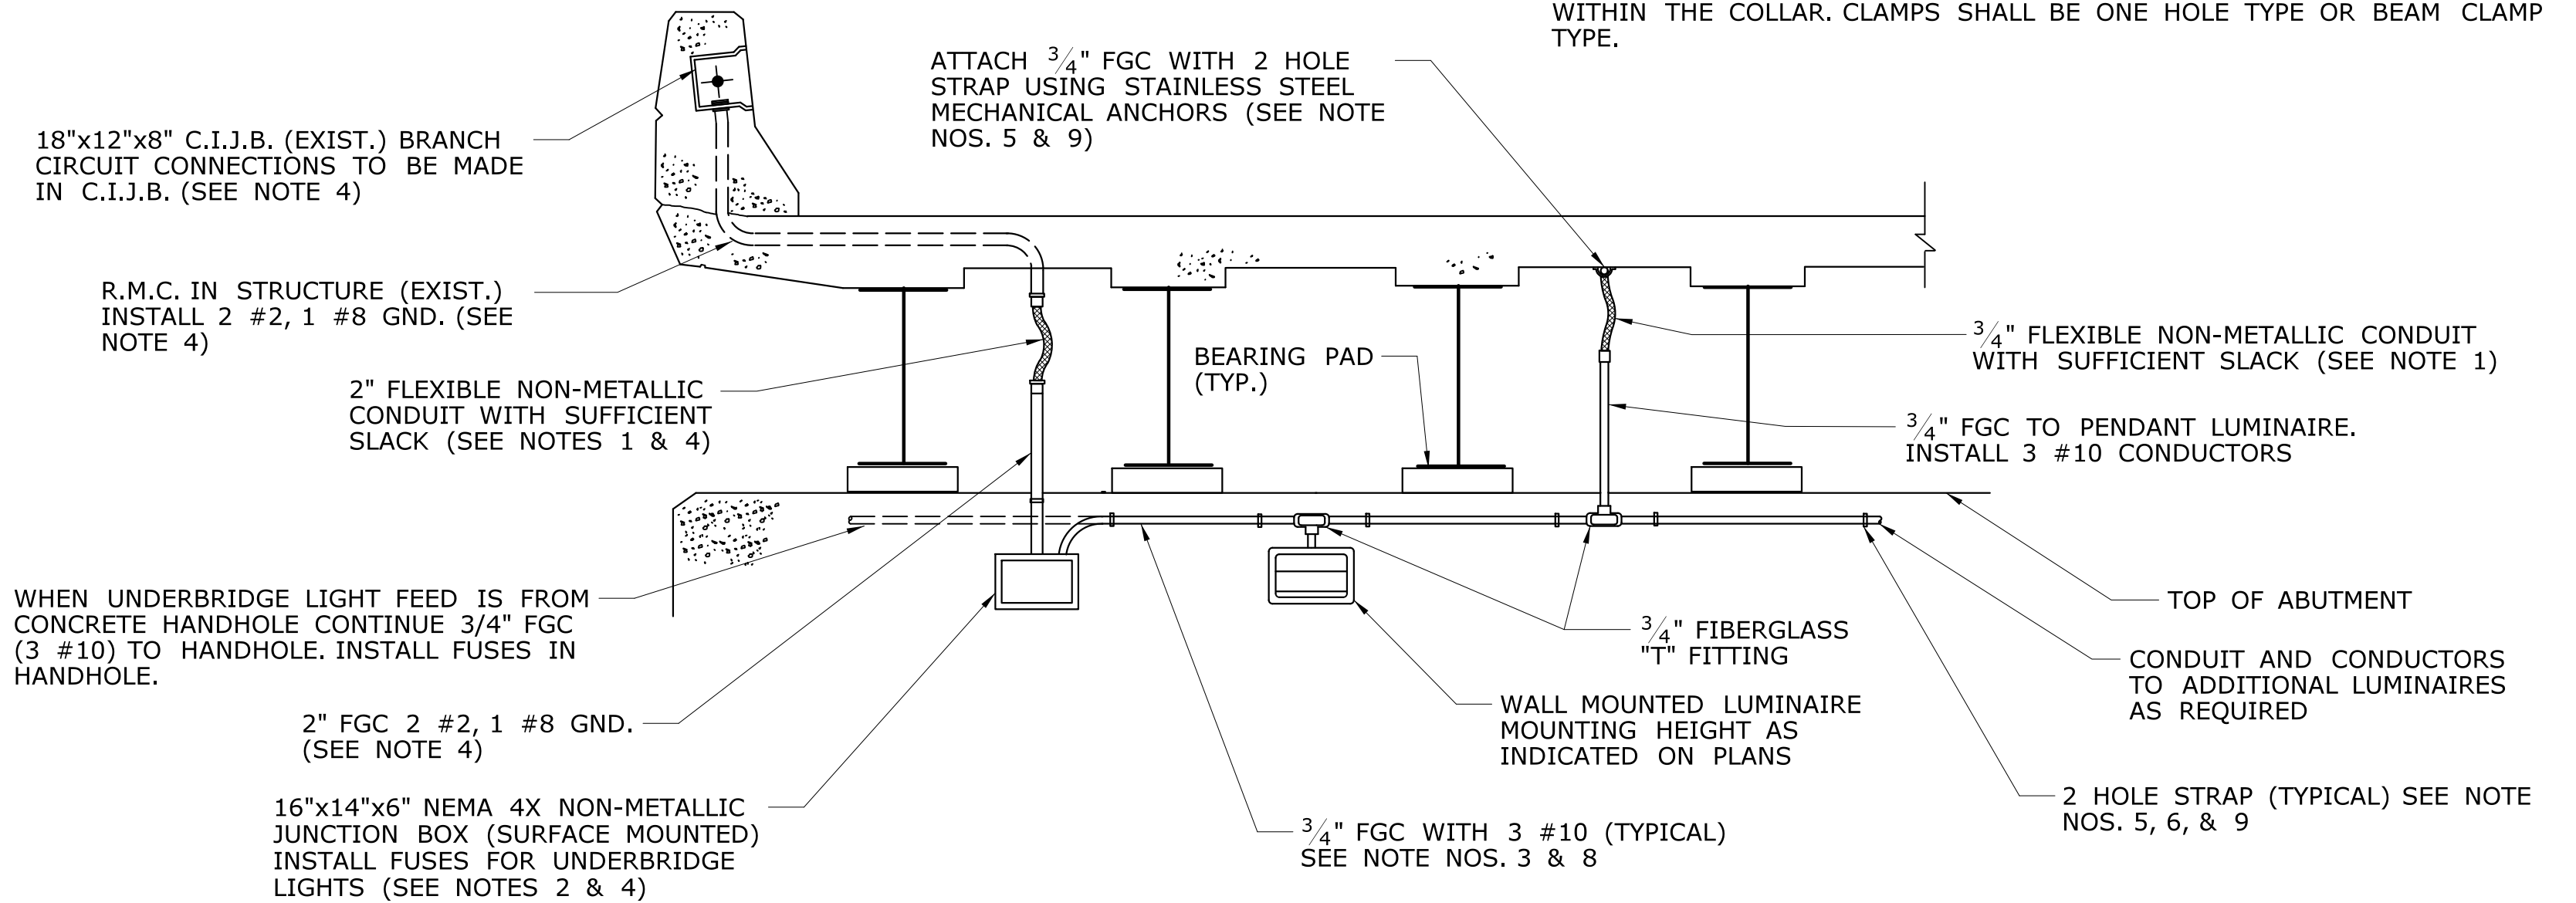

**TYPICAL LAYOUT AND FEED FOR UNDERBRIDGE LUMINAIRE, WALL OR PENDANT MOUNTED**


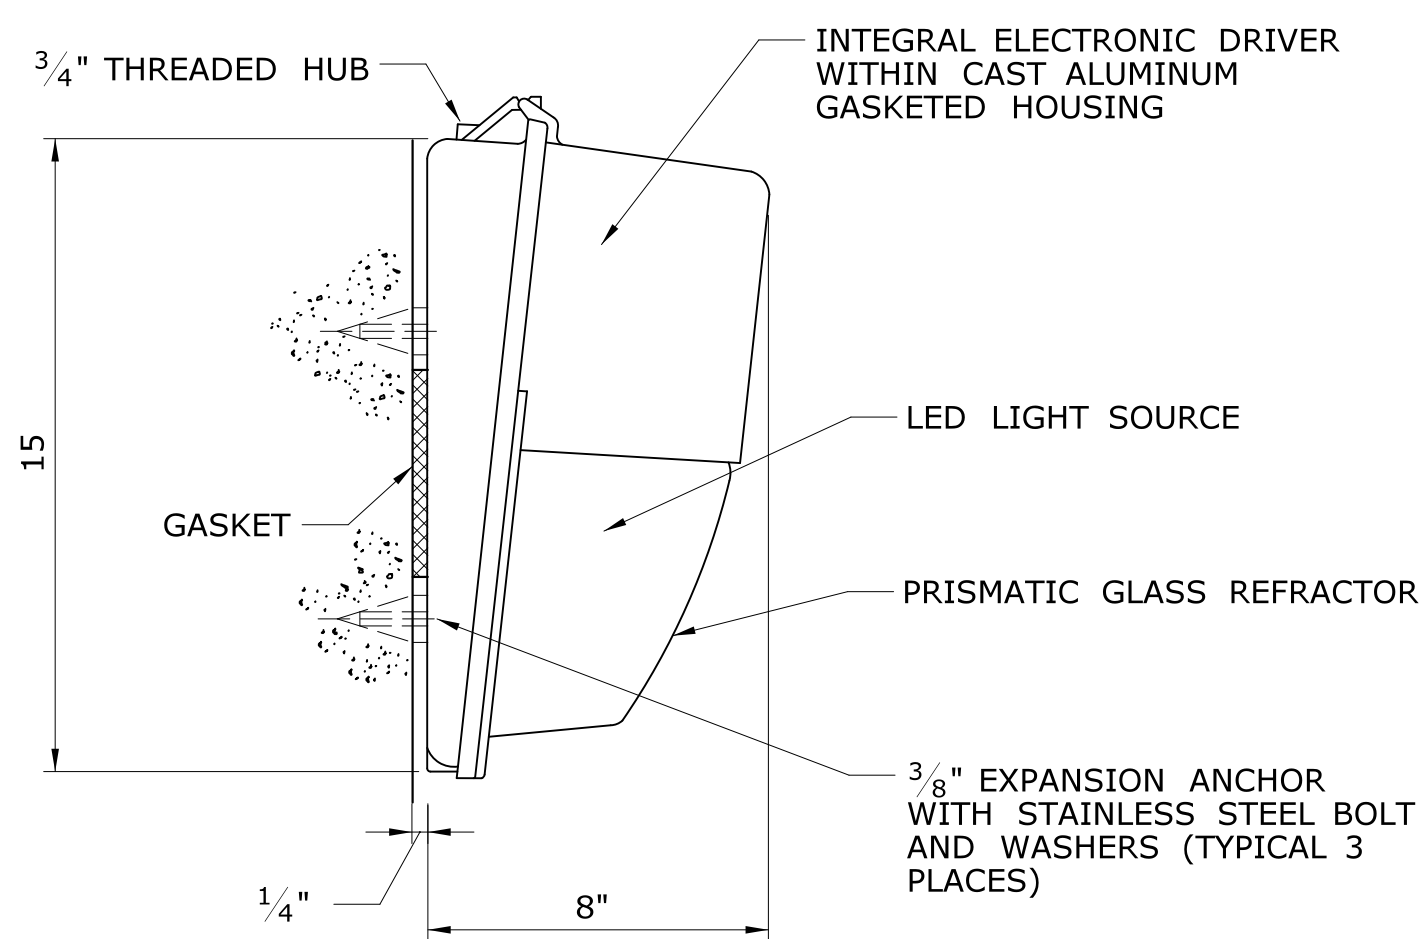


**UNDERBRIDGE LUMINAIRE (WALL MOUNTED)**



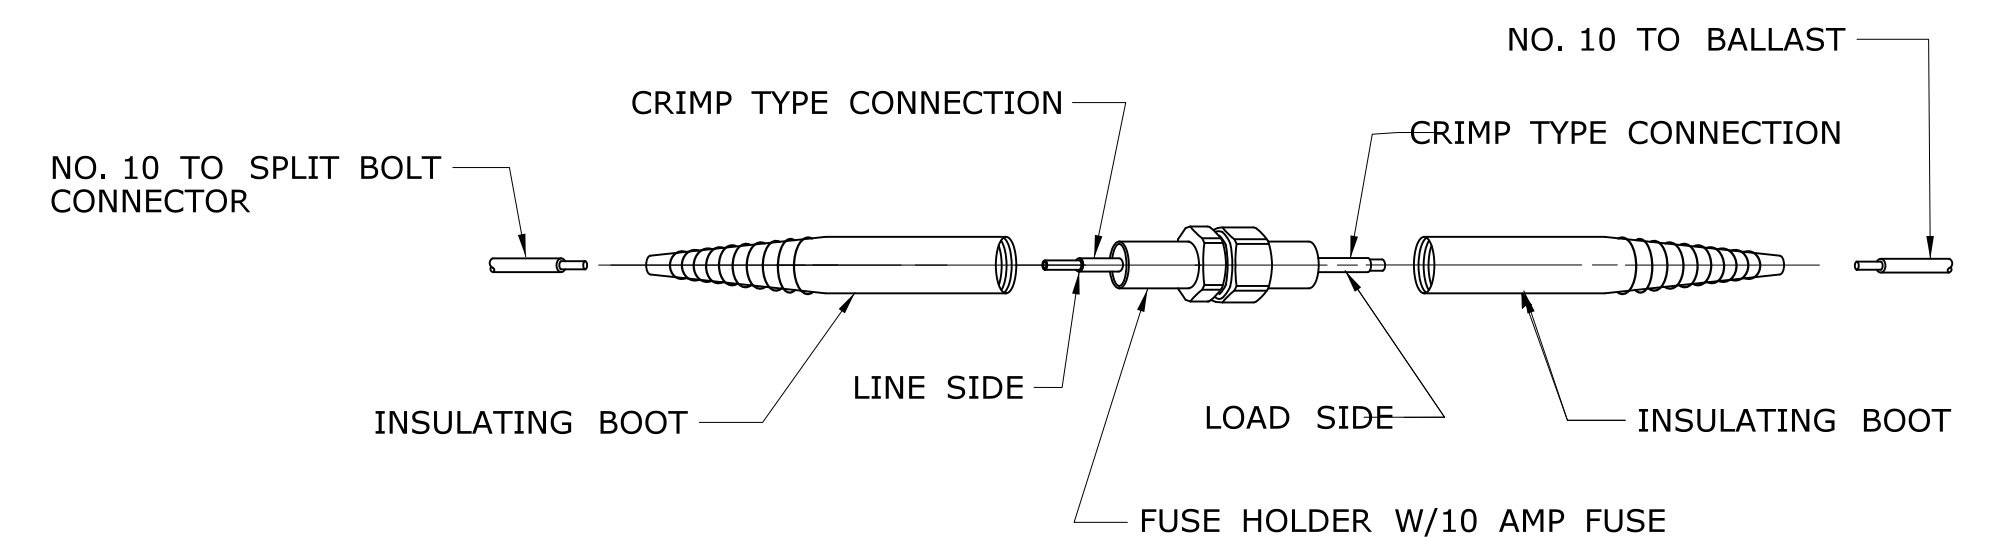


**INSULATED FUSE CONNECTOR**


<p>THE INFORMATION, INCLUDING ESTIMATED QUANTITIES OF WORK SHOWN ON THESE SHEETS IS BASED ON LIMITED INVESTIGATIONS BY THE STATE AND IS IN NO WAY WARRANTED TO INDICATE THE CONDITIONS OF ACTUAL QUANTITIES OF WORK WHICH WILL BE REQUIRED.</p>		<p>DESIGNER/DRAFTER: DDR                  CHECKED BY: MSB                  NO SCALE</p>	<p>STATE OF CONNECTICUT                  DEPARTMENT OF TRANSPORTATION</p>	<p>SIGNATURE/ BLOCK: <i>Ch...</i></p>	<p>PROJECT TITLE:  <b>RELOCATION OF I-91 NB INTERCHANGE 29 AND WIDENING OF I-91 NB AND ROUTE 5/15 NB TO I-84 EB</b></p>	<p>CITY/TOWN:  <b>HARTFORD EAST HARTFORD</b></p>	<p>PROJECT NO.  <b>63-703</b></p>
<p>REV. DATE REVISION DESCRIPTION SHEET NO. Plotted Date: 3/9/2018</p>	<p>Filename: ...VHW_MSH_0063_0703_04_07_ILL-28-UNDERBRIDGE LUMINAIRE.dgn</p>	<p>NO SCALE</p>	<p>Signature: <i>Ch...</i></p>	<p>PROJECT TITLE:  <b>RELOCATION OF I-91 NB INTERCHANGE 29 AND WIDENING OF I-91 NB AND ROUTE 5/15 NB TO I-84 EB</b></p>	<p>CITY/TOWN:  <b>HARTFORD EAST HARTFORD</b></p>	<p>PROJECT NO.  <b>63-703</b></p>	
				<p>DRAWING TITLE:  <b>UNDERBRIDGE LUMINAIRE</b></p>		<p>DRAWING NO.  <b>ILL-28</b></p>	
				<p>SHEET NO.  <b>01.11.02.28</b></p>			

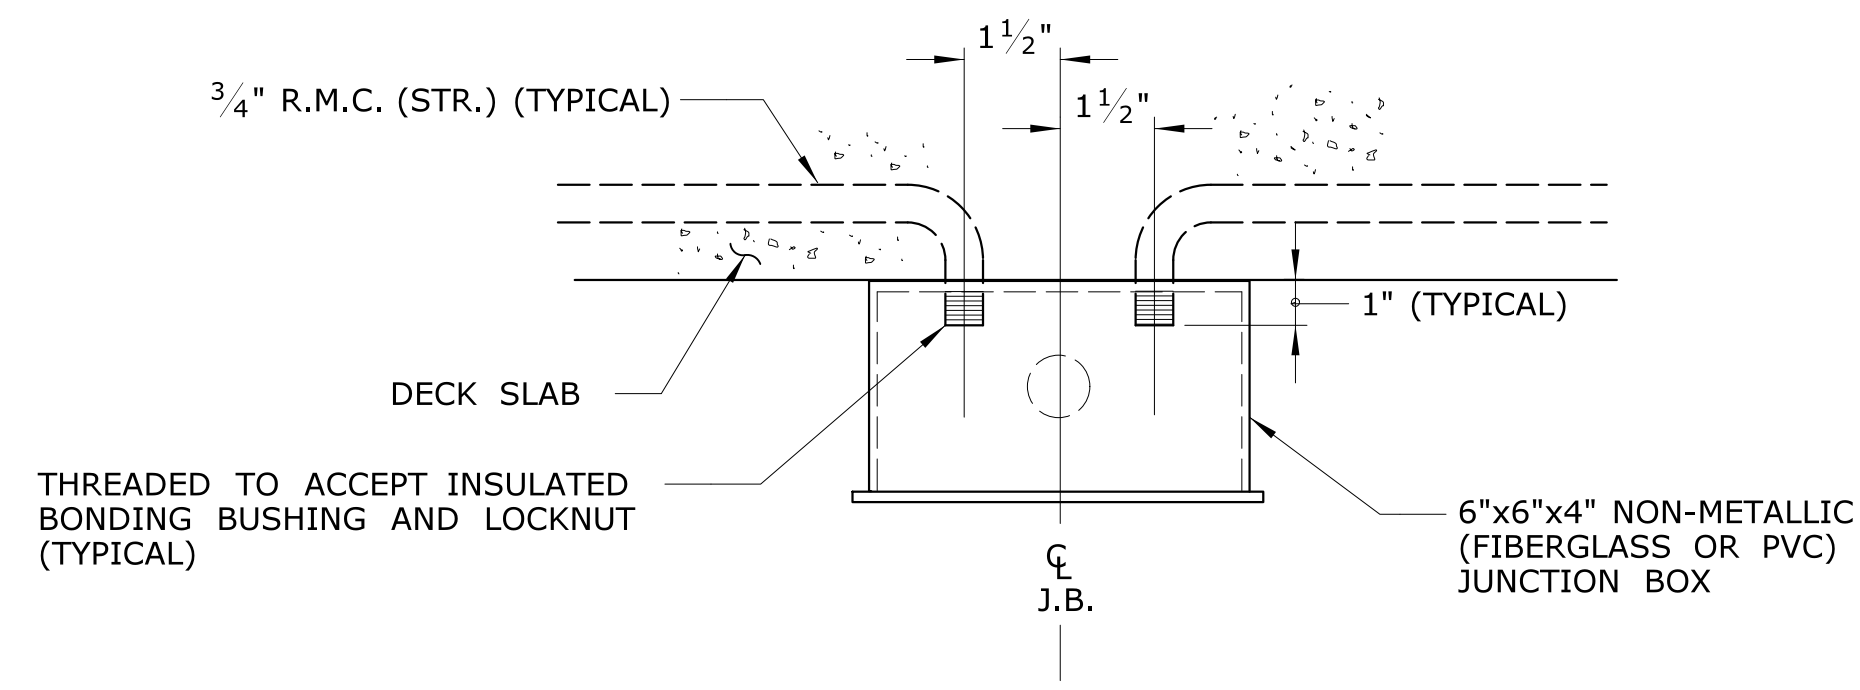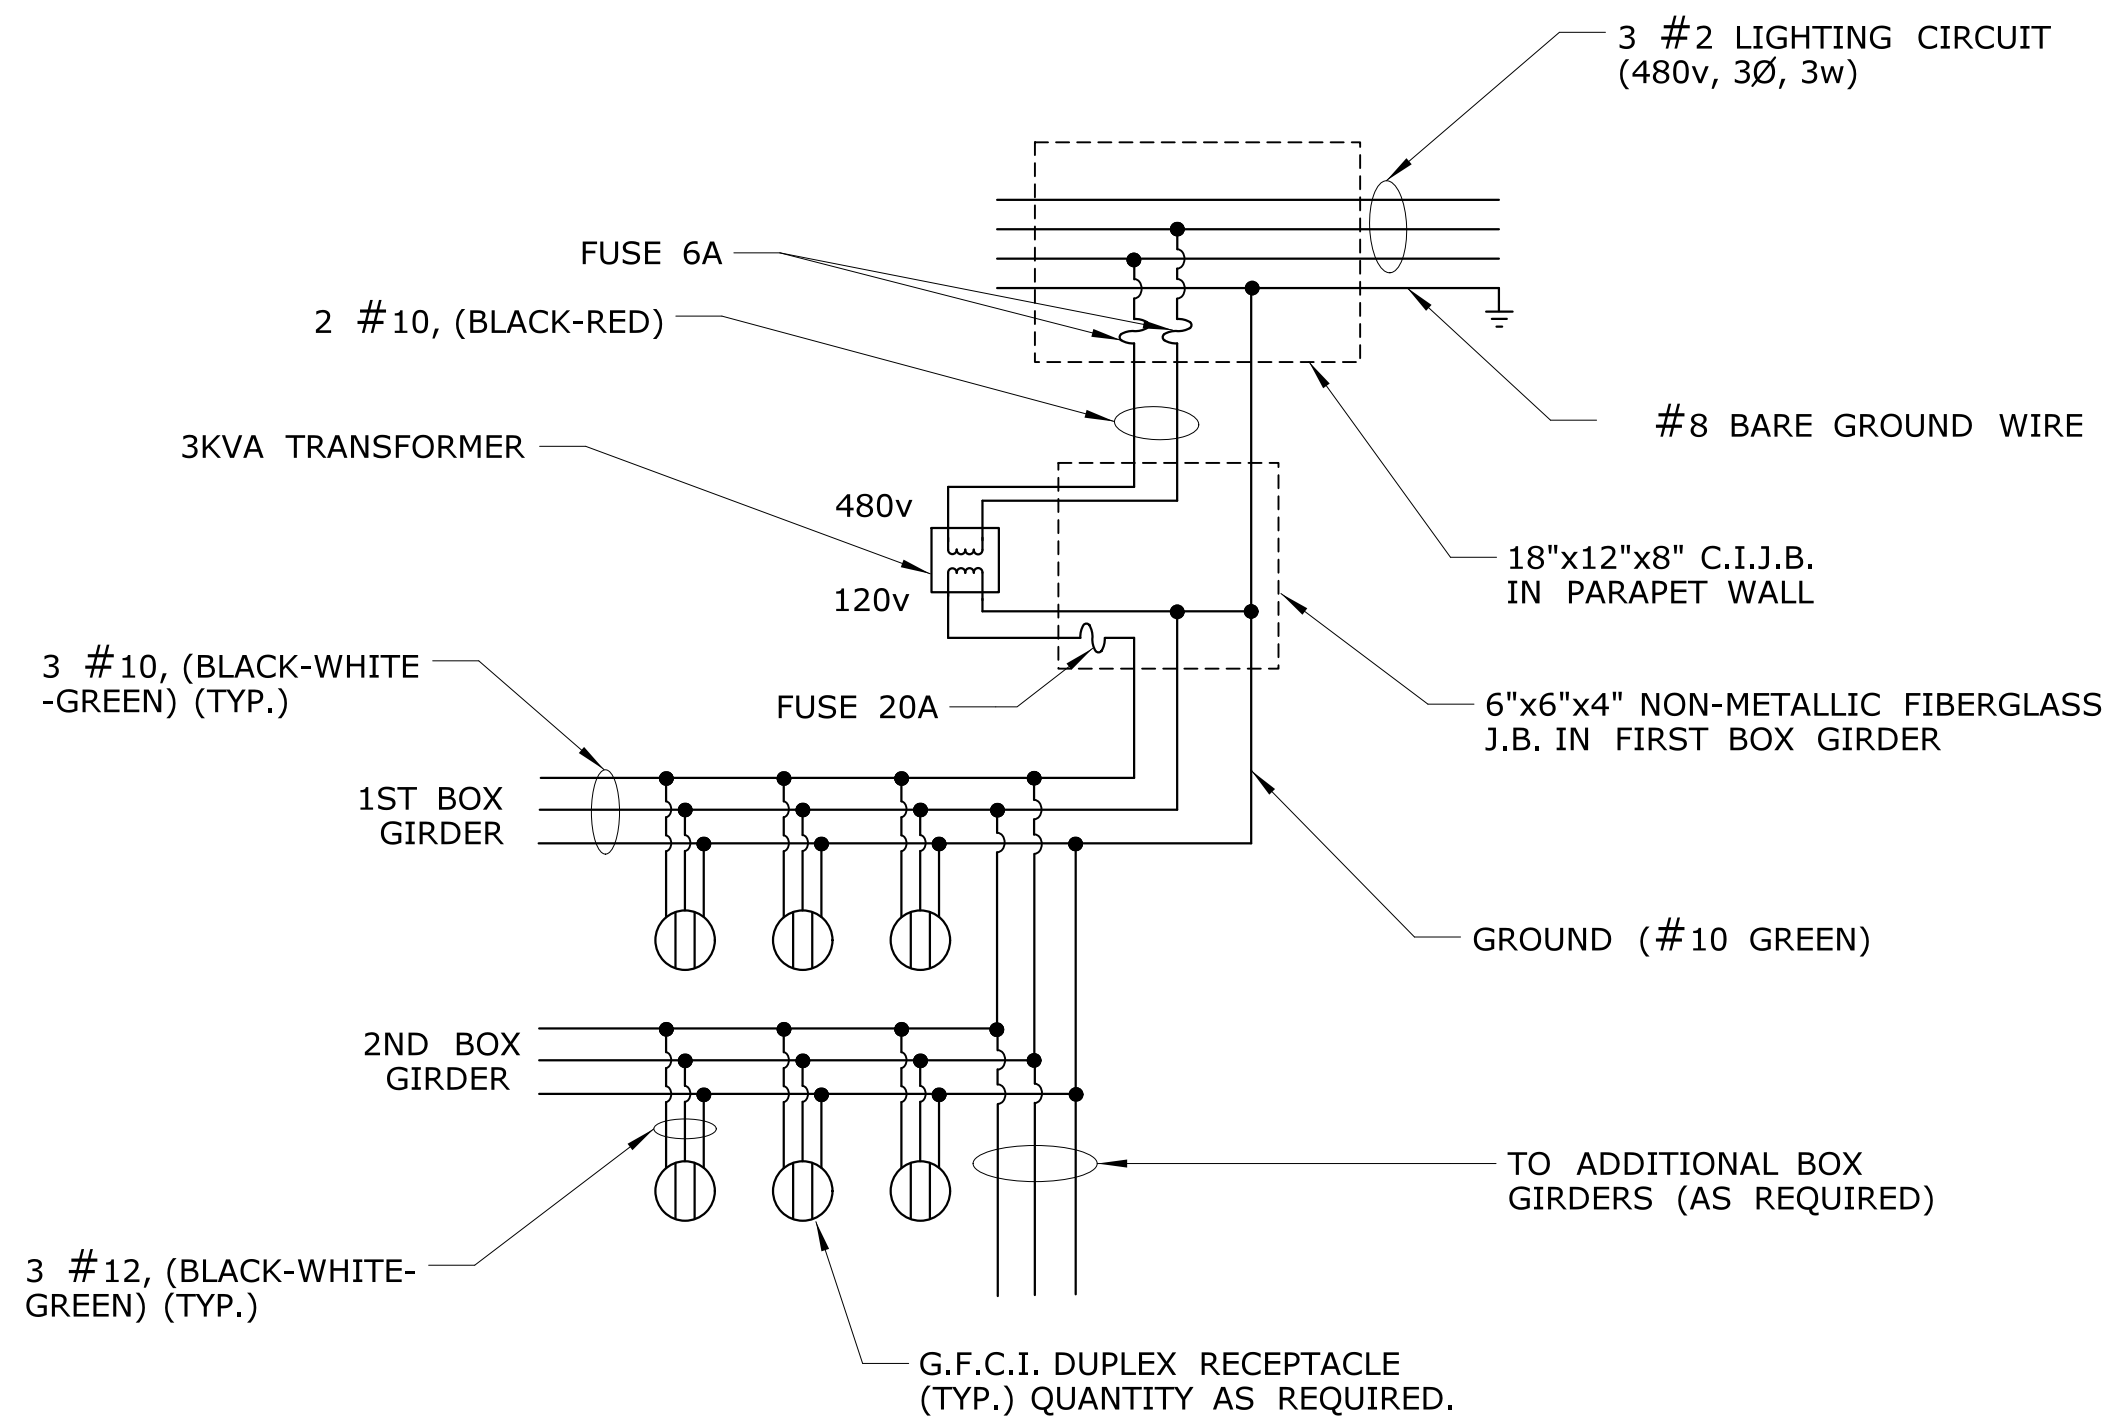


- NOTES:
- 1) LATERAL PLACEMENT OF CONDUIT CAN BE ADJUSTED TO AVOID OBSTRUCTIONS.
  - 2) 3/4" FLEXIBLE NON-METALLIC CONDUIT SHALL BE USED AT ALL LOCATIONS SUBJECT TO MOVEMENT OR EXPANSION.
  - 3) 3/4" FIBERGLASS CONDUIT SHALL BE STANDARD WALL TYPE (0.070" WALL THICKNESS).
  - 4) FOR FIBERGLASS CONDUIT LENGTHS OVER 50', THE CONTRACTOR SHALL INSTALL A CONDUIT EXPANSION FITTING. EXPANSION FITTINGS SHALL BE INSTALLED IN STRICT CONFORMANCE WITH MANUFACTURER'S GUIDELINES.
  - 5) SUPPORT SPACING OF FIBERGLASS CONDUIT SHALL NOT EXCEED 3'-0" AS PER N.E.C. 355.30.
  - 6) WHERE FIBERGLASS CONDUIT IS FIELD CUT, THE OUTSIDE SURFACE OF THE CUT END SHALL BE SANDED TO REMOVE THE RESIN GLAZE PRIOR TO APPLYING ADHESIVE.

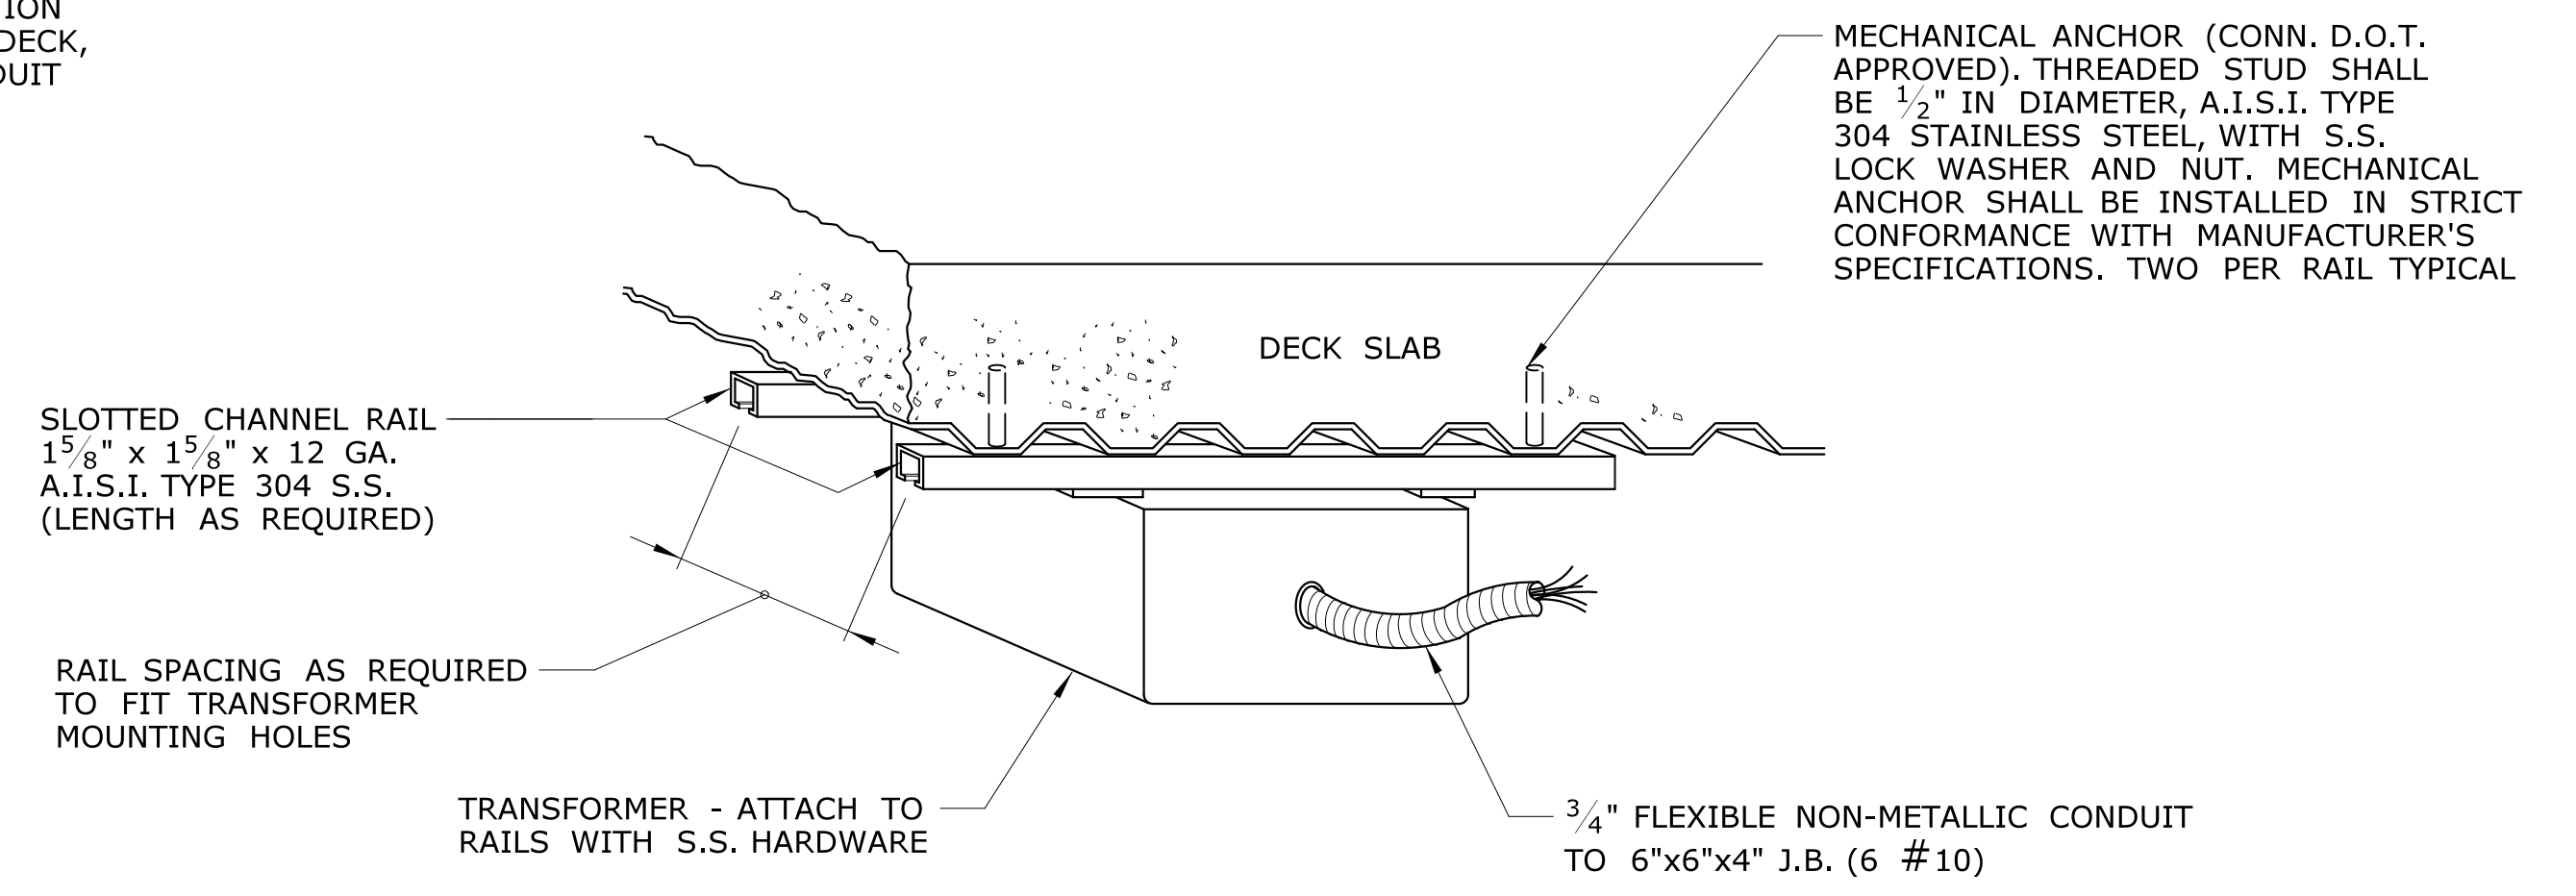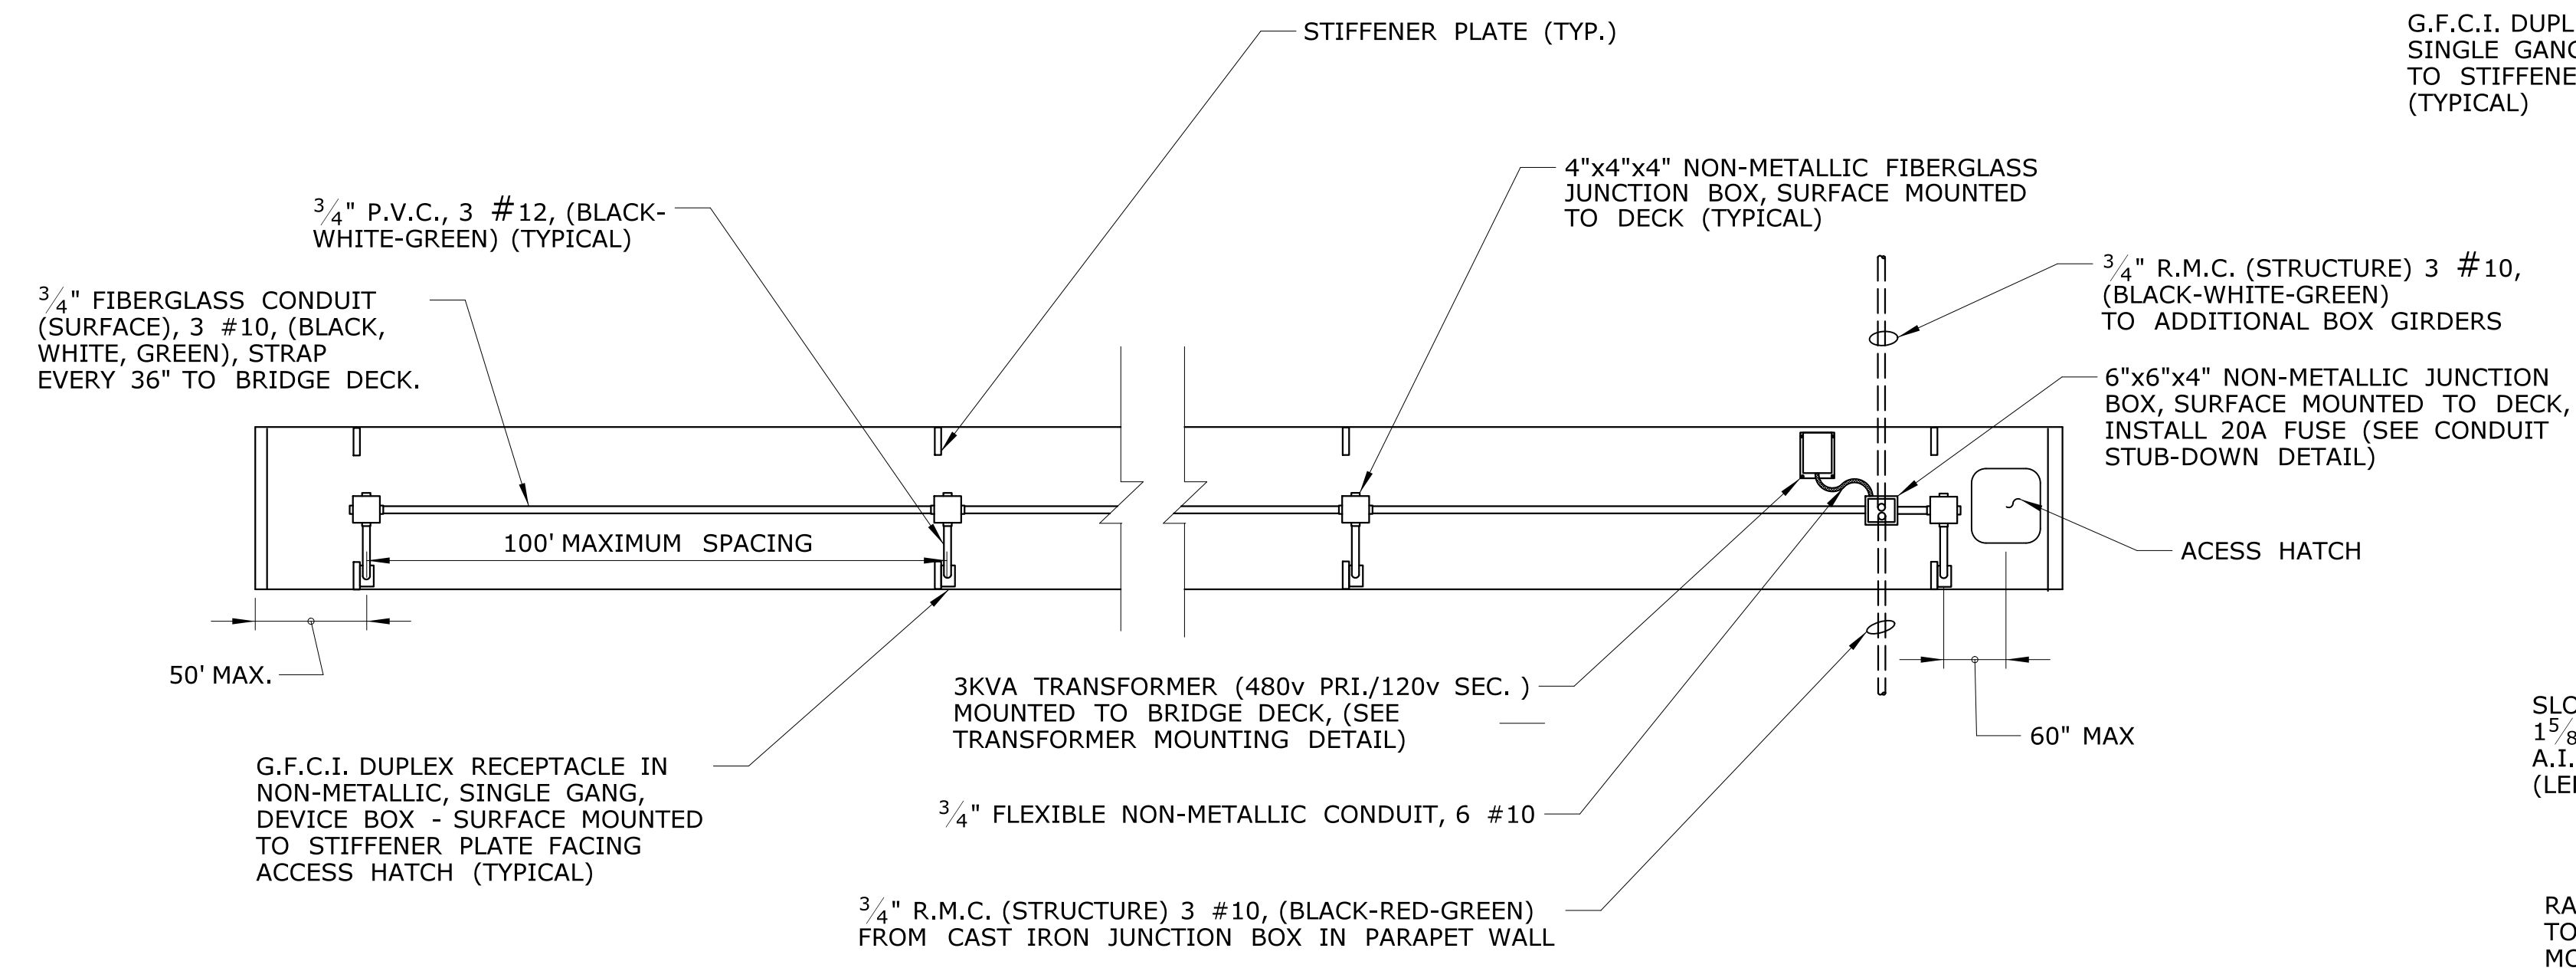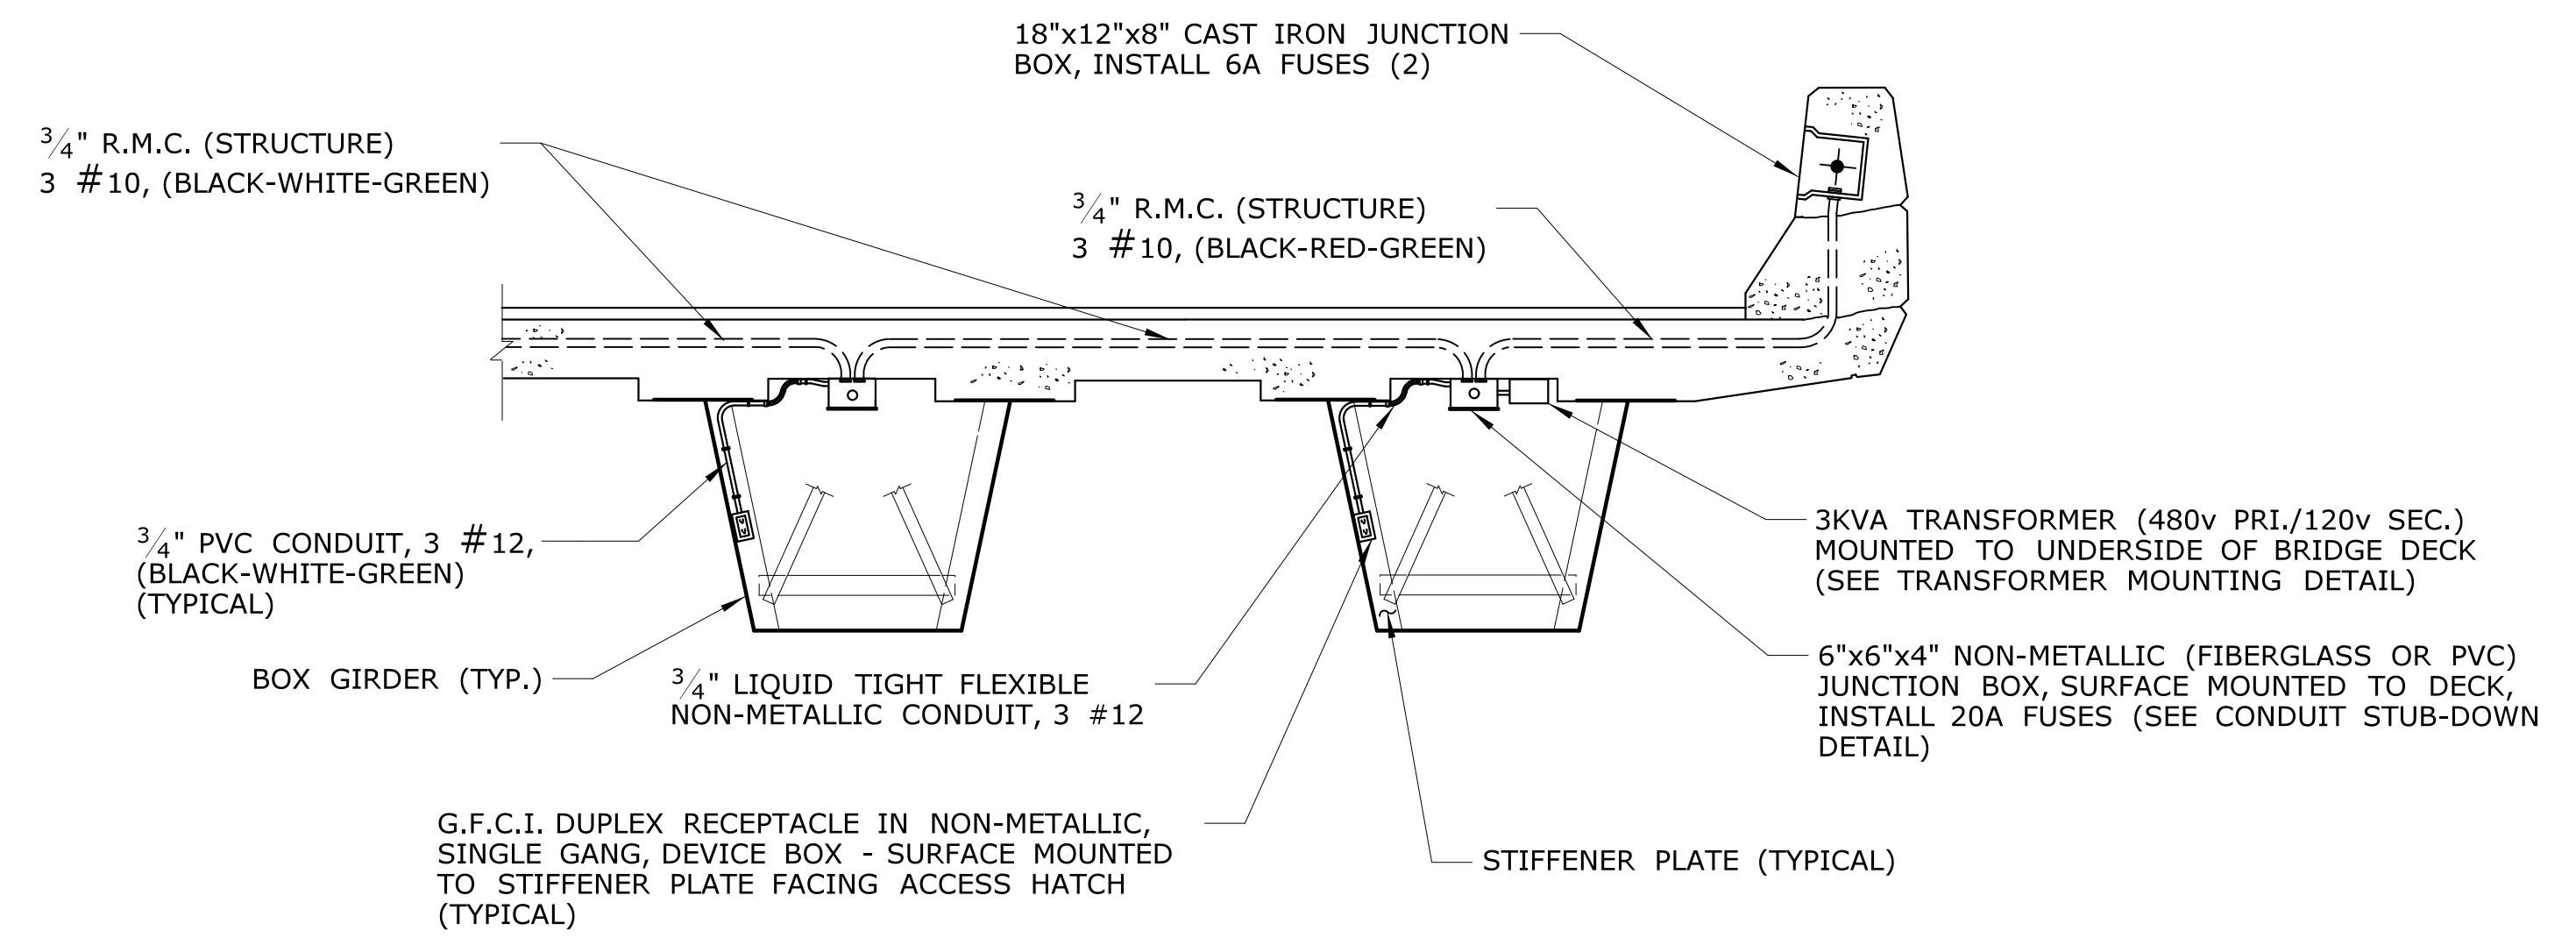



DESIGNER/DRAFTER: MSB		<p>STATE OF CONNECTICUT DEPARTMENT OF TRANSPORTATION</p>	SIGNATURE/BLOCK: <b>OFFICE OF ENGINEERING</b> APPROVED BY: <i>Chapman</i> DATE ISSUED: 1/1/2017	PROJECT TITLE: <b>RELOCATION OF I-91 NB INTERCHANGE 29 AND WIDENING OF I-91 NB AND ROUTE 5/15 NB TO I-84 EB</b>	TOWN: <b>HARTFORD EAST HARTFORD</b>	PROJECT NO. <b>63-703</b> DRAWING NO. <b>ILL-29</b> SHEET NO. 01.11.02.29
CHECKED BY: JA						
REV.	DATE	REVISION DESCRIPTION	SHEET NO.	Plotted Date: 3/9/2018		

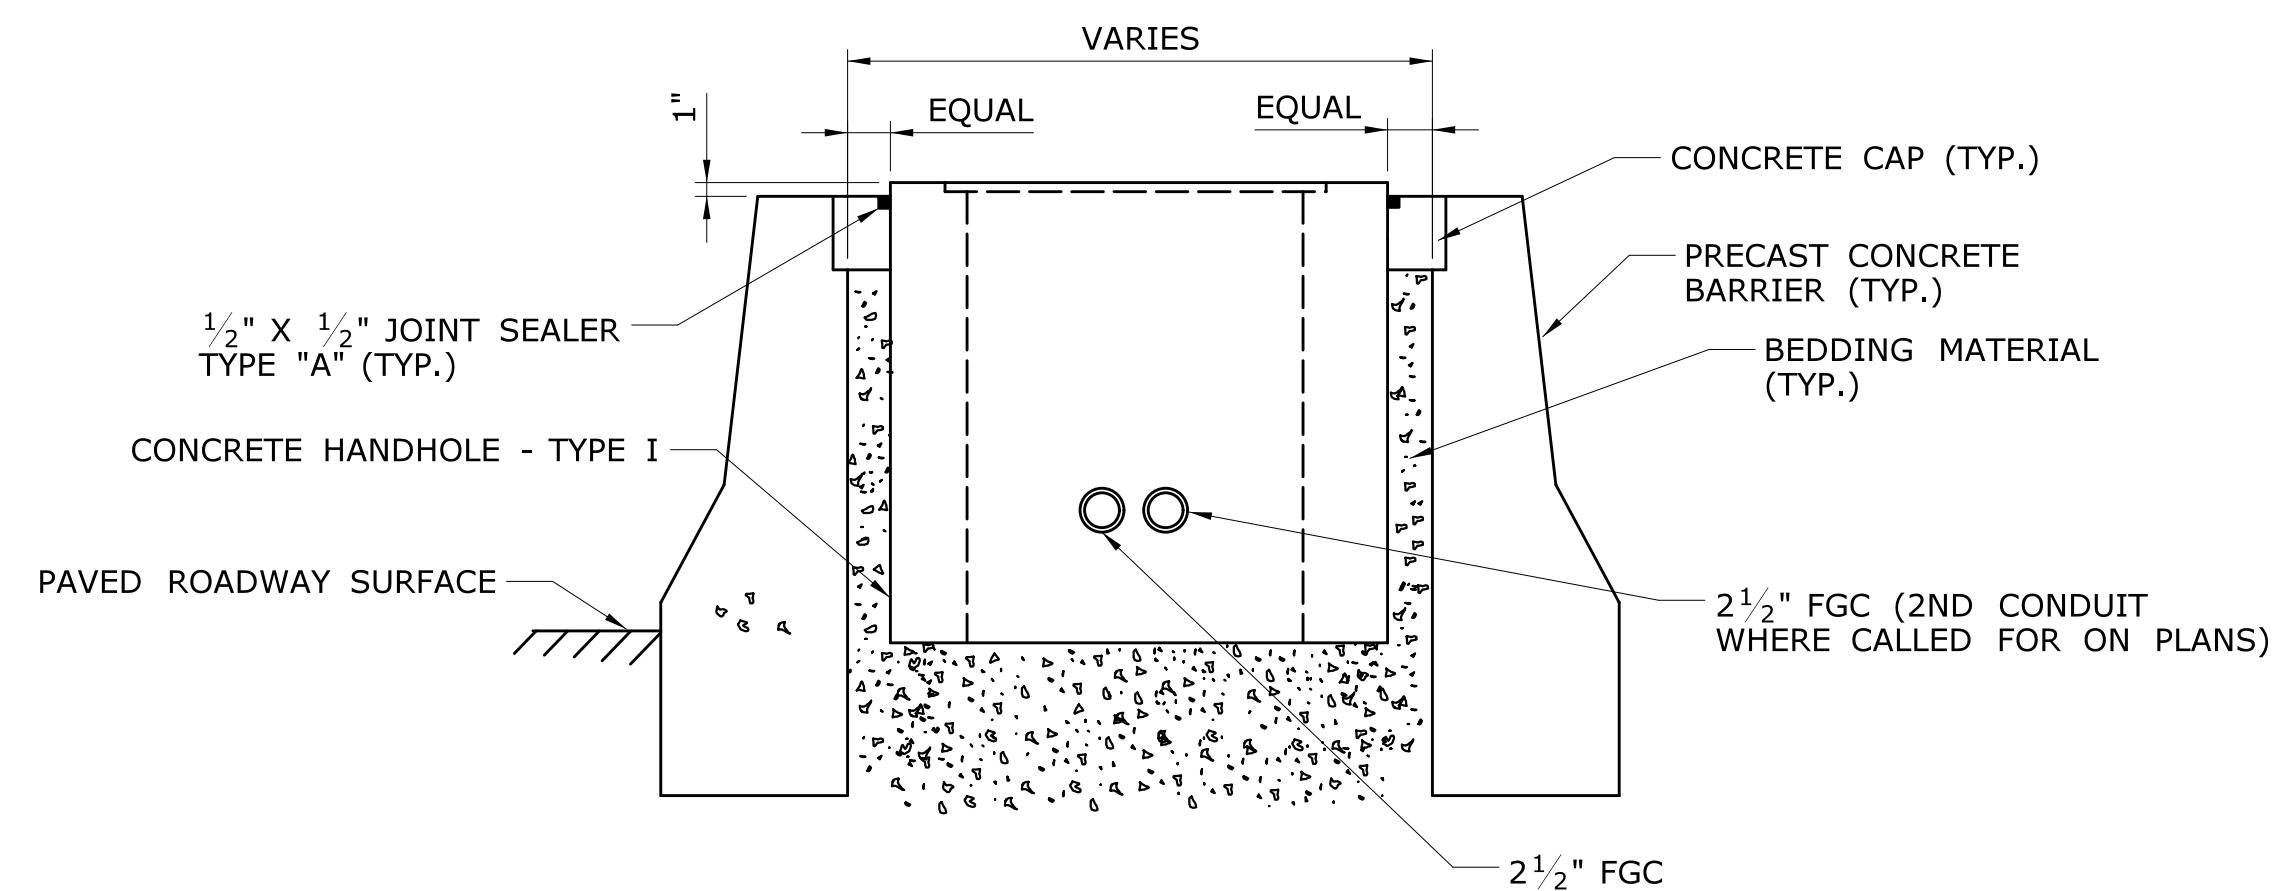

**CONCRETE HANDHOLE IN MEDIAN**

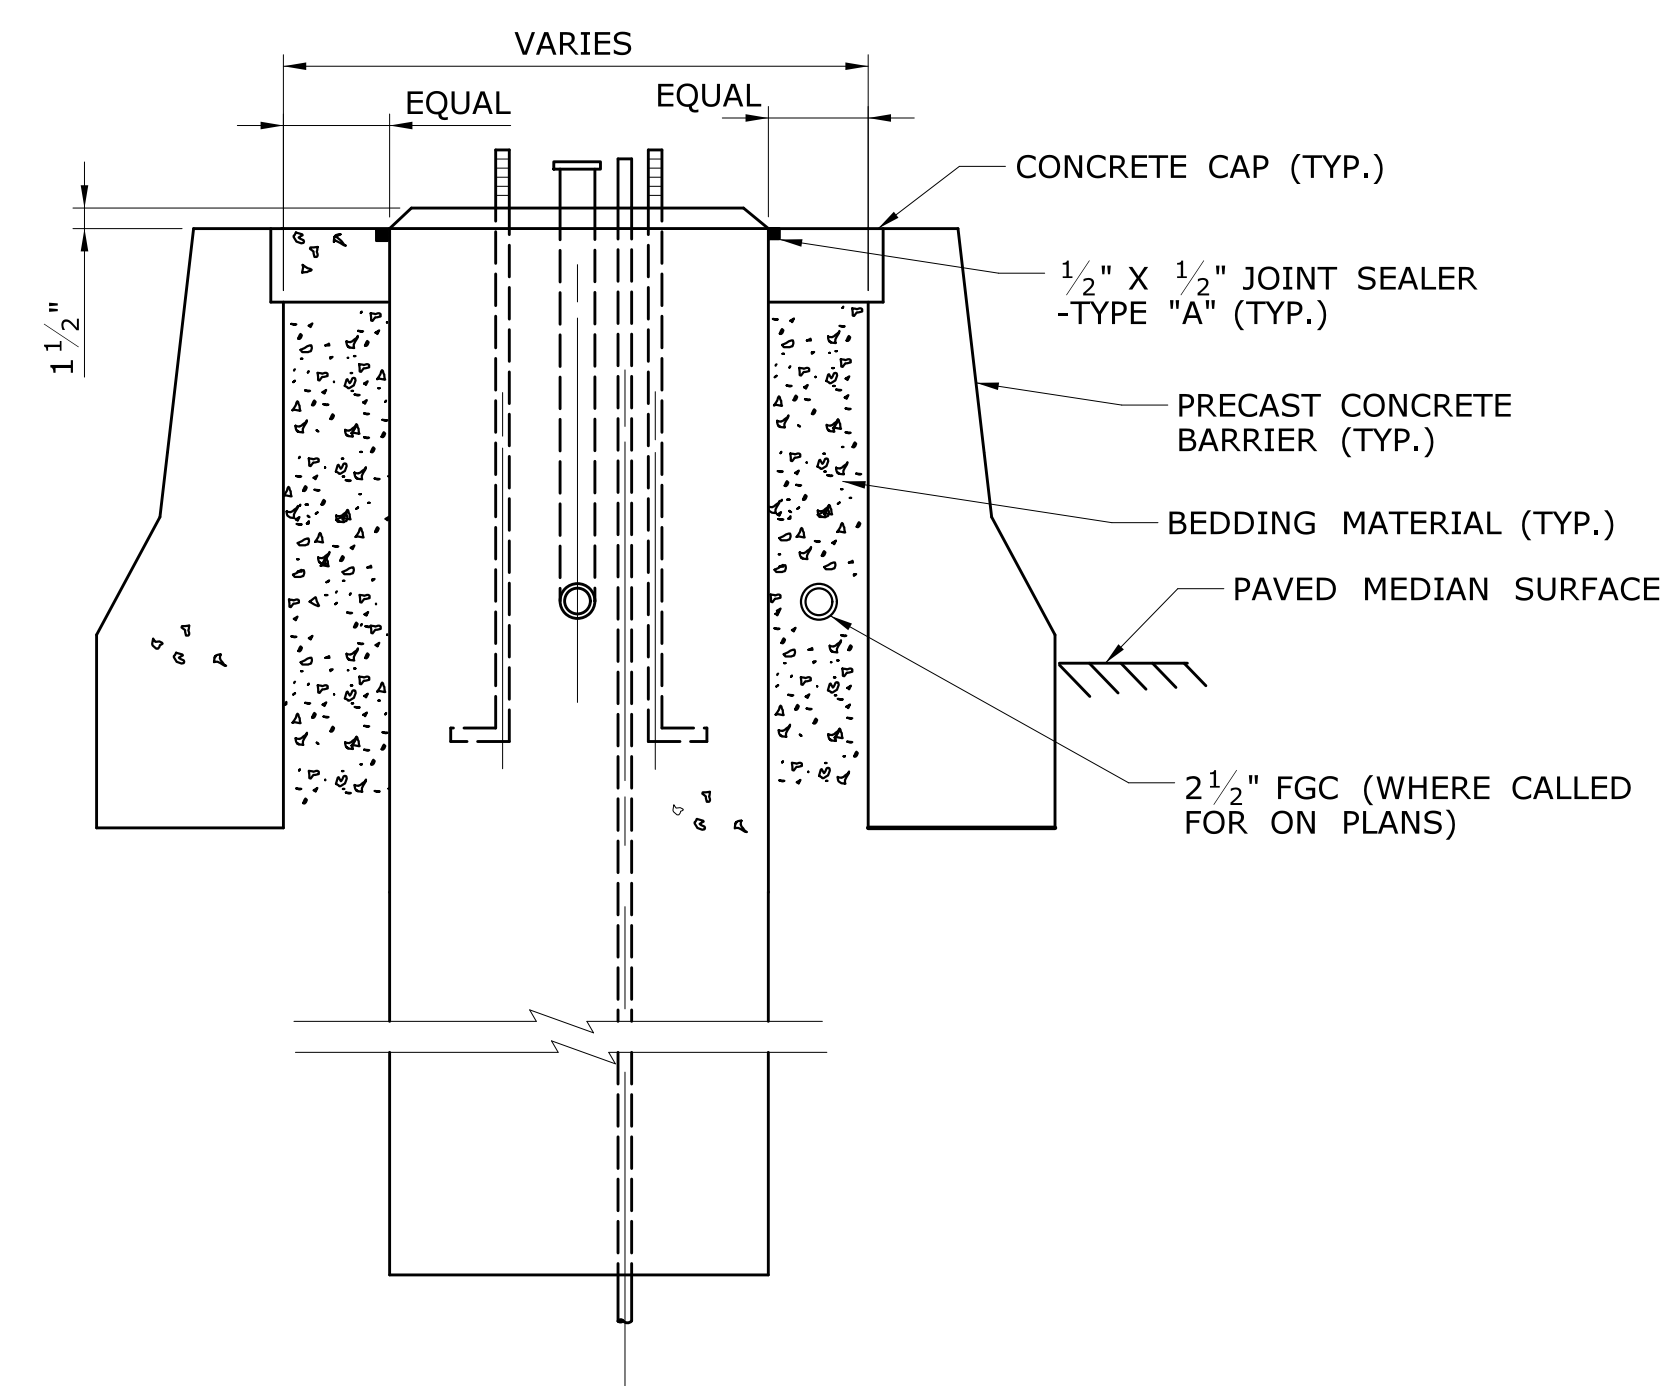

**LIGHT STANDARD FOUNDATION IN MEDIAN**

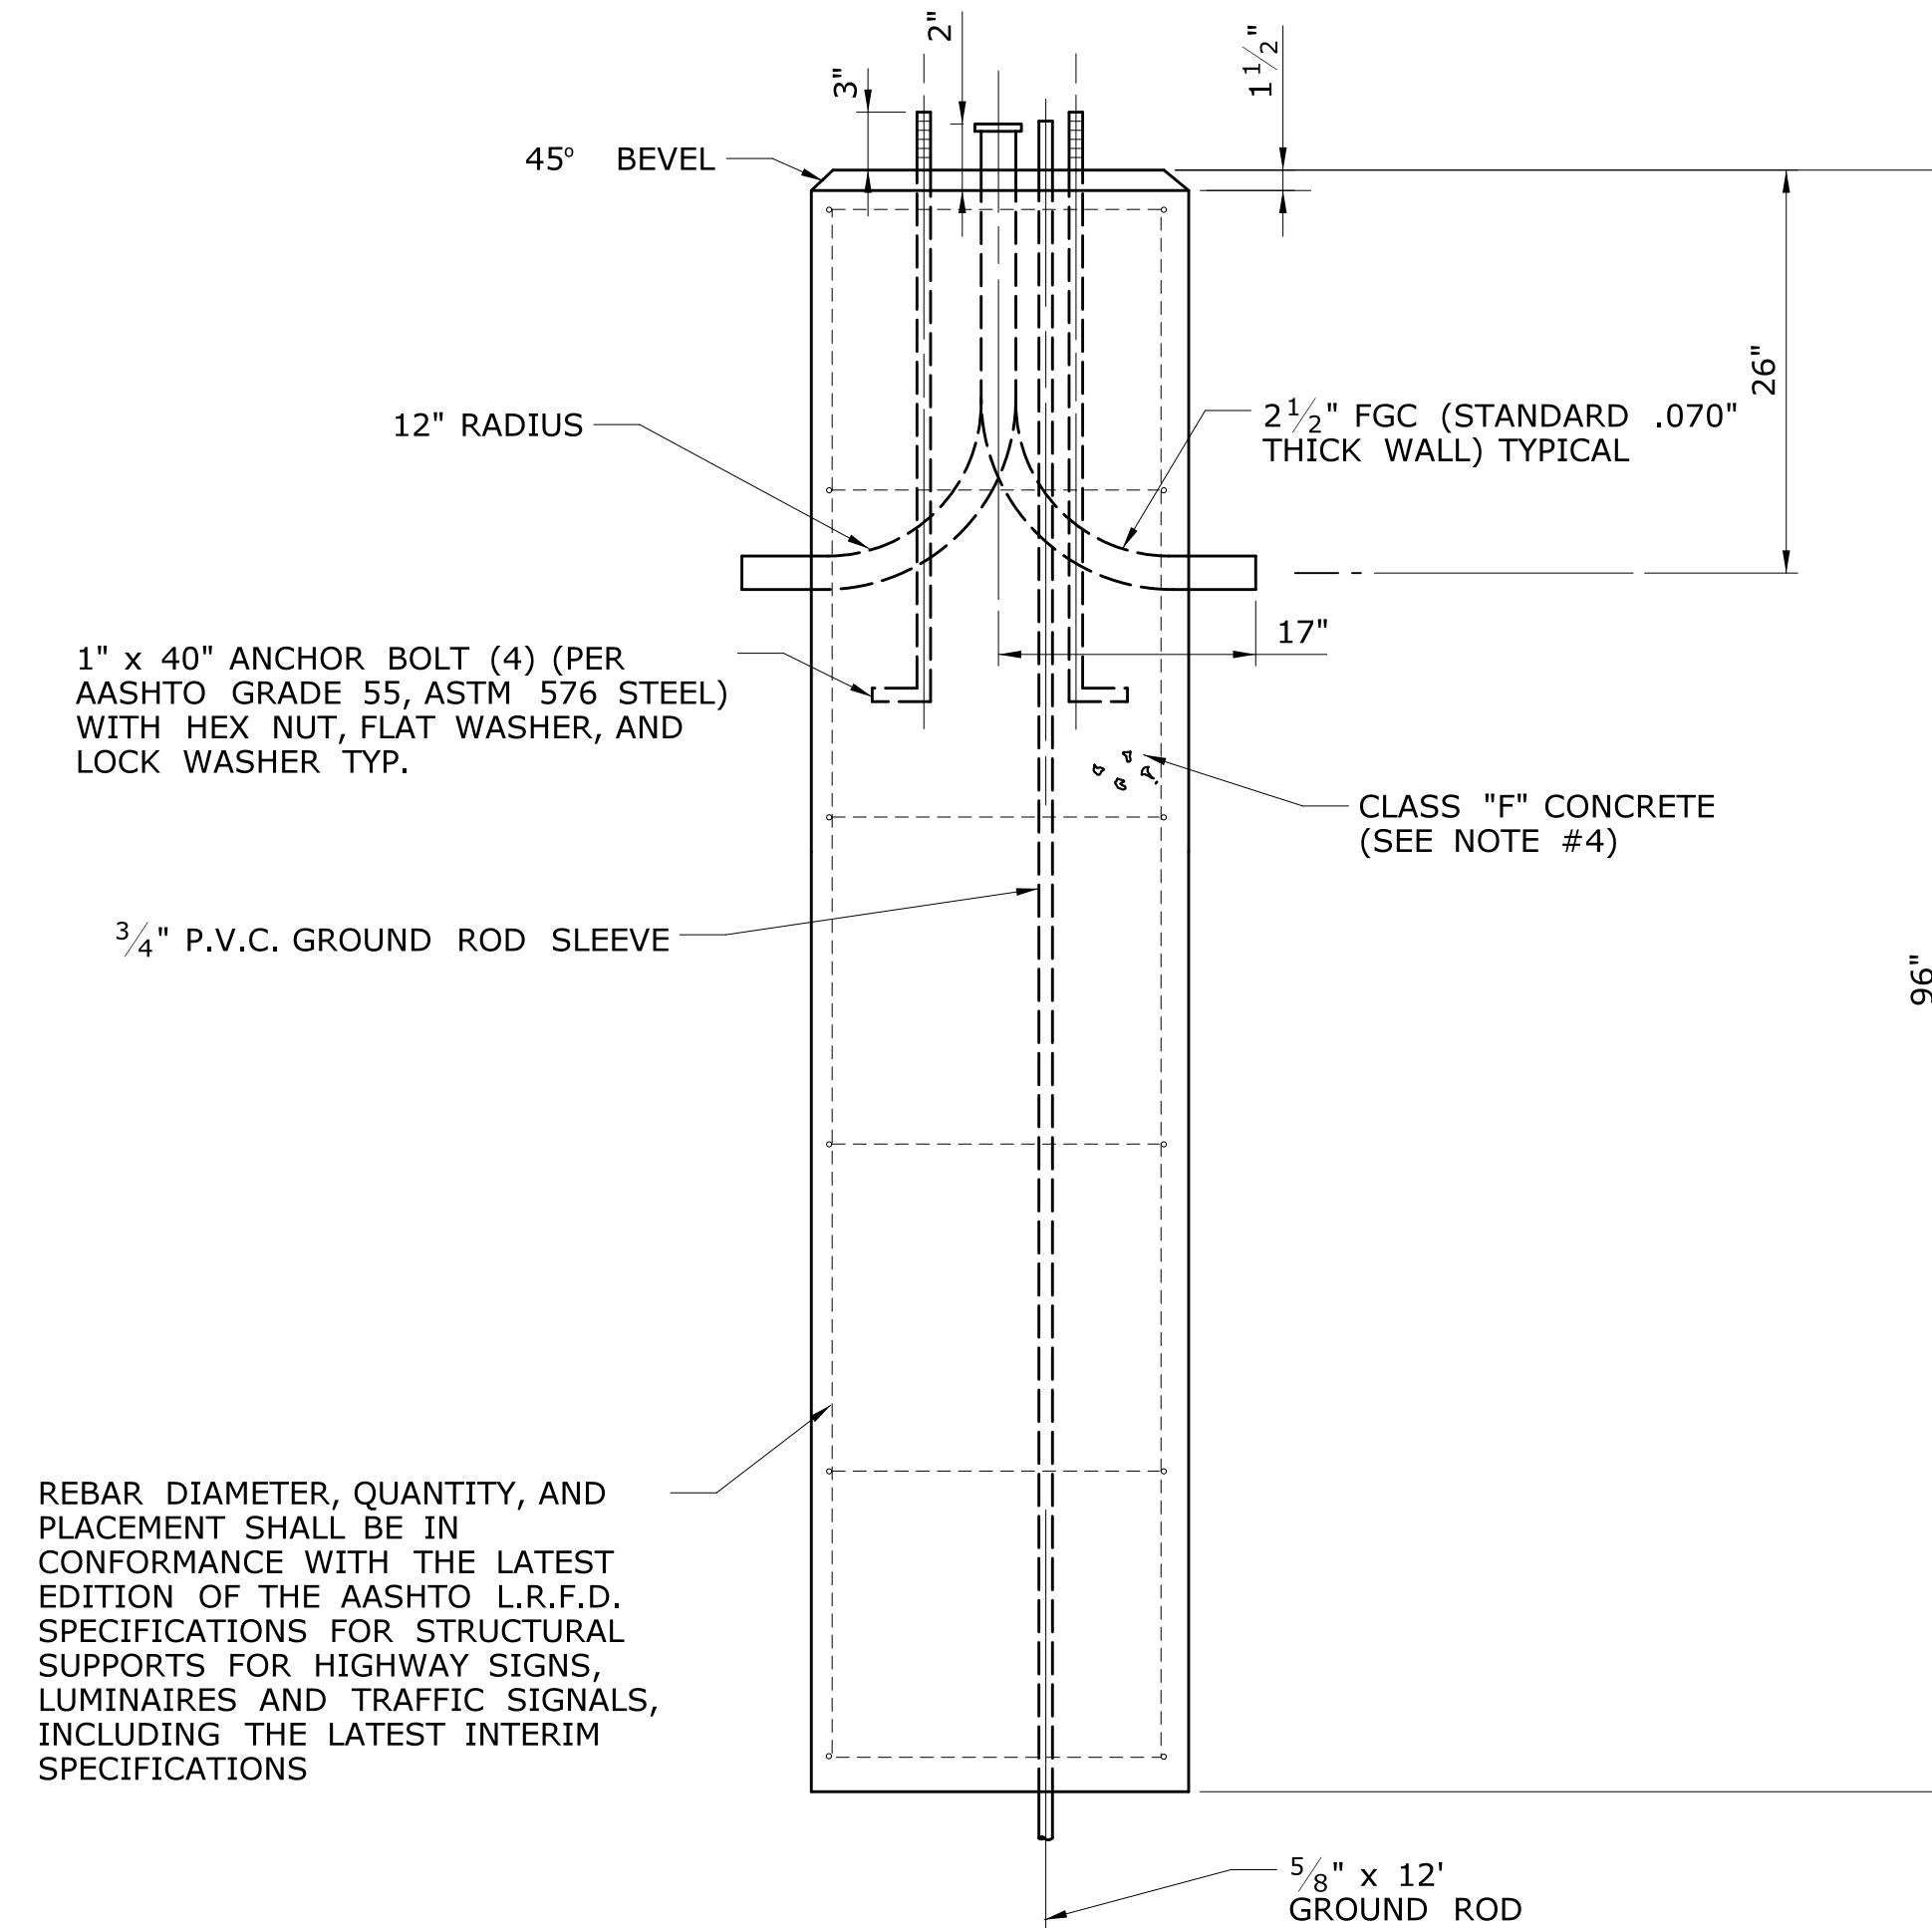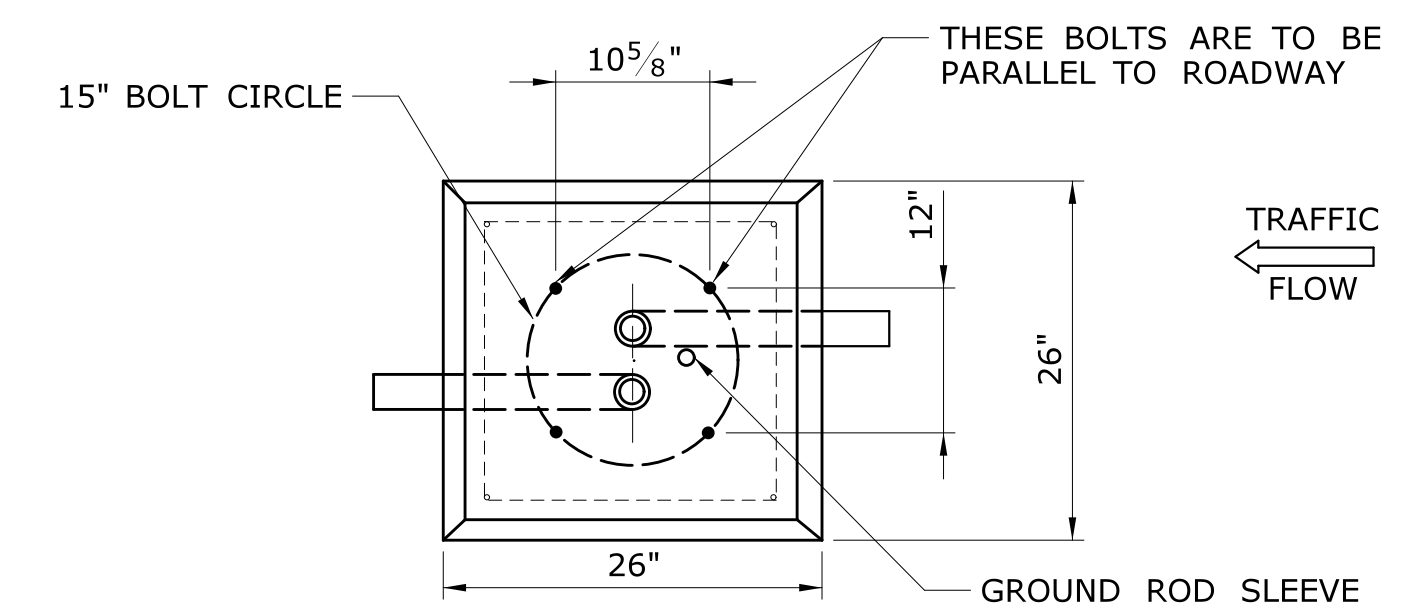

**LIGHT STANDARD FOUNDATION - TYPE III**

**NOTES:**

- 1) FIBERGLASS CONDUIT (FGC) SWEEPS SHALL BE STANDARD WALL (.070" WALL THICKNESS) TYPE.
- 2) FIBERGLASS CONDUIT IN MEDIAN FILL SHALL HAVE INTERFERENCE JOINTS PERMANENTLY BONDED WITH ADHESIVE.
- 3) FIBERGLASS CONDUIT ENTERING A CONCRETE HANDHOLE SHALL BE TERMINATED WITH A BELL END.
- 4) FOUNDATION TO BE PRE-CAST.

THE INFORMATION, INCLUDING ESTIMATED QUANTITIES OF WORK, SHOWN ON THESE SHEETS IS BASED ON LIMITED INVESTIGATIONS BY THE STATE AND IS IN NO WAY WARRANTED TO INDICATE THE CONDITIONS OF ACTUAL QUANTITIES OF WORK WHICH WILL BE REQUIRED.		DESIGNER/DRAFTER: MSB CHECKED BY: JA NO SCALE	<b>STATE OF CONNECTICUT</b> <b>DEPARTMENT OF TRANSPORTATION</b>	SIGNATURE/ BLOCK: 	PROJECT TITLE: <b>RELOCATION OF I-91 NB INTERCHANGE 29 AND WIDENING OF I-91 NB AND ROUTE 5/15 NB TO I-84 EB</b>	CITY/TOWN: <b>HARTFORD EAST HARTFORD</b>	PROJECT NO. <b>63-703</b> DRAWING NO. <b>ILL-30</b> SHEET NO. 01.11.02.30
REV.	DATE	REVISION DESCRIPTION	SHEET NO.	Plotted Date: 3/21/2018	Filename: ...VHW_MSH_0063-0703_04-07_ILL-30-MEDIAN FOUNDATION.dgn		